

DOOR SCHEDULE														REMARKS	
DOOR NUMBER	DOOR			FRAME					MISCELLANEOUS						
	SIZE WIDTH HEIGHT	DOOR TYPE	# OF LEAVES	DOOR MATL	DOOR THICKN	FRAME TYPE	FRAME MATERIAL	MULLION	JAMB	HEAD	THRESHOLD		H/W SET		GLASS
007	3'-9"	7'-8"	D-1	2	FRP	1-3/4"	F-1	ALUM	-	J-1	H-1	T-1	11"	-	* FLUSH PULL FF63 INTEGRAL WITH DOOR BY DOOR MANUFACTURE
08	2'-11"	7'-0"	D-2	2	FRP	1-3/4"	F-2	ALUM	FIXED	J-2	H-2	T-1	7.1	GL-1	
09	3'-0"	7'-0"	D2	2	FRP	1-3/4"	F-3	ALUM	REMOVABLE	J-2	H-2	T-1	7	GL-1	
12	3'-0"	7'-0"	D2	2	FRP	1-3/4"	F-3	ALUM	REMOVABLE	J-2	H-2	T-1	7	GL-1	REFER TO CONCRETE SILL DETAIL #10

- DOOR SCHEDULE NOTES:**
- (E) STEEL LINTELS ABOVE OPENING TO BE SCRAPED, CLEANED, PRIMED & PAINTED
 - DOOR & FRAME TO RECEIVE ELECTRICAL POWER TRANSFER FOR FUTURE CARD ACCESS - SEE HARDWARE SCHEDULE. CONTRACTOR TO TERMINATE CONTROL WIRING AND COIL ABOVE CEILING FOR FUTURE CONNECTION TO OWNER PROVIDED POWER SUPPLY.
 - PROVIDE HEAD & JAMB ANGLE TRIM AT FRAME EXTERIOR TO MATCH NEW FRAME.

GLAZING SCHEDULE
GL-1: 1" INSULATED, LAMINATED, TINTED (EVERGREEN), SAFETY GLAZING

LEGEND

- | | |
|--------|---------------------------------|
| ALUM | ALUMINUM |
| (E) | EXISTING TO REMAIN |
| (ER) | EXISTING RELOCATED |
| FRP | FIBERGLASS REINFORCED POLYESTER |
| (R) | REMOVE EXISTING |
| (RE) | RELOCATE EXISTING |
| V.I.F. | VERIFY IN FIELD |

GENERAL DOOR / FRAME NOTES:

- DEMOLISH (E) FRAME & DOOR SYSTEMS IN THEIR ENTIRETY AT ALL LOCATIONS TO RECEIVE NEW DOOR AND FRAMES AS INDICATED; PREPARE ADJACENT FINISHES TO ACCOMMODATE NEW ALUMINUM FRAME & DOORS COLORS TO BE SELECTED BY ARCHITECT
- REPAIR (E) FINISHES TO MATCH (E) ADJACENT AS REQ'D TO ACCOMMODATE NEW WORK.
- FASTENER SELECTION AND PATTERN SHALL COMPLY WITH DESIGN LOADS.

CODE ANALYSIS















APPLICABLE CODES
BUILDING SUBCODE EDITION INTERNATIONAL BUILDING CODE / 2015, NEW JERSEY ICC / ANSI A117.1 - 2009 INTERNATIONAL FIRE CODE / 2015
ELECTRICAL SUBCODE NATIONAL ELECTRICAL CODE / 2015
REHABILITATION SUBCODE NJUCC, SUBCHAPTER 6


BUILDING ANALYSIS
(FROM IBC 2015 - NEW JERSEY EDITION)
THE FLOOR PLAN AREA AND HEIGHT OF THE SCHOOL BUILDING HAS NOT CHANGED UNDER THIS PROJECT, THEREFORE NO ANALYSIS OF THE EXISTING BUILDING HAS BEEN PROVIDED.

EGRESS ANALYSIS
(FROM NEW JERSEY REHABILITATION SUBCODE 523-6)
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GENERAL NOTES:

- THE WORK IS GOVERNED BY THE NIUCC AND SUBCODES OF THE INTERNATIONAL BUILDING CODE 2015, NJ EDITION AND AS AMENDED BY THE PROJECT DOCUMENTS.
- THE CONTRACTOR IS RESPONSIBLE TO SECURE ALL PERMITS, TO OBTAIN APPROVALS AS REQUIRED AND COORDINATE INSPECTION WITH LOCAL BUILDING INSPECTOR. ALL PERMIT AND APPLICATION FEES WILL BE PAID BY THE OWNER AND DELIVERED BY THE CONTRACTOR.
- DRAWINGS & SPECIFICATIONS COMPLIMENT EACH OTHER. WORK NOT SHOWN ON DRAWINGS BUT CALLED FOR IN THE SPECIFICATIONS IS STILL REQUIRED, AND ALL WORK NOT CALLED FOR IN SPECIFICATIONS, BUT CALLED OUT OR SHOWN IN DRAWINGS IS STILL REQUIRED.
- ALL CONTRACTORS ARE ADVISED TO VISIT THE SITE AND VERIFY ALL AREAS, DIMENSIONS, AND CONDITIONS PRIOR TO SUBMITTING THEIR BIDS. THE CONTRACTOR MUST NOTIFY THE ARCHITECT OF ANY DISCREPANCIES AND/OR OMISSIONS IN WRITING AT LEAST TEN DAYS PRIOR TO THE RECEIPT OF BIDS. FAILURE TO SO NOTIFY THE ARCHITECT INDICATES THAT ANY ADDITIONAL COSTS ASSOCIATED WITH THE DISCREPANCIES AND / OR OMISSIONS ARE INCLUDED IN THE CONTRACTORS BID AND THAT NO CHANGE TO THE CONTRACT AMOUNT WILL BE MADE AFTER THE RECEIPT OF BIDS OR THE AWARD OF CONTRACTS.
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- THE CONTRACTOR SHALL MAINTAIN FULL WORK SITE SAFETY & SECURITY AT ALL TIMES. THE CONTRACTOR SHALL PROVIDE TEMPORARY BARRICADES, ENCLOSURES AND ANY OTHER FORMS OF PROTECTION REQUIRED TO PROTECT THE BUILDING OCCUPANTS AND GENERAL PUBLIC FROM INJURY.
- THE CONTRACTOR IS RESPONSIBLE FOR ALL WORK, MATERIAL, EQUIPMENT, AND LABOR TO PROVIDE A COMPLETE, FINISHED, AND FUNCTIONAL SYSTEM WHETHER SPECIFIED OR IMPLIED.
- CONFINE ACTIVITIES TO THE IMMEDIATE WORK AREA ONLY. UTILIZE ONLY THOSE UTILITIES AND FACILITIES AS DESIGNATED BY THE OWNER. CONTRACTOR ACCESS BY PERSONNEL, PARKING, AND MATERIAL STORAGE SHALL BE ONLY IN AREAS DESIGNATED BY THE OWNER.
- DURING CONSTRUCTION, CLEAN AND PROTECT WORK IN PROGRESS. PROMPTLY REMOVE ANY DEBRIS FROM THE SITE. NO TRASH ACCUMULATION IS PERMITTED. TRANSPORT AND LEGALLY DISPOSE OF MATERIAL OFF SITE.
- INSPECT AND DOCUMENT EXISTING CONDITIONS, SURFACES, FINISHES, FURNISHINGS, EQUIPMENT, ETC IN THE VICINITY OF THE WORK WITH THE OWNER PRIOR TO COMMENCING THE WORK. RESTORE ALL CONDITIONS, ETC., DAMAGED BY THE WORK TO THE PRECONSTRUCTION CONDITION AND TO THE OWNERS SATISFACTION.
- ALL ELECTRICAL WORK SHALL BE PERFORMED BY A NJ LICENSED ELECTRICAL CONTRACTOR IN STRICT COMPLIANCE WITH THE N.E.C.
- EXTERIOR WALLS SHALL REMAIN IN PLACE FOR SECURITY & WEATHER PROTECTION UNTIL SUCH TIME AS THEY CAN BE REMOVED AND REPLACED WITH NEW CONSTRUCTION TO PROVIDE SECURITY & WEATHER PROTECTION WITHIN THE SAME WORK DAY WHILE PROJECT IS STAFFED BY CONTRACTOR.
- PERFORM ALL DEMOLITION AND REMOVAL WORK IN SUCH A MANNER AS NOT TO REDUCE THE LOAD-CARRYING CAPACITY ABILITIES OF ANY STRUCTURAL MEMBERS, WALLS, ELEMENTS, ETC. PROVIDE SHORING DURING CONSTRUCTION TO SUITE CONDITIONS.
- COORDINATE ALL SERVICE AND UTILITY INTERRUPTIONS WITH THE OWNER TO AVOID INTERRUPTING THE OWNER'S OPERATIONS.



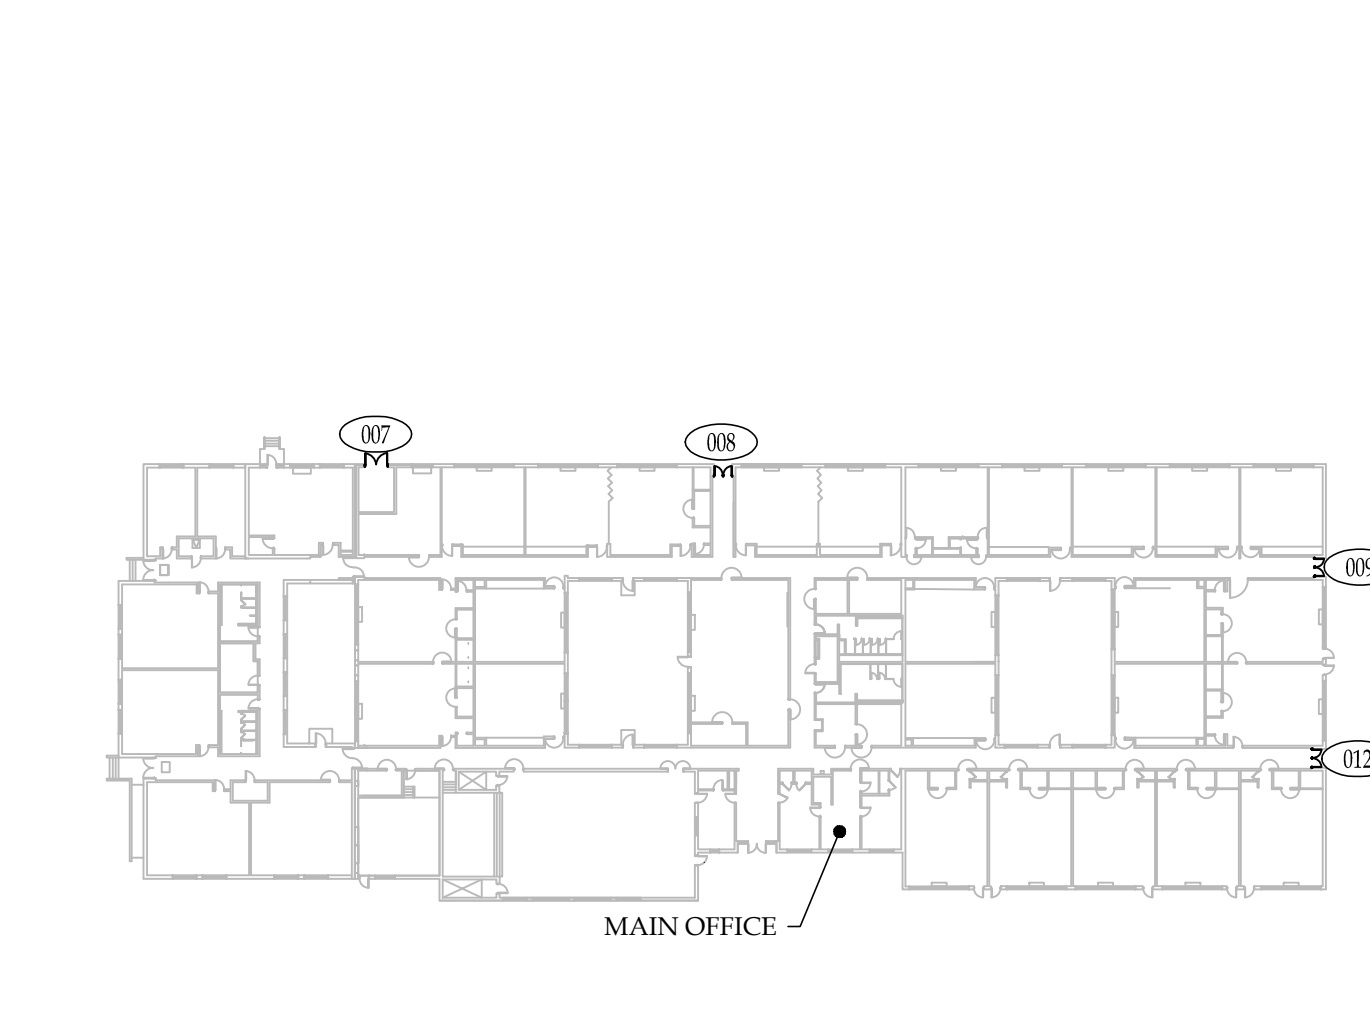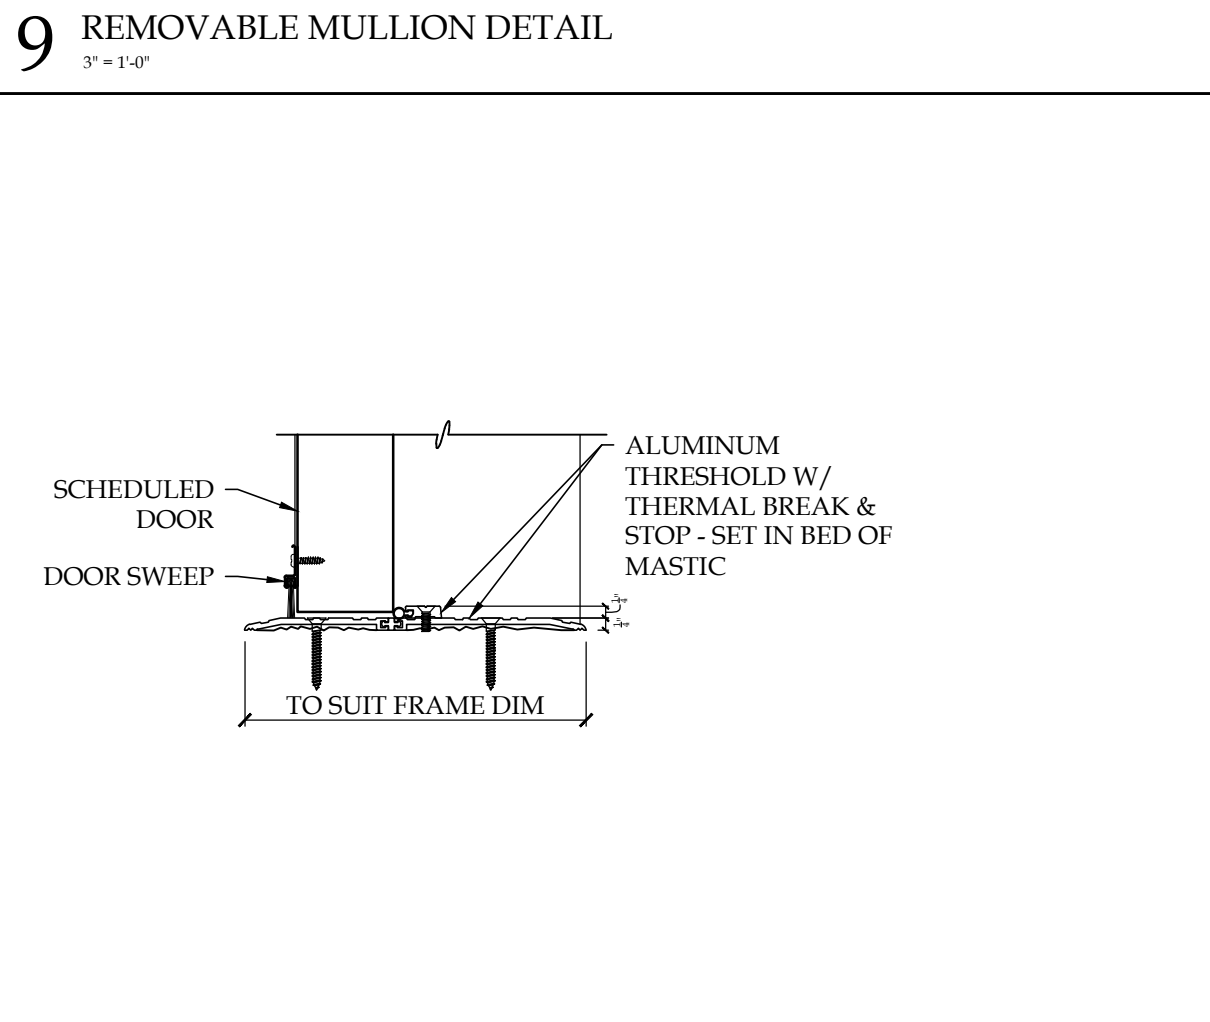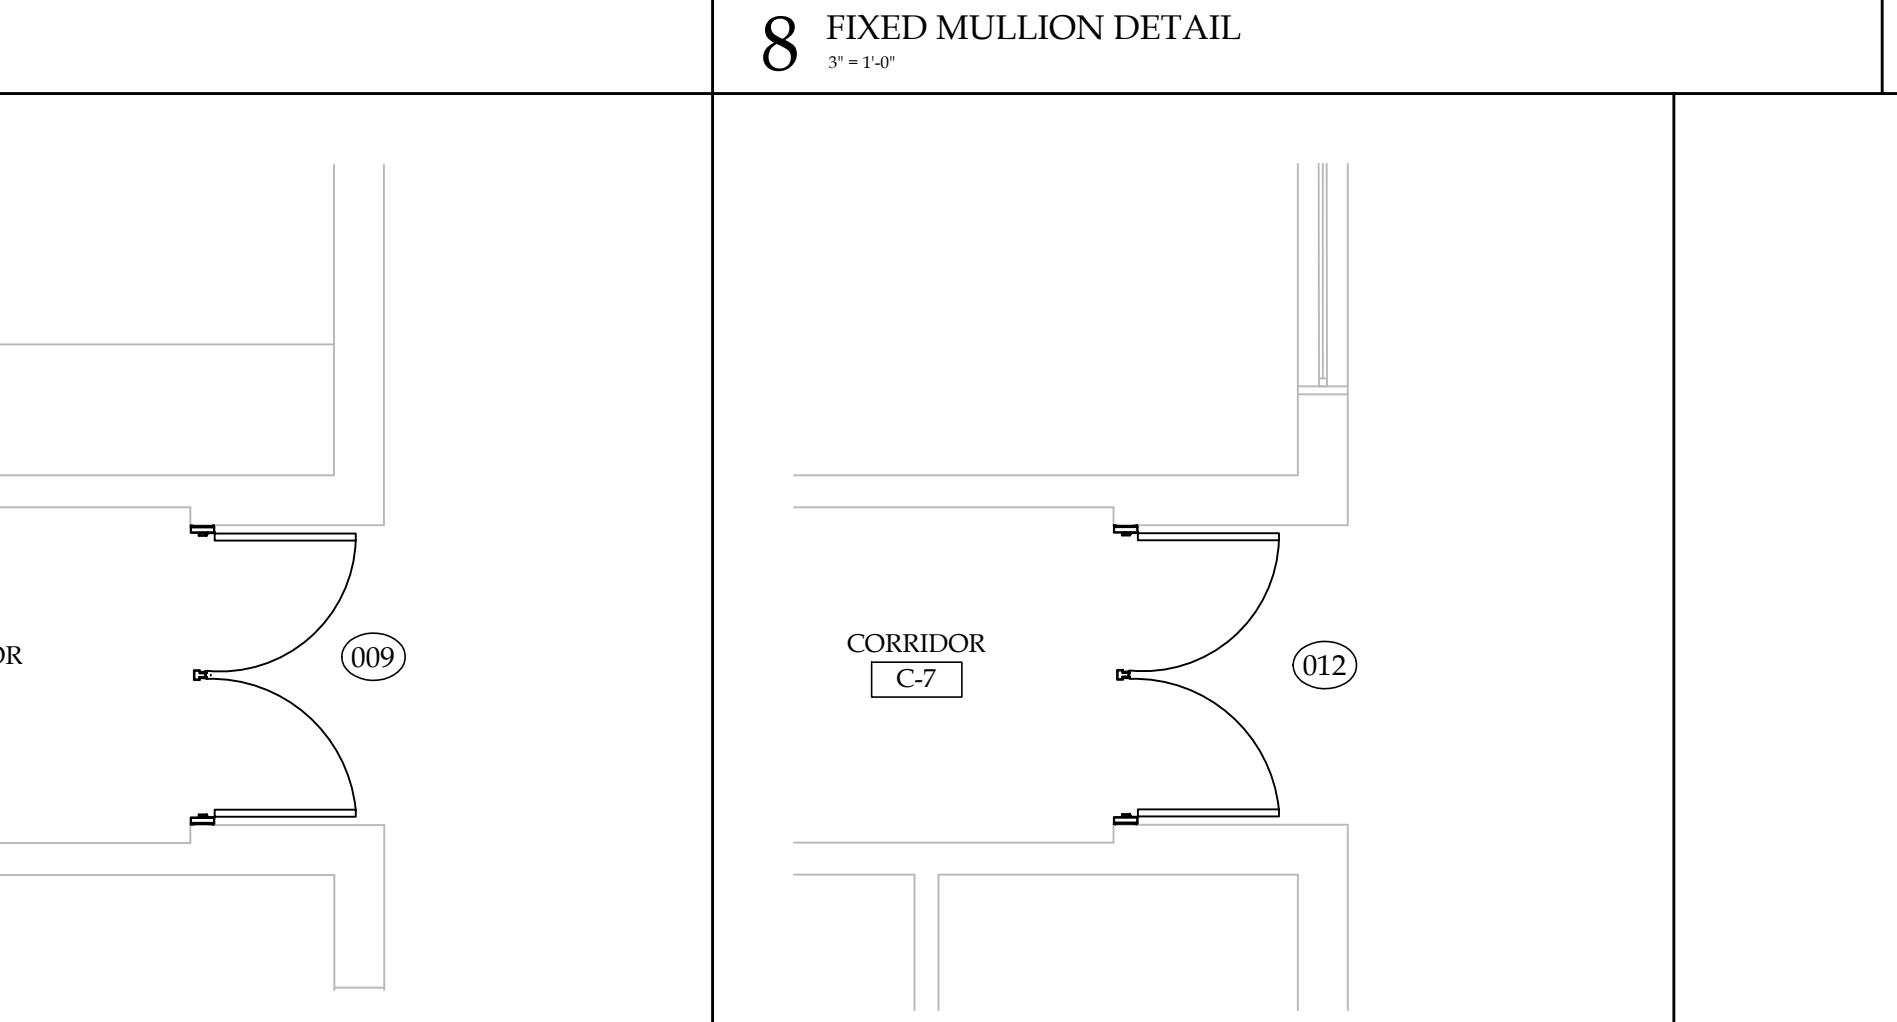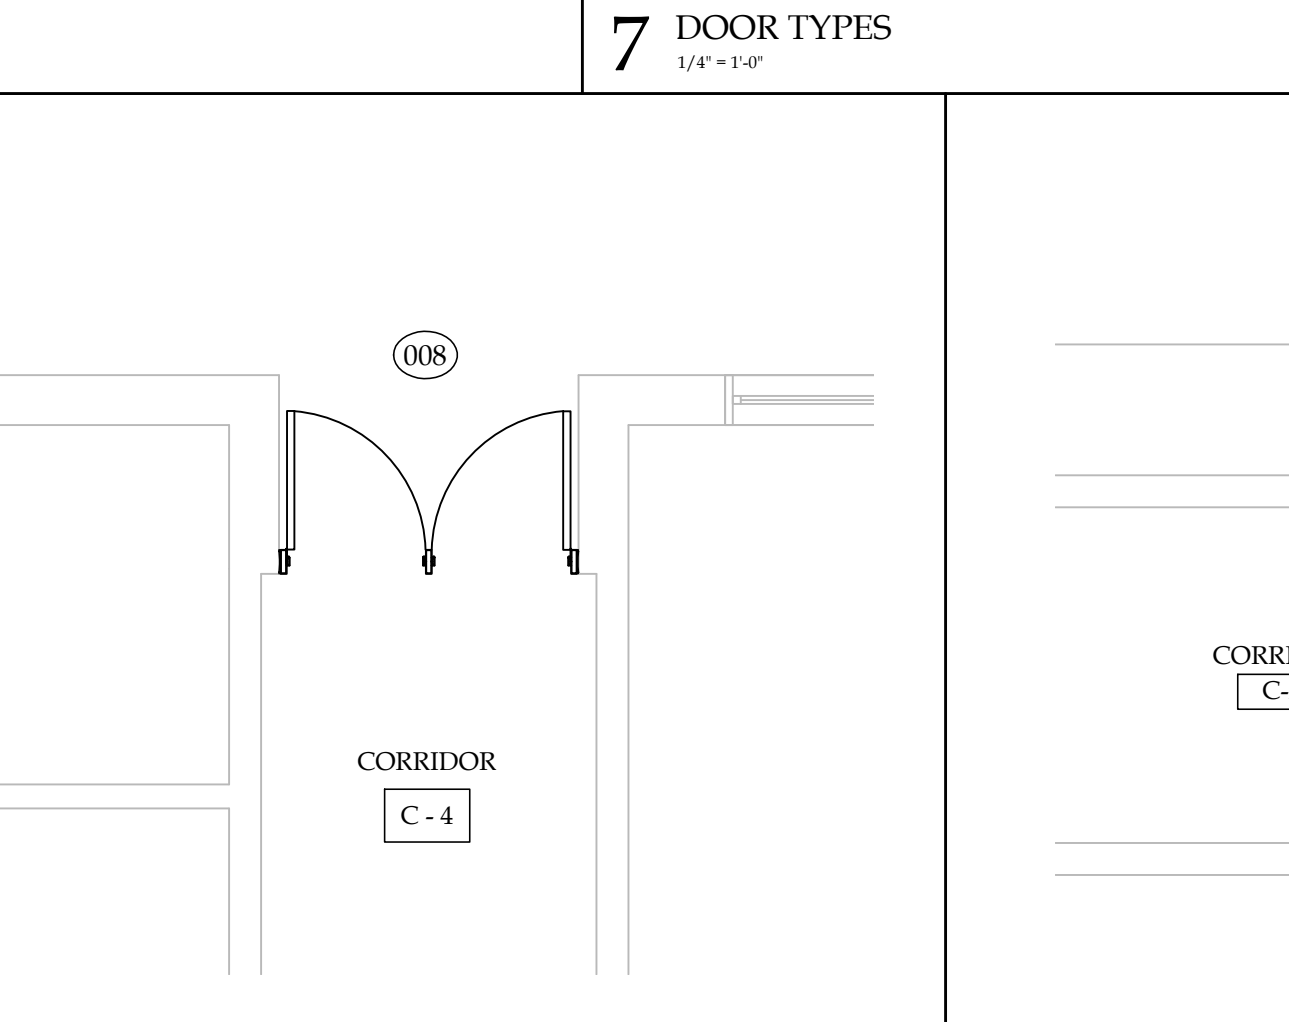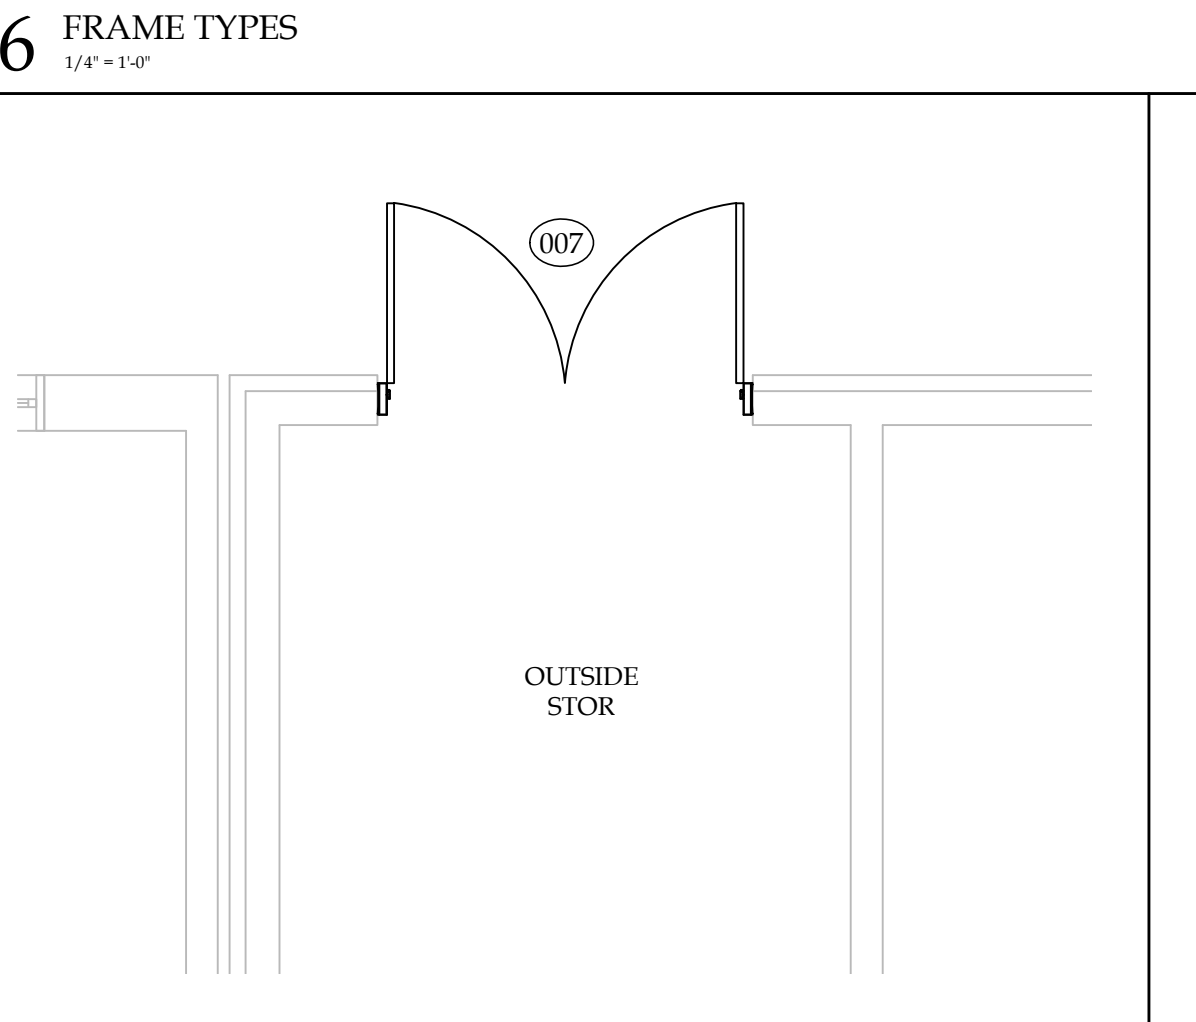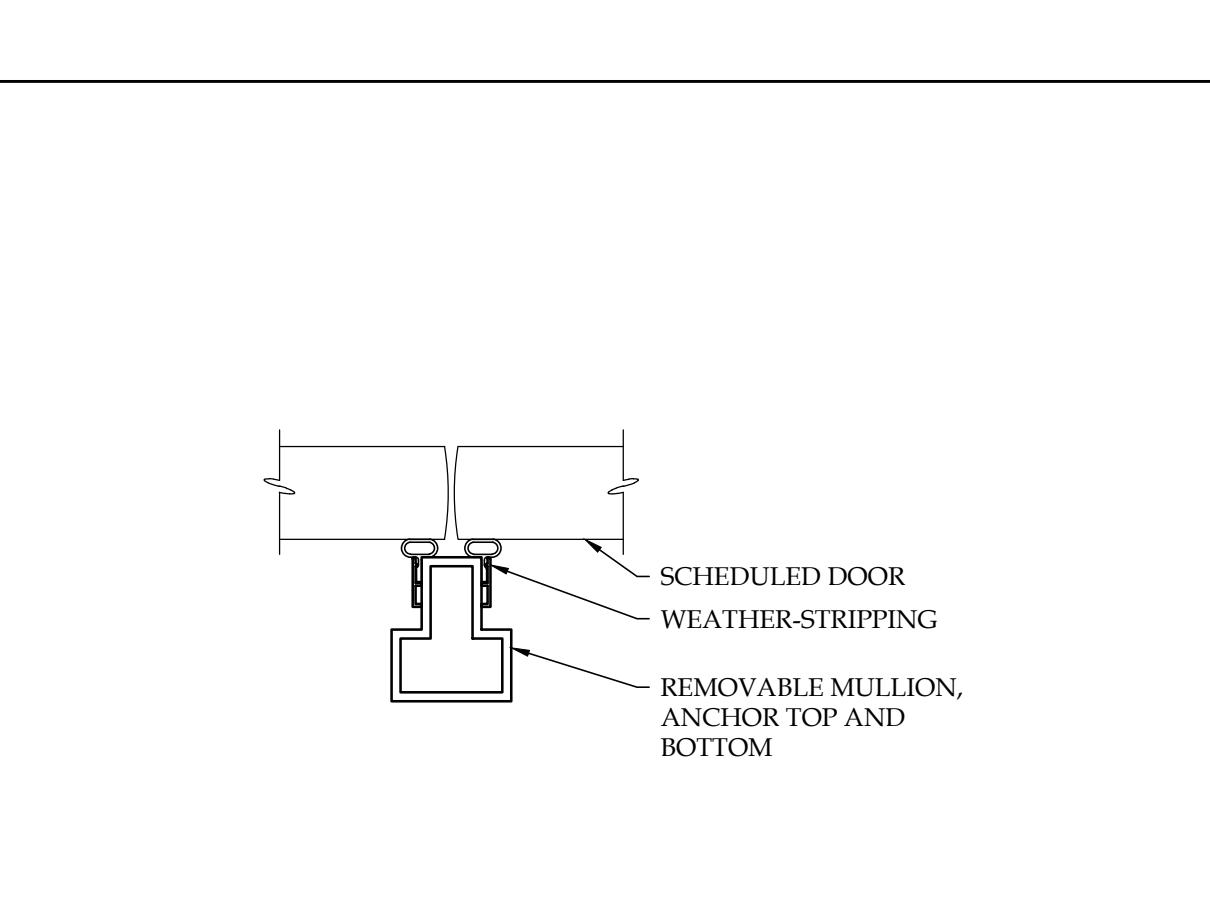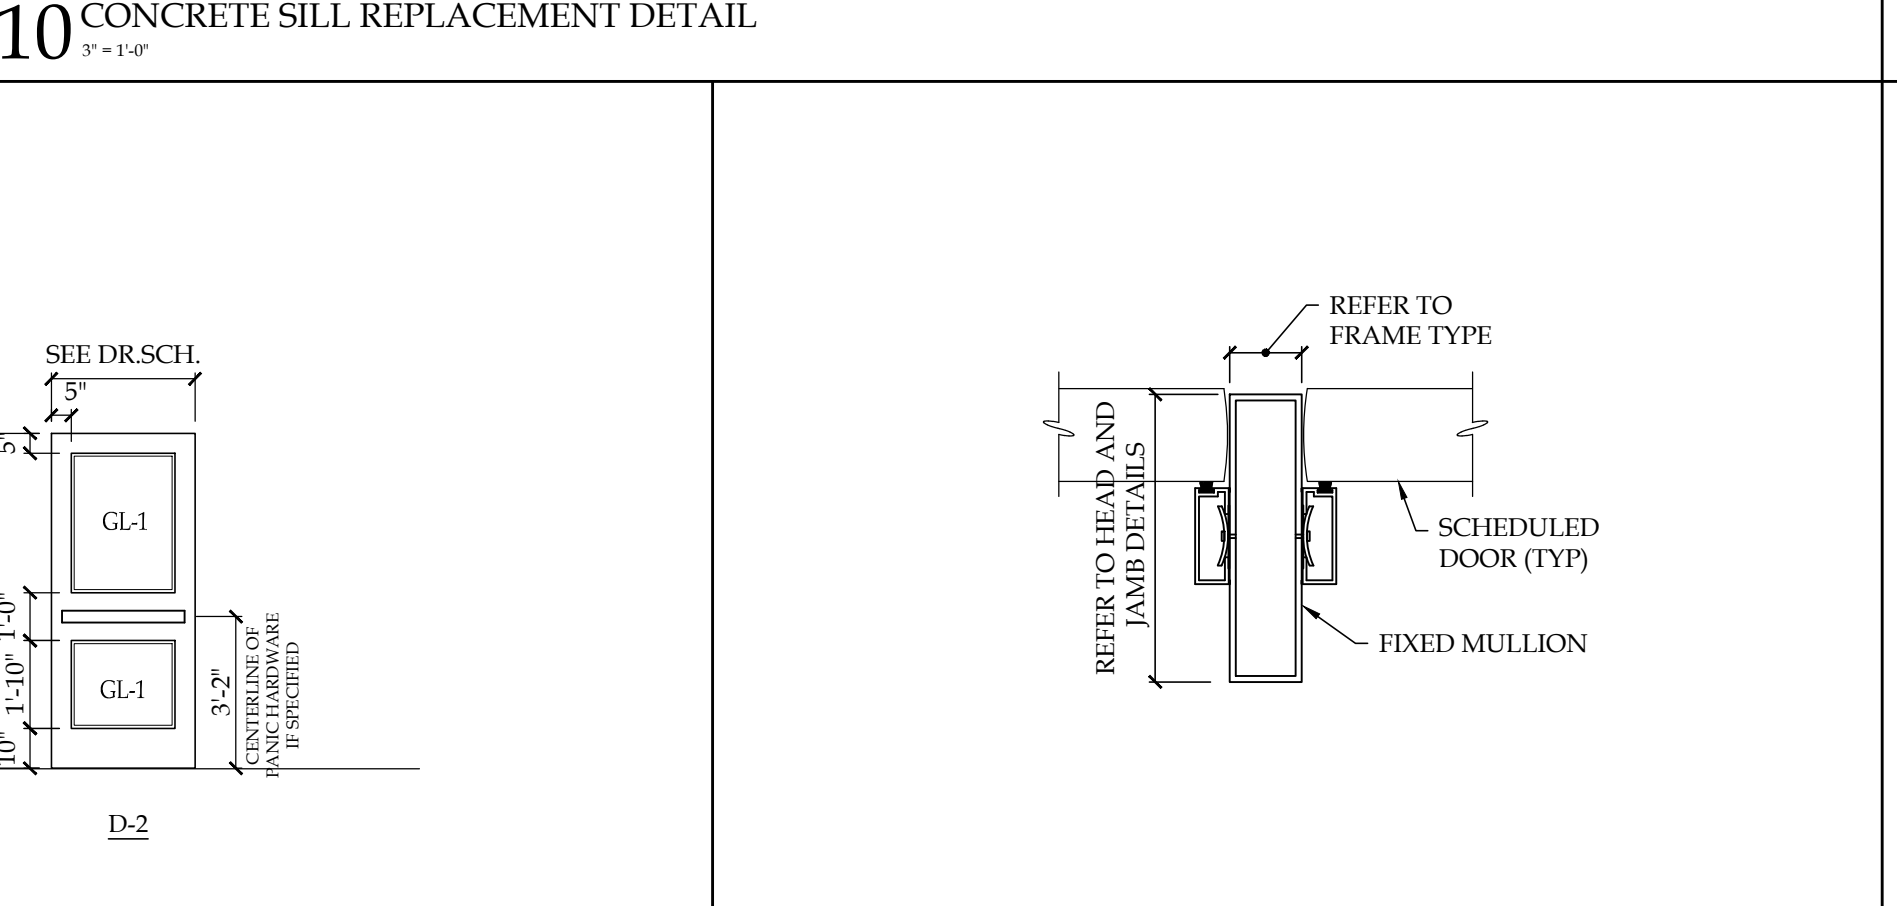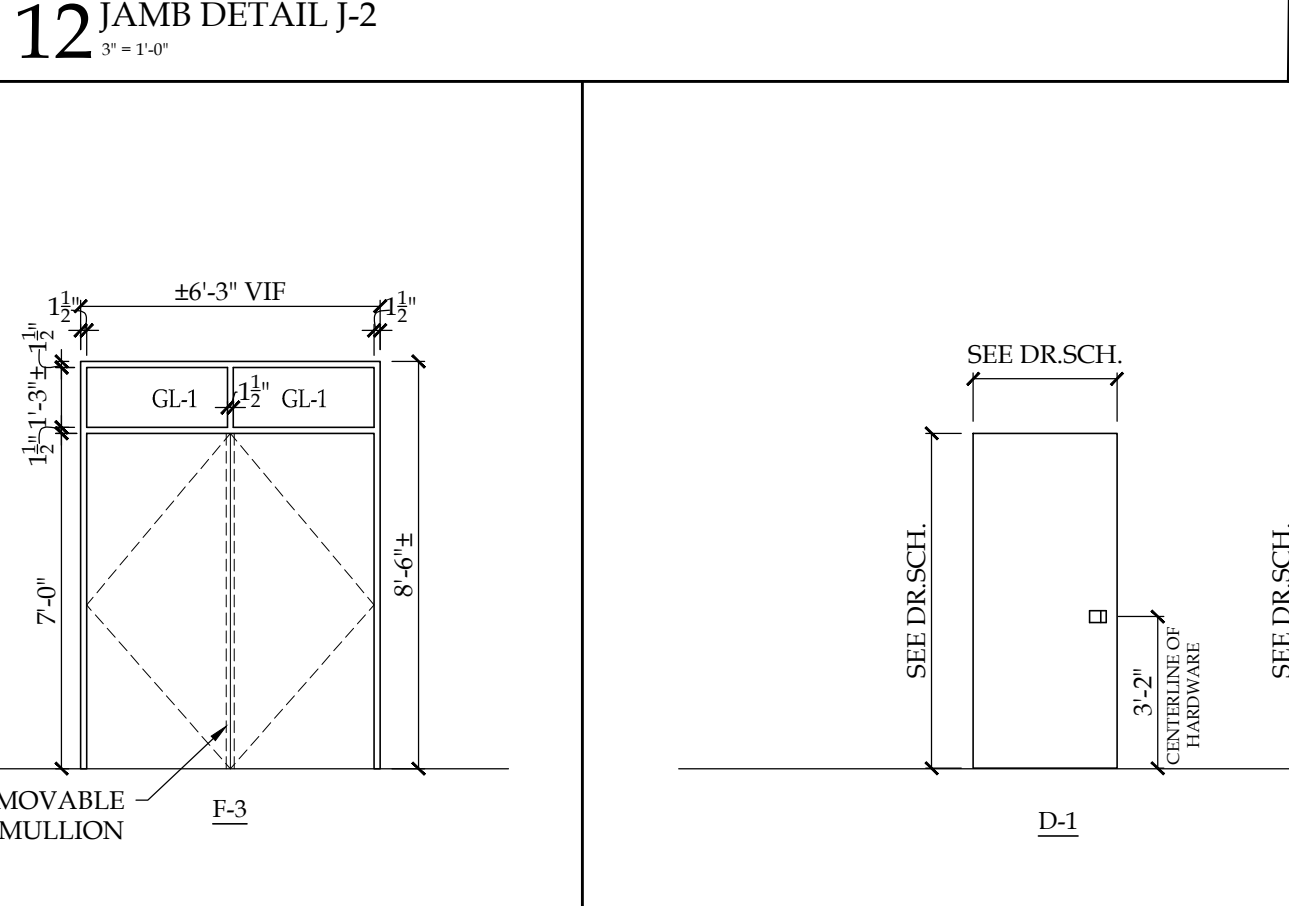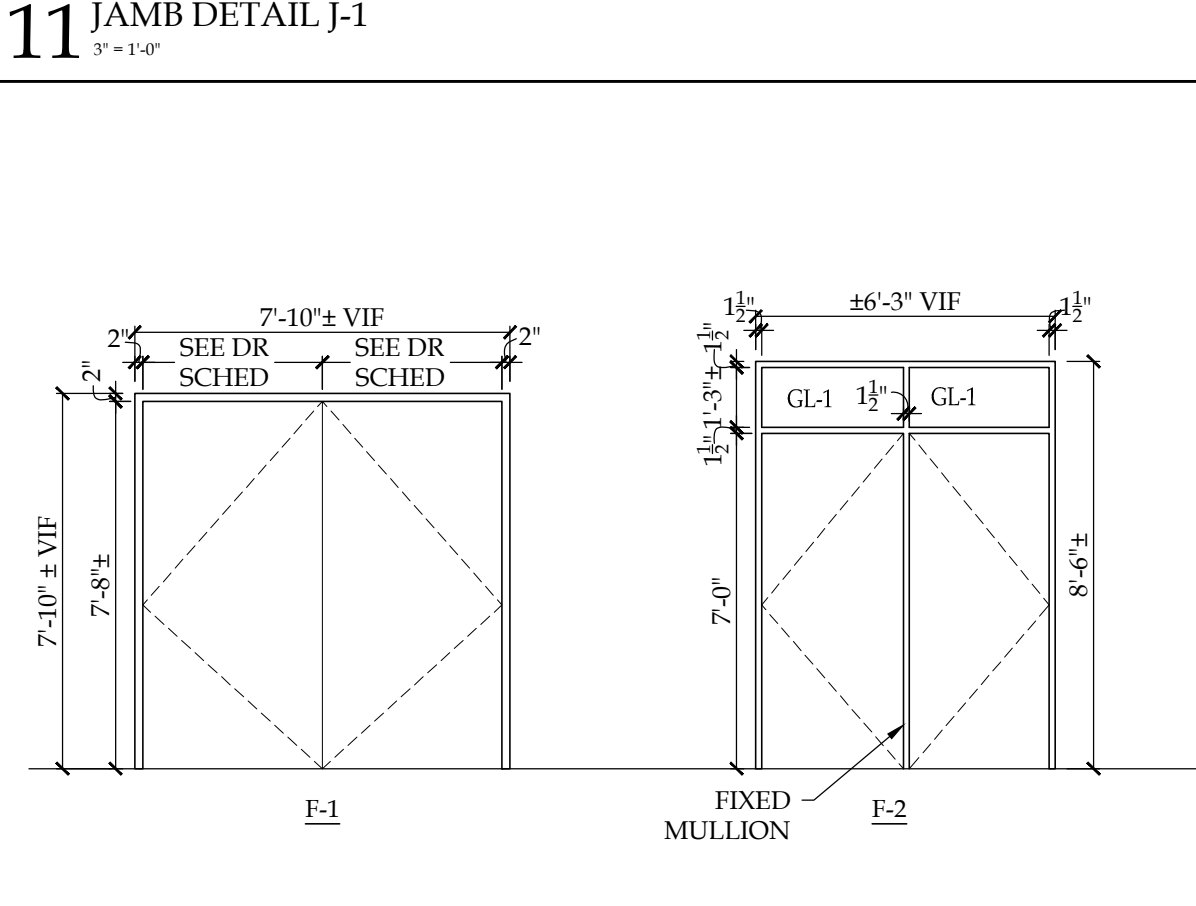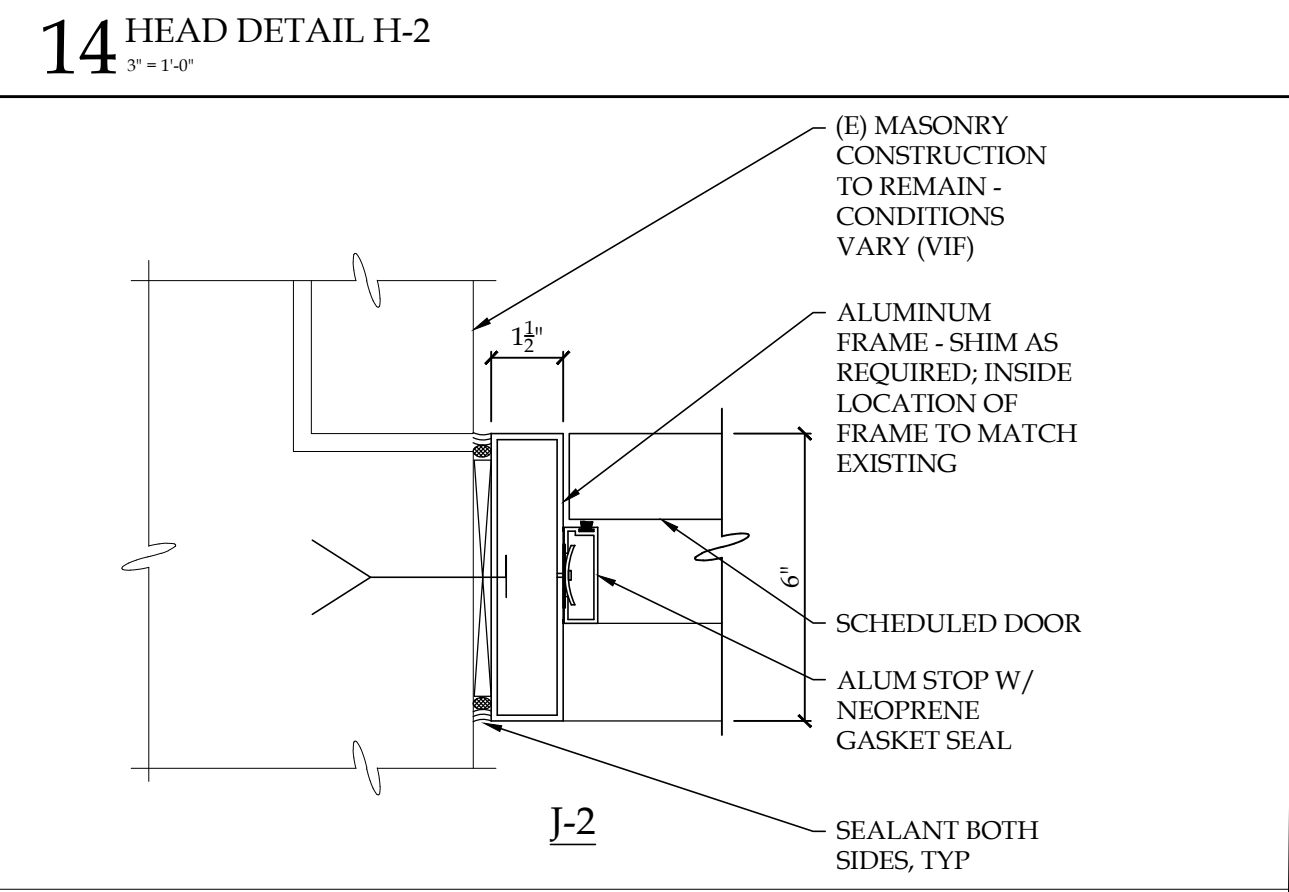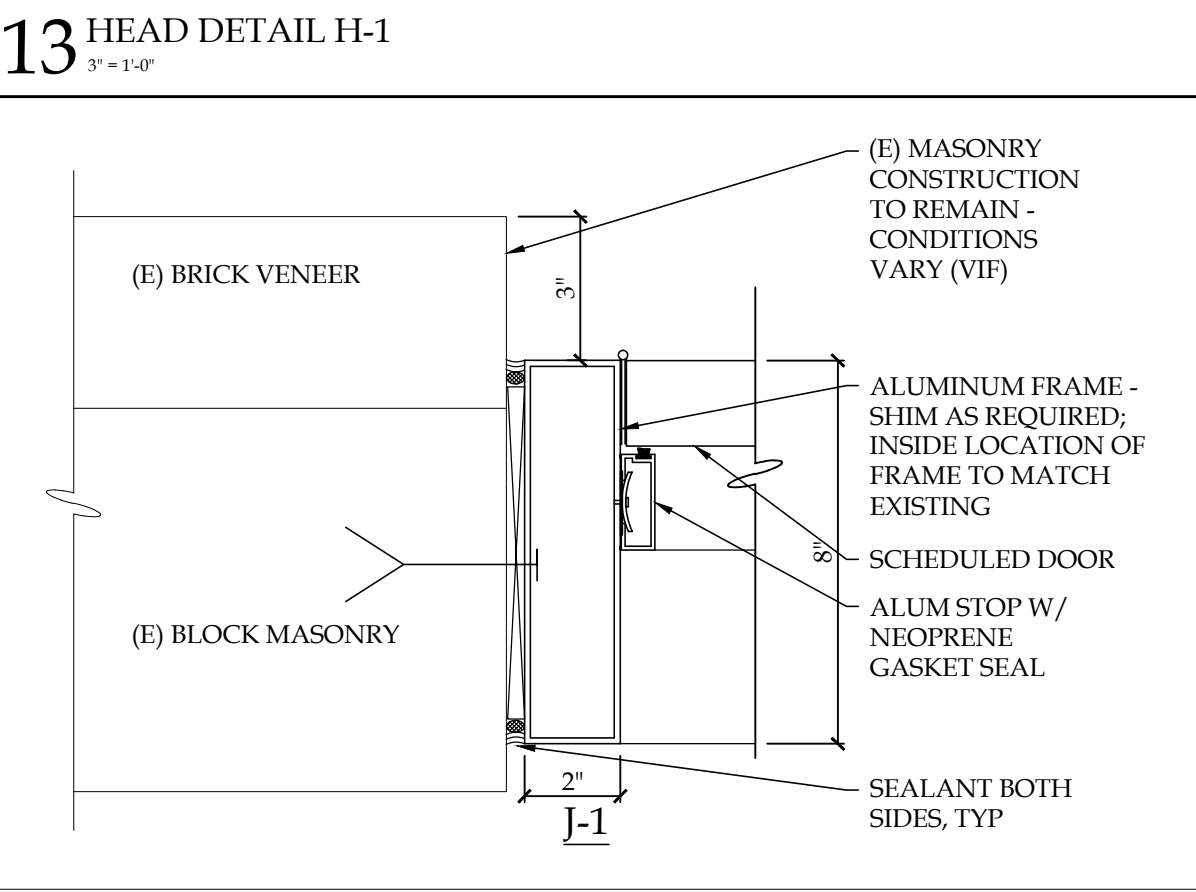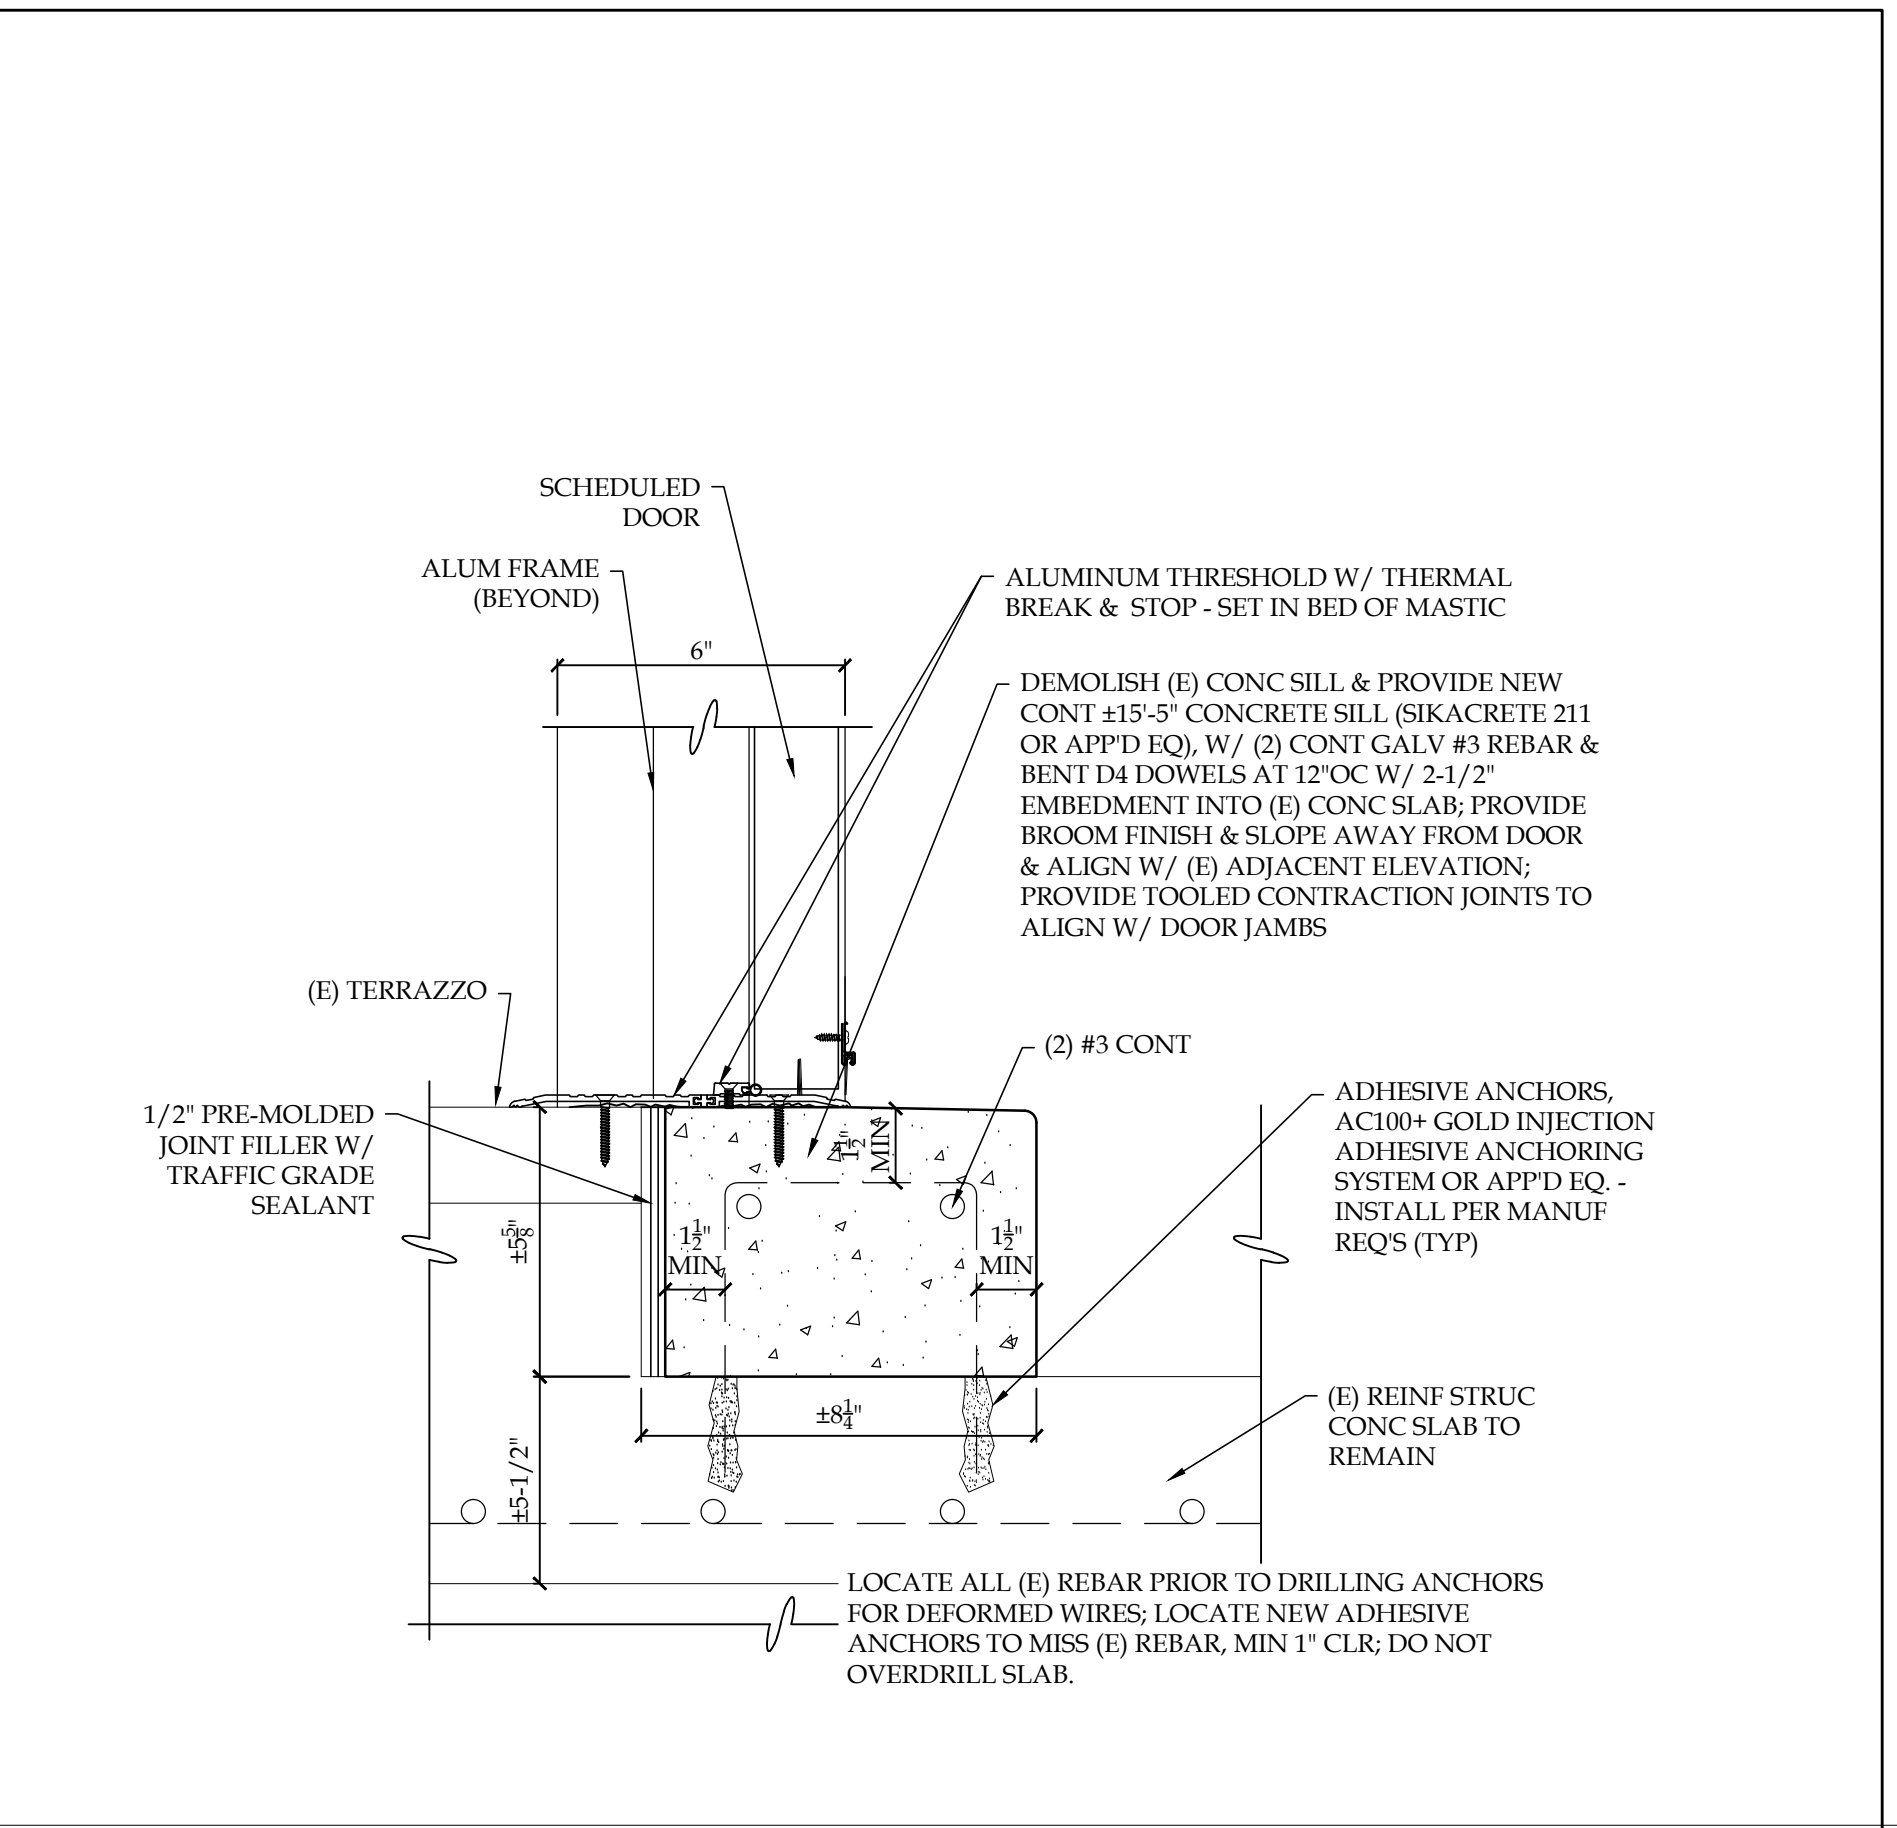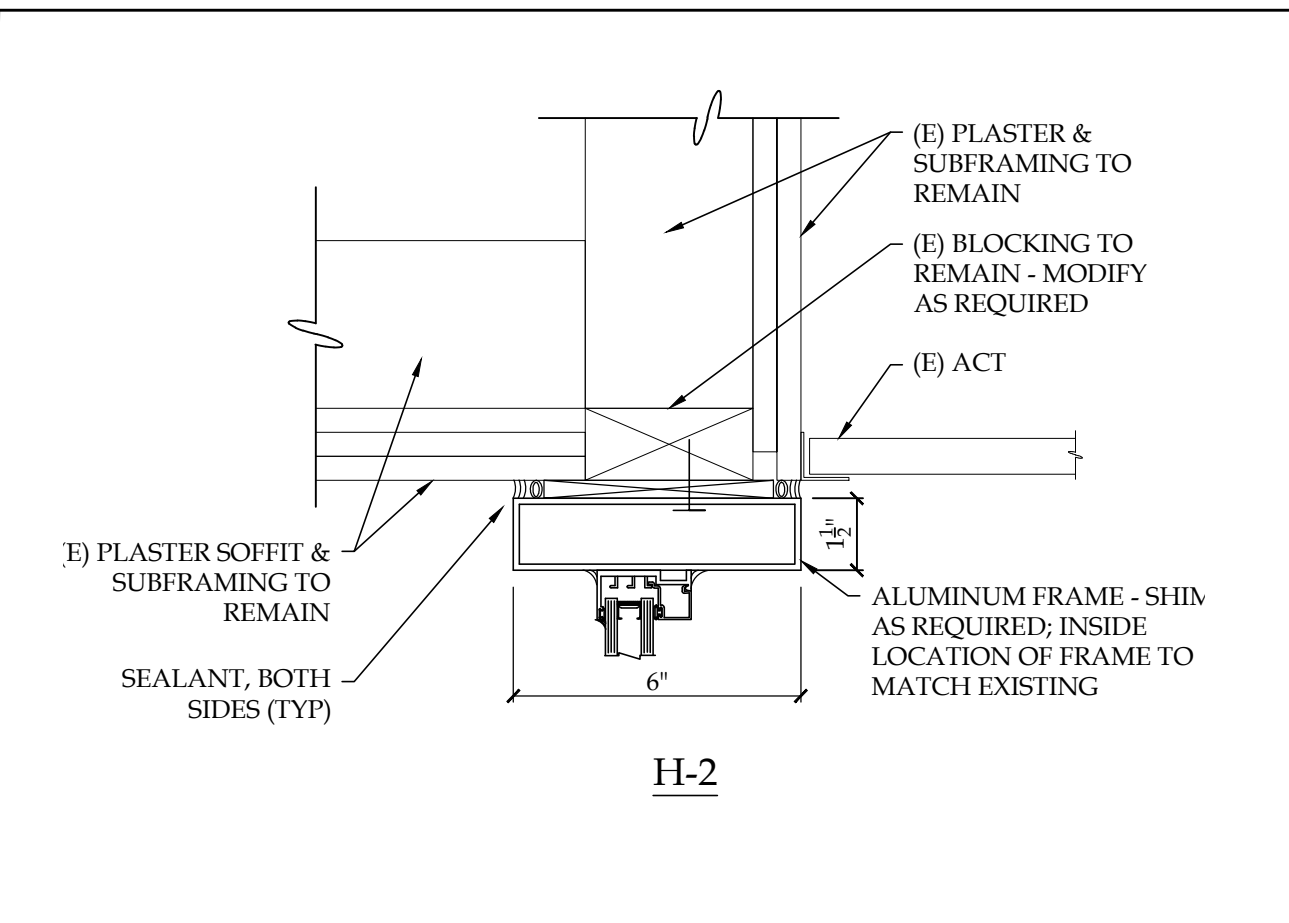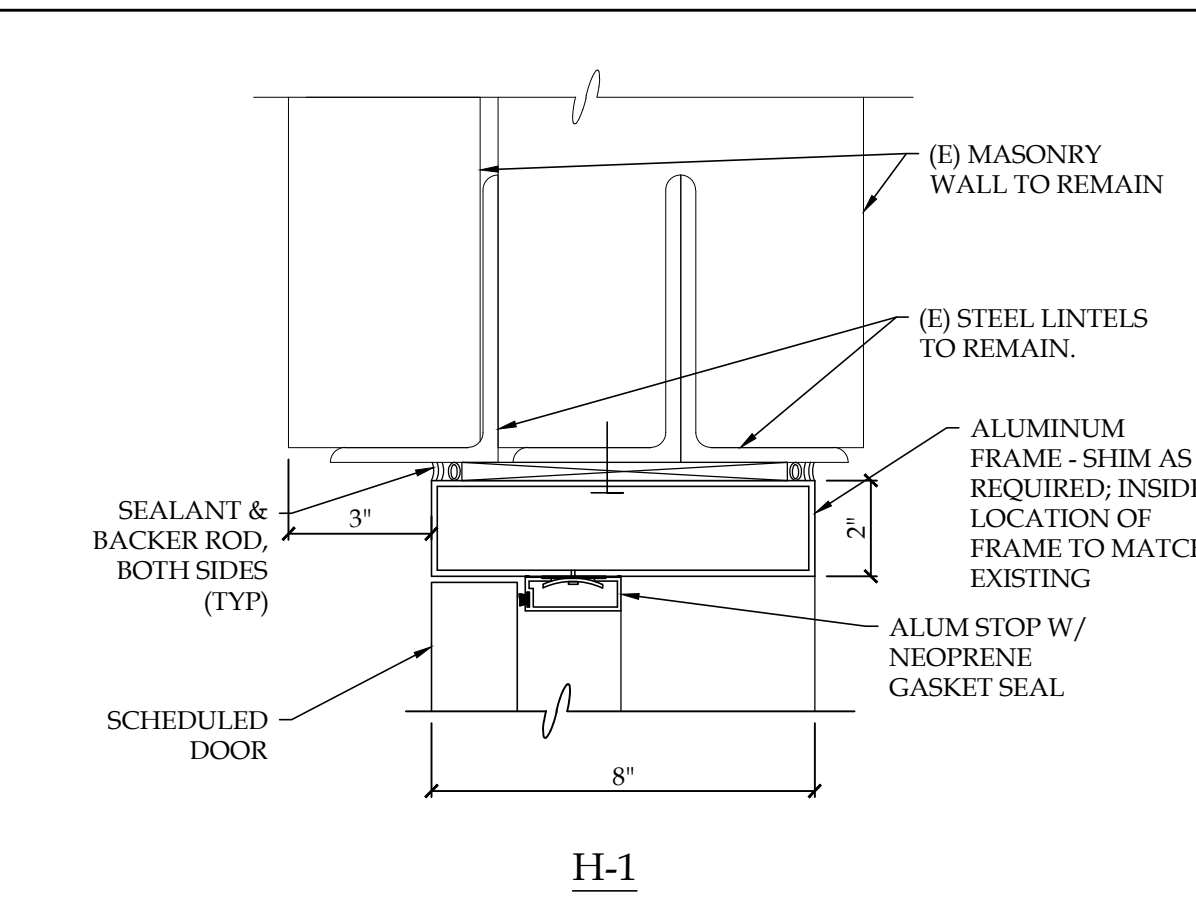
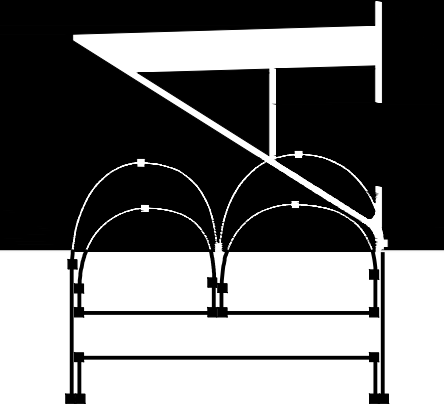
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F: 856.354.6367
W: www.becica.com

Exterior Door Replacement & Related Work at the Barton Elementary School
223 Rhode Island Avenue, Cherry Hill, NJ 08002
Lot: 1 Block: 340.24
Cherry Hill Board Of Education
PO Box 5015, 45 Randolph Terrace, Cherry Hill, New Jersey 08034

<p>Contractor shall check and verify all conditions and dimensions at the site before proceeding with this work.</p> <p>Revisions</p> <table border="1" style="width: 100%; border-collapse: collapse;"> <thead> <tr> <th>#</th> <th>Date</th> <th>Description</th> </tr> </thead> <tbody> <tr> <td> </td> <td> </td> <td> </td> </tr> </tbody> </table>	#	Date	Description				<p>Set Issue:</p> <p style="text-align: center;">Issued for Bidding</p> <p>Issue Date: April 5, 2019</p> <p>Drawing Title: Plans, Details Notes & Schedules</p> <p>Drawn by: _____ Checked by: _____</p> <p style="text-align: center;">DB JJM</p> <p>Project Number: 19CHS-02016 DOE State Plan Number #:</p> <p>Drawing Number: A-1.1</p>
#	Date	Description					

DOOR SCHEDULE														REMARKS	
DOOR NUMBER	DOOR				FRAME				MISCELLANEOUS						
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008	3'-1"	7'-0"	D-1	2	FRP	1-3/4"	F-3	ALUM	REMOVABLE	J-3	H-3	T-1	7	GL-1	REFER TO CONCRETE SILL DETAIL #15
009	3'-0"	7'-0"	D-1	2	FRP	1-3/4"	F-1	ALUM	FIXED	J-3	H-3	T-1	7.1	GL-1	REFER TO CONCRETE SILL DETAIL #15
010	3'-0"	7'-0"	D-1	2	FRP	1-3/4"	F-4	ALUM	-	J-3	H-3	T-1	9	GL-1	
015	3'-0"	7'-0"	D-1	2	FRP	1-3/4"	F-4	ALUM	-	J-1	H-4	T-1	9	GL-1	
016A 016B	3'-0" 2'-5"	7'-0"	D-1	2	FRP	1-3/4"	F-2	ALUM	-	J-1	H-4	T-1	4	GL-1	

DOOR SCHEDULE NOTES:

- (E) STEEL LINTELS ABOVE OPENING TO BE SCRAPED, CLEANED, PRIMED & PAINTED
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GL-1: 1" INSULATED, LAMINATED, TINTED (EVERGREEN), SAFETY GLAZING

LEGEND

- ALUM ALUMINUM
- (E) EXISTING TO REMAIN
- (ER) EXISTING RELOCATED
- FRP FIBERGLASS REINFORCED POLYESTER
- (R) REMOVE EXISTING
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BUILDING SUBCODE EDITION INTERNATIONAL BUILDING CODE / 2015
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REHABILITATION SUBCODE NJUCC, SUBCHAPTER 6

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(FROM IBC 2015 - NEW JERSEY EDITION)

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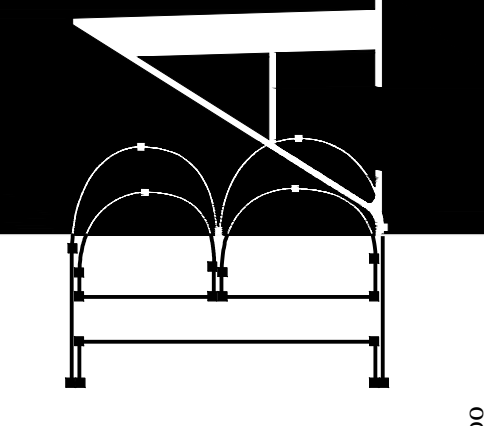
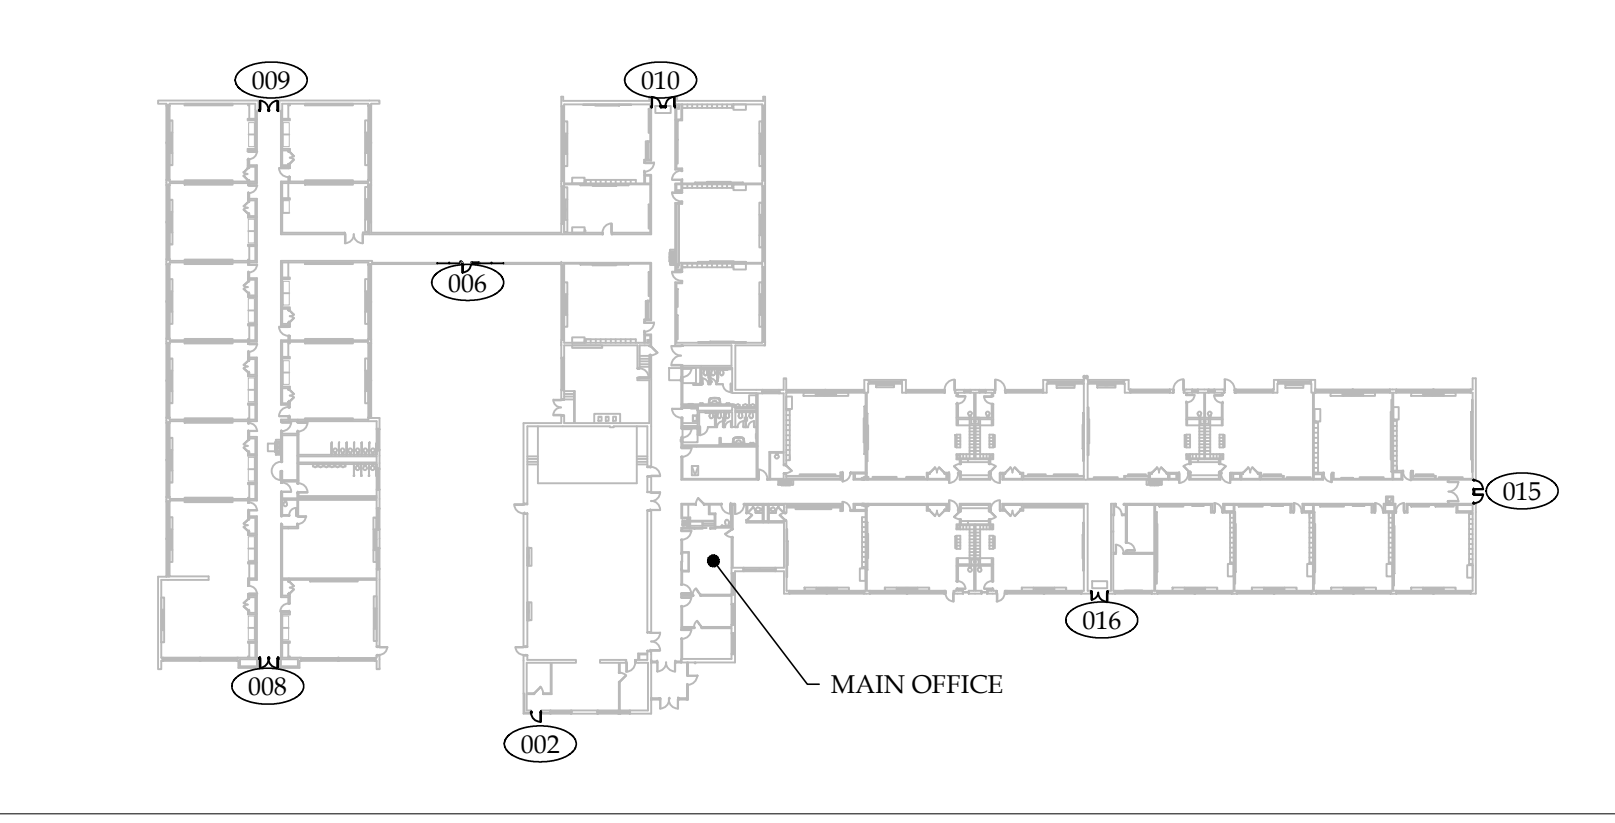
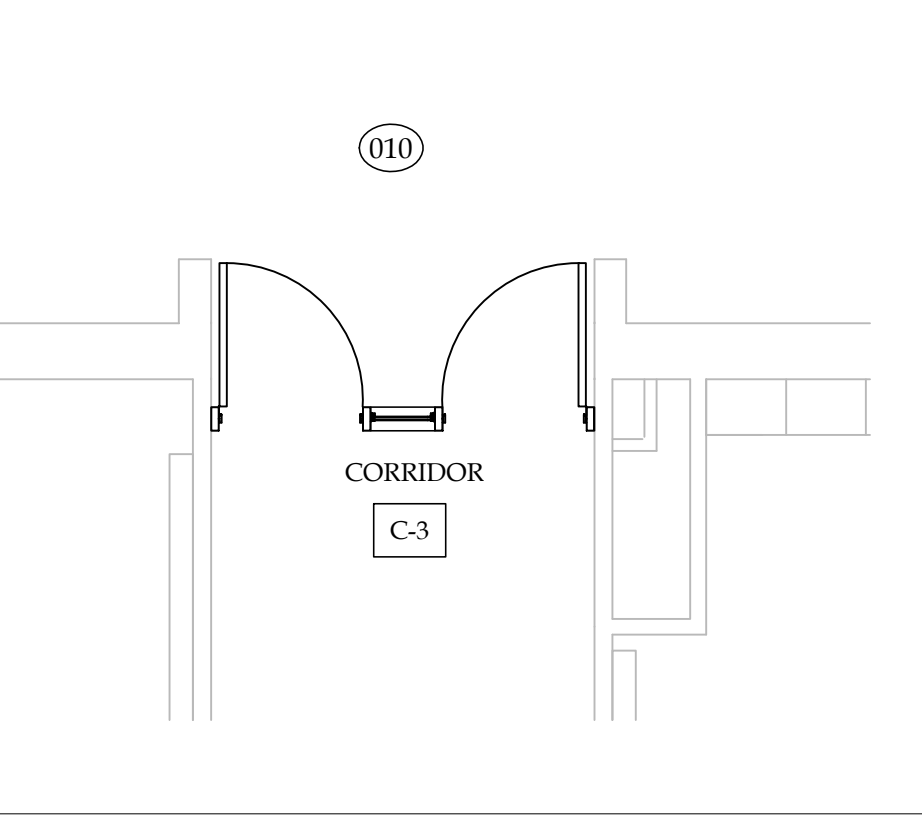
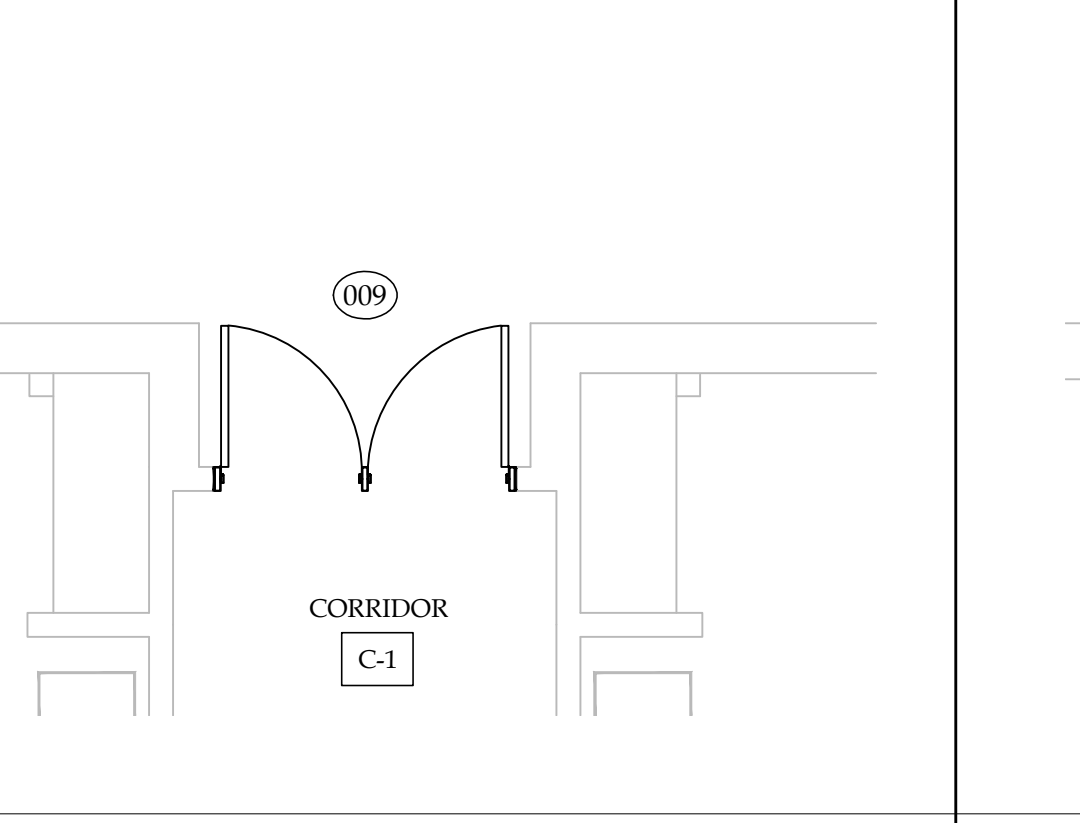
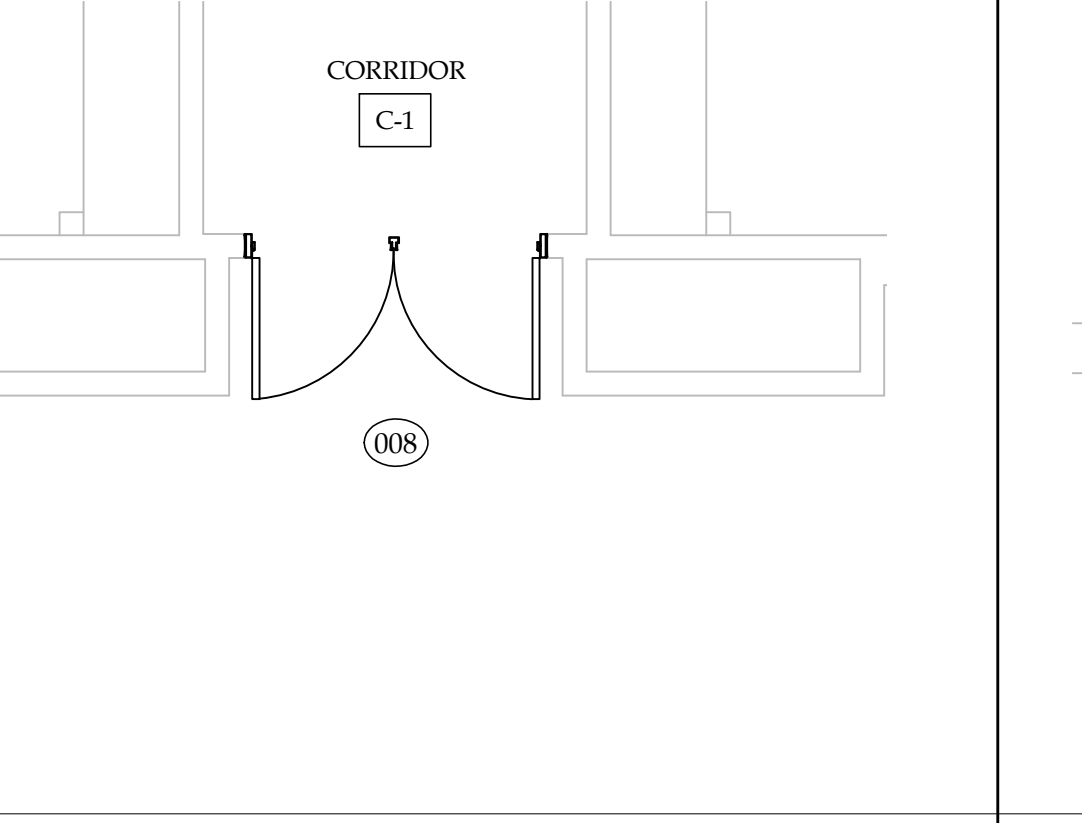
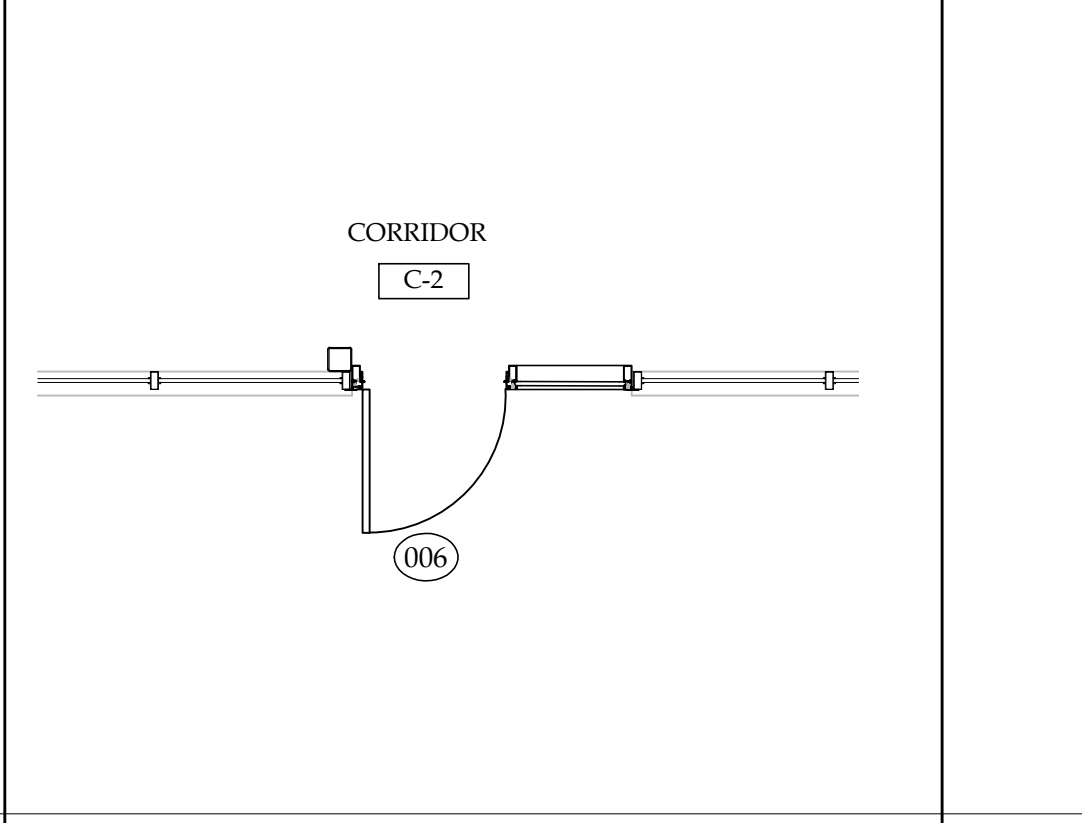
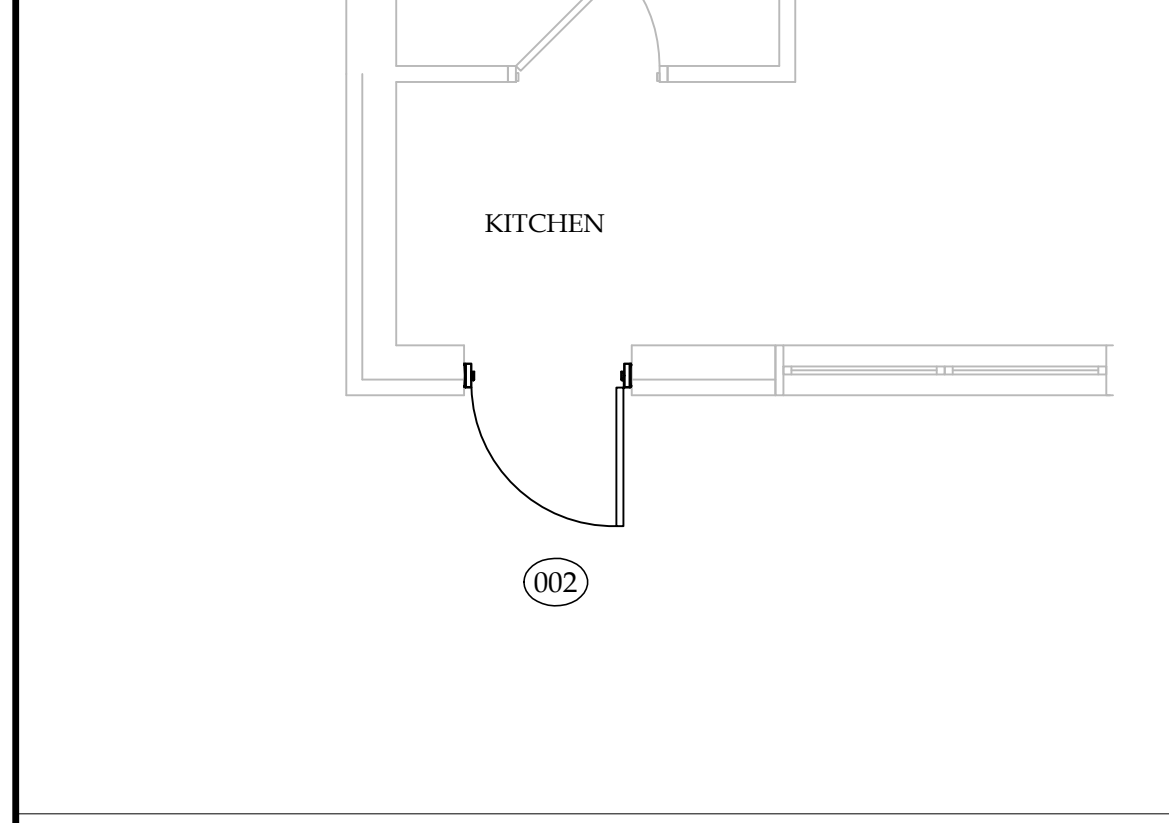
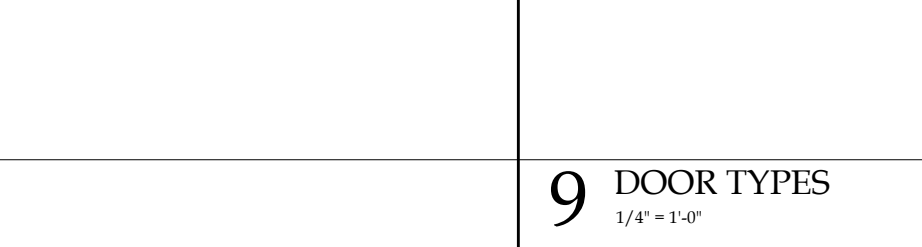
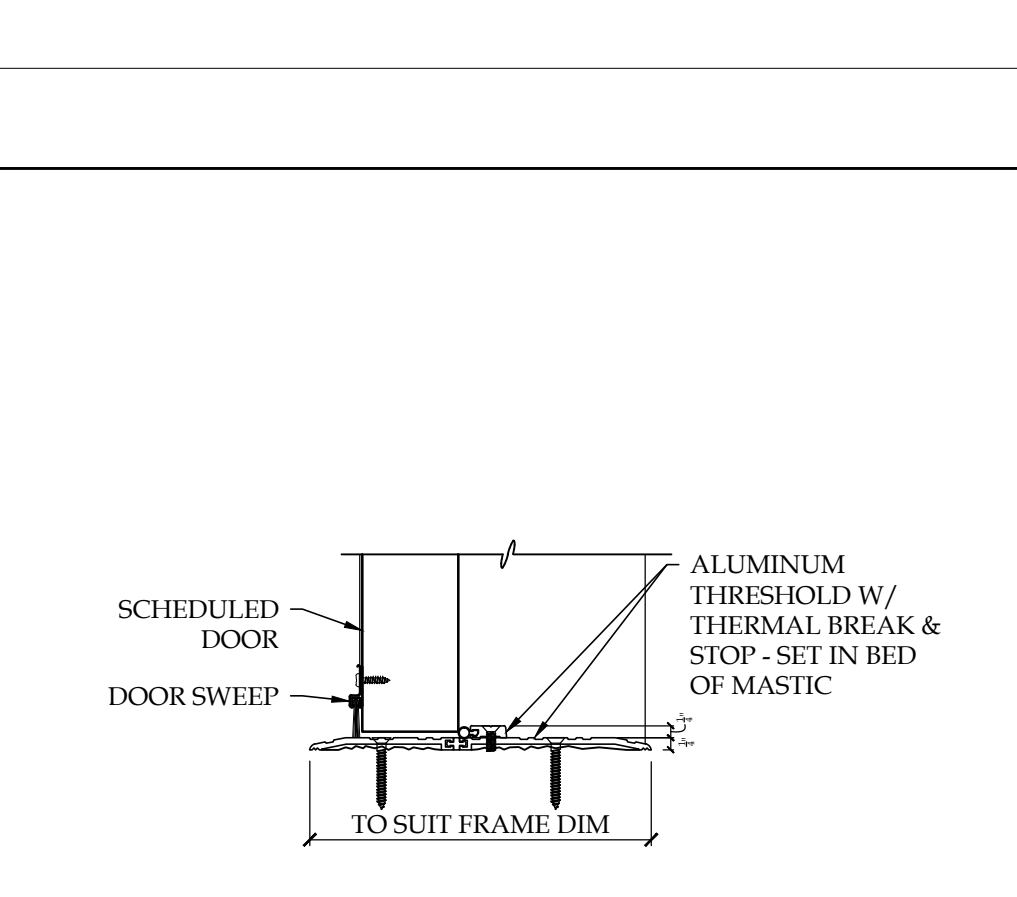
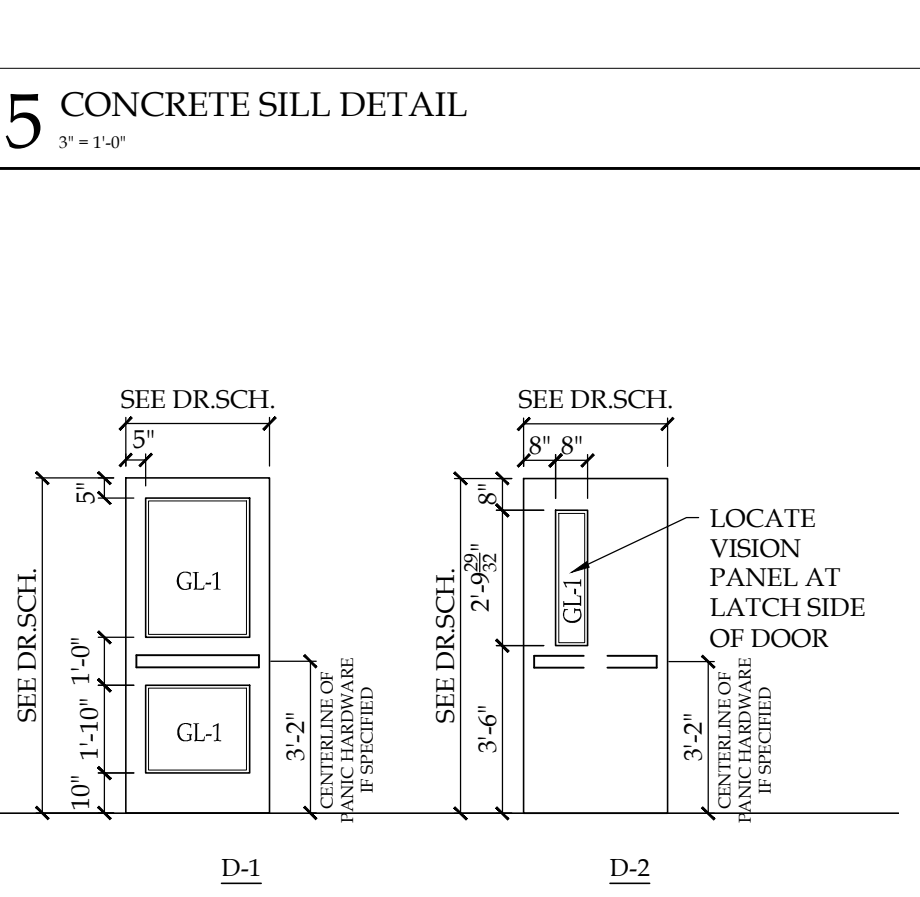
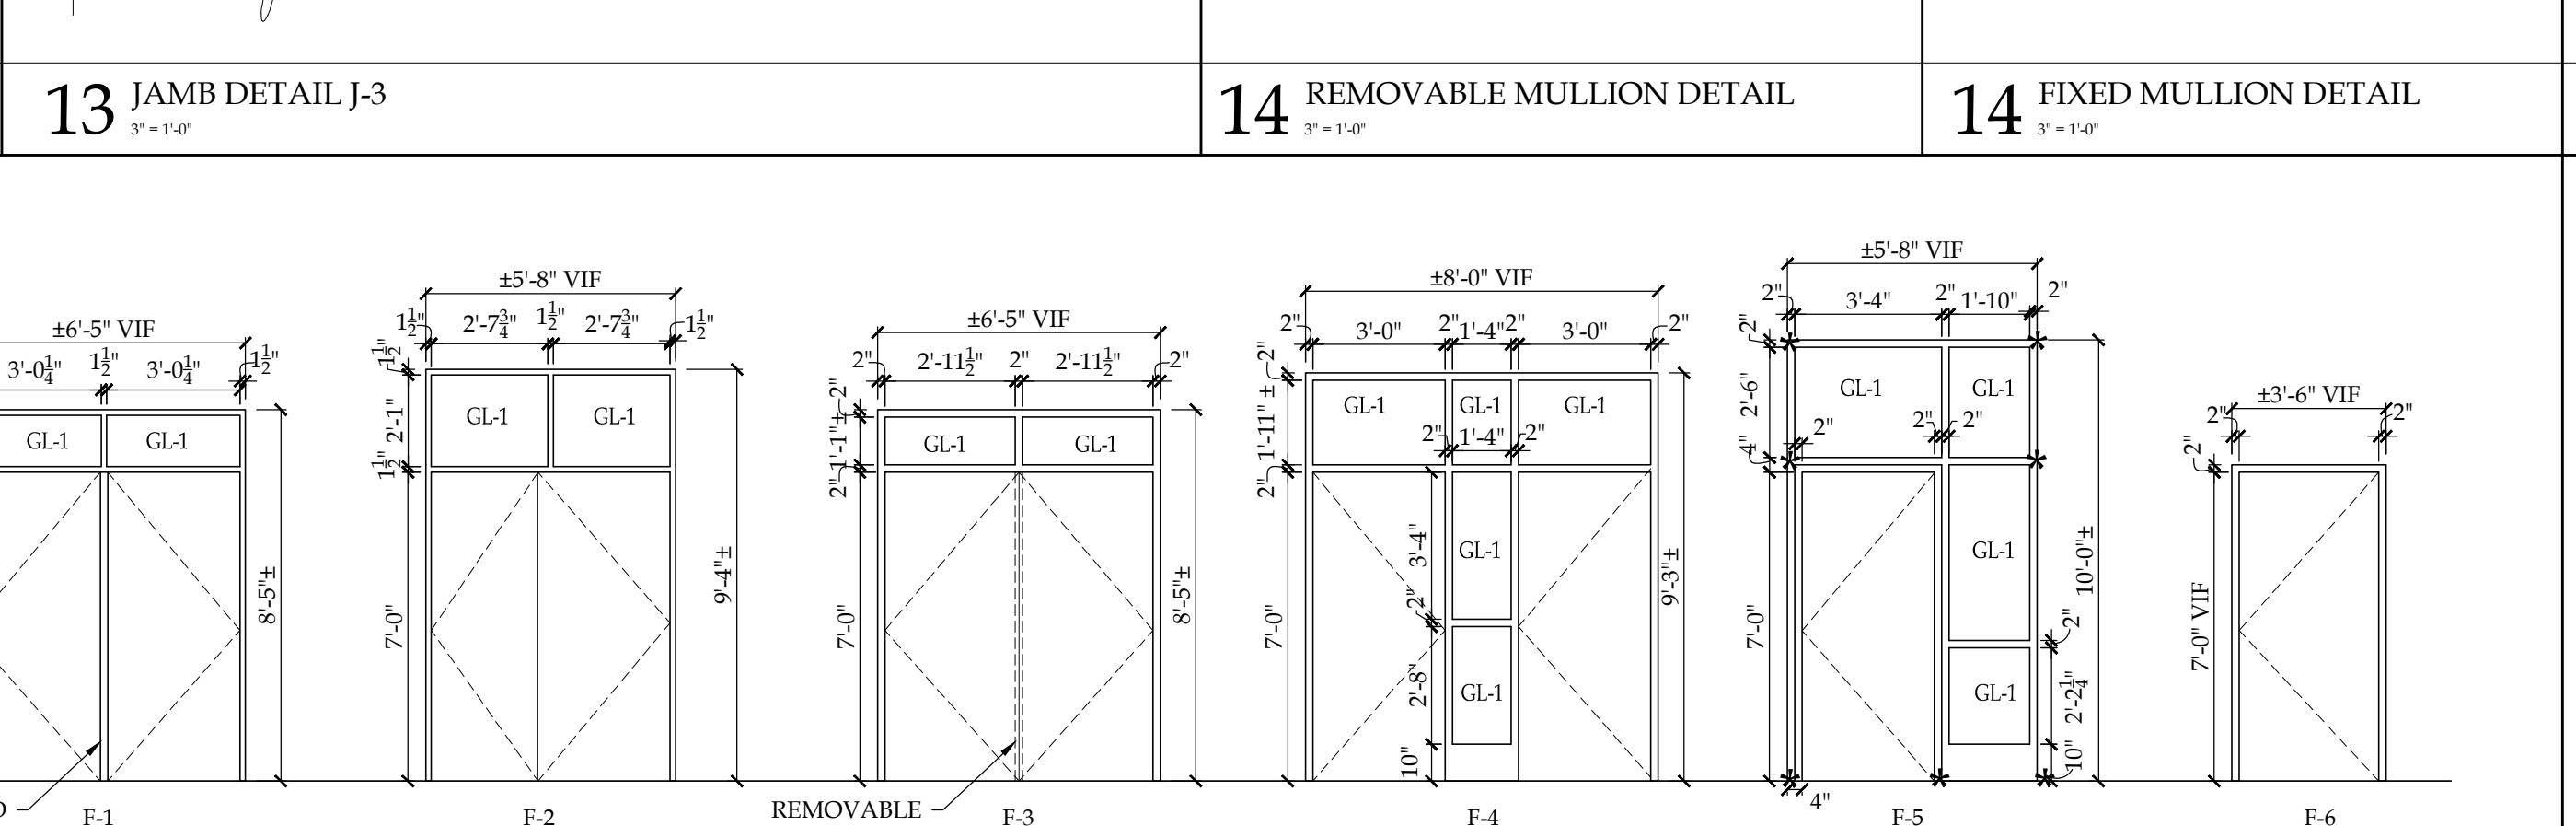
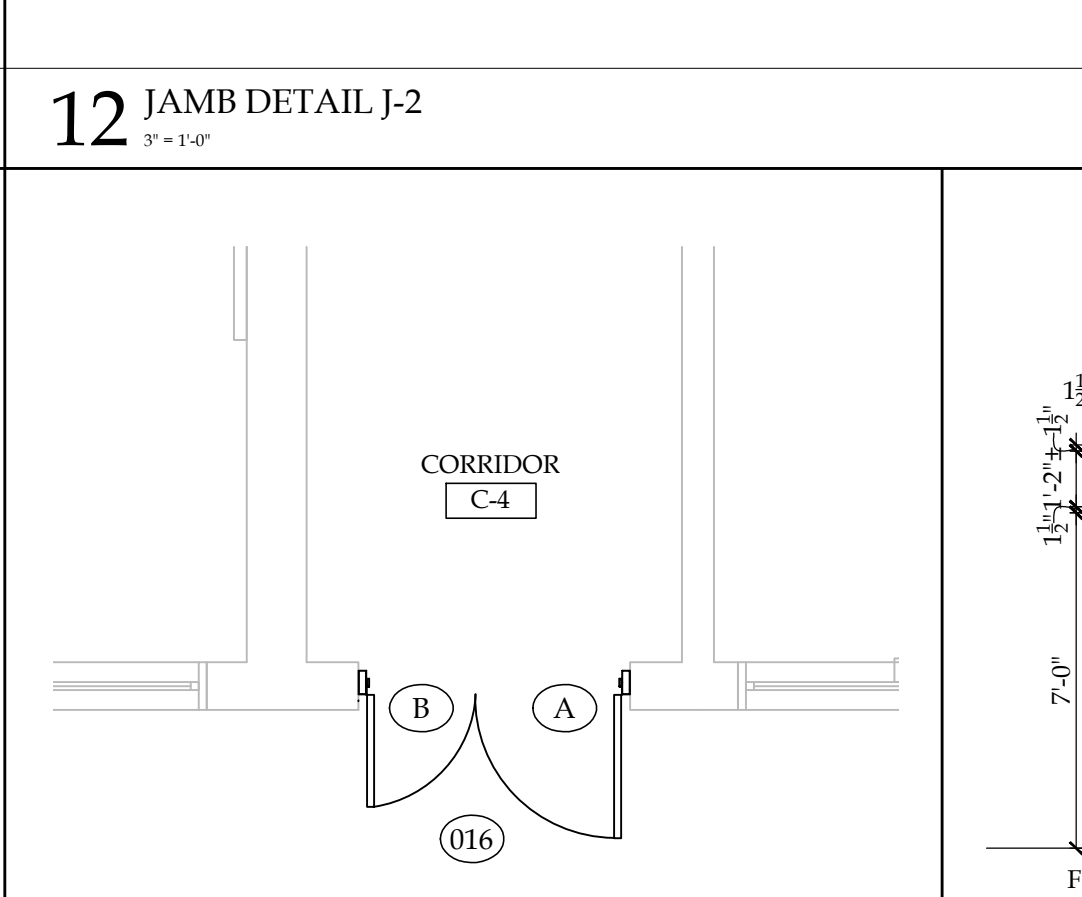
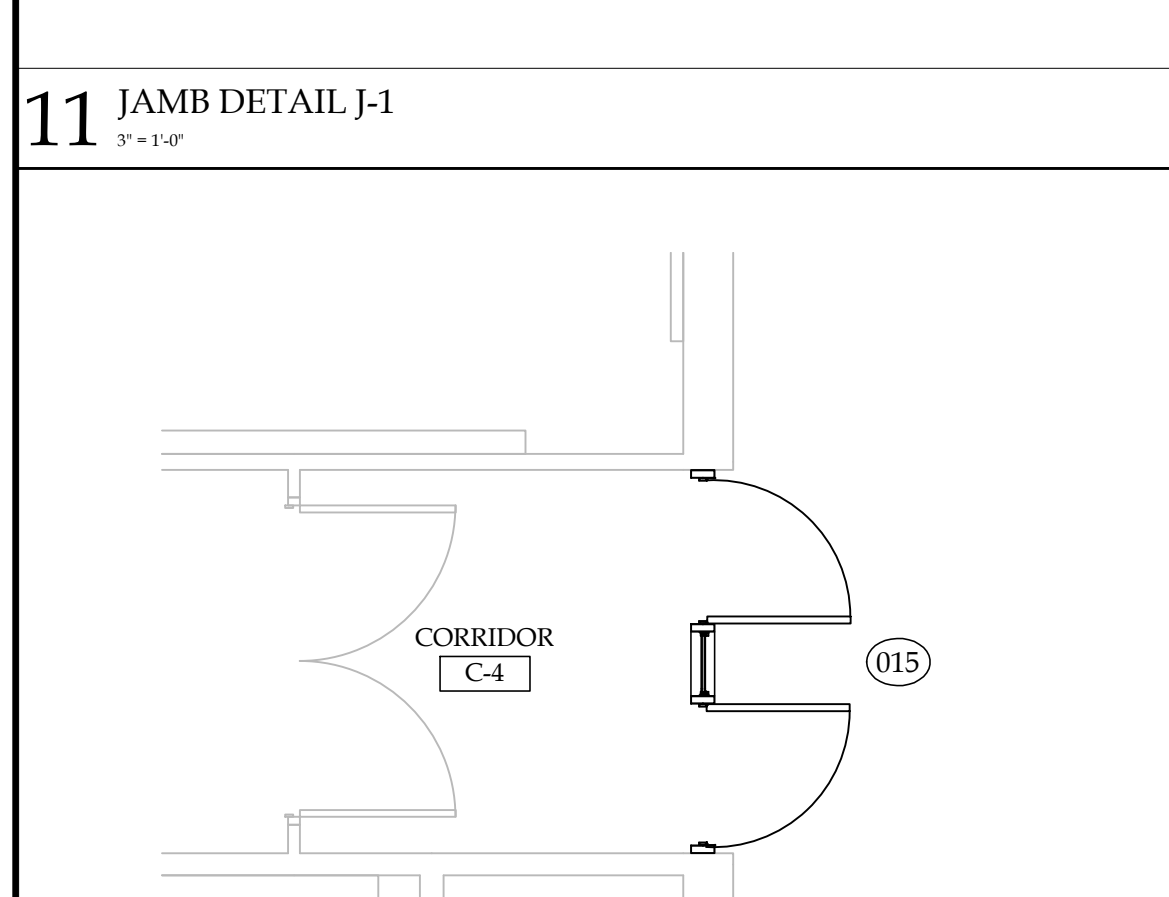
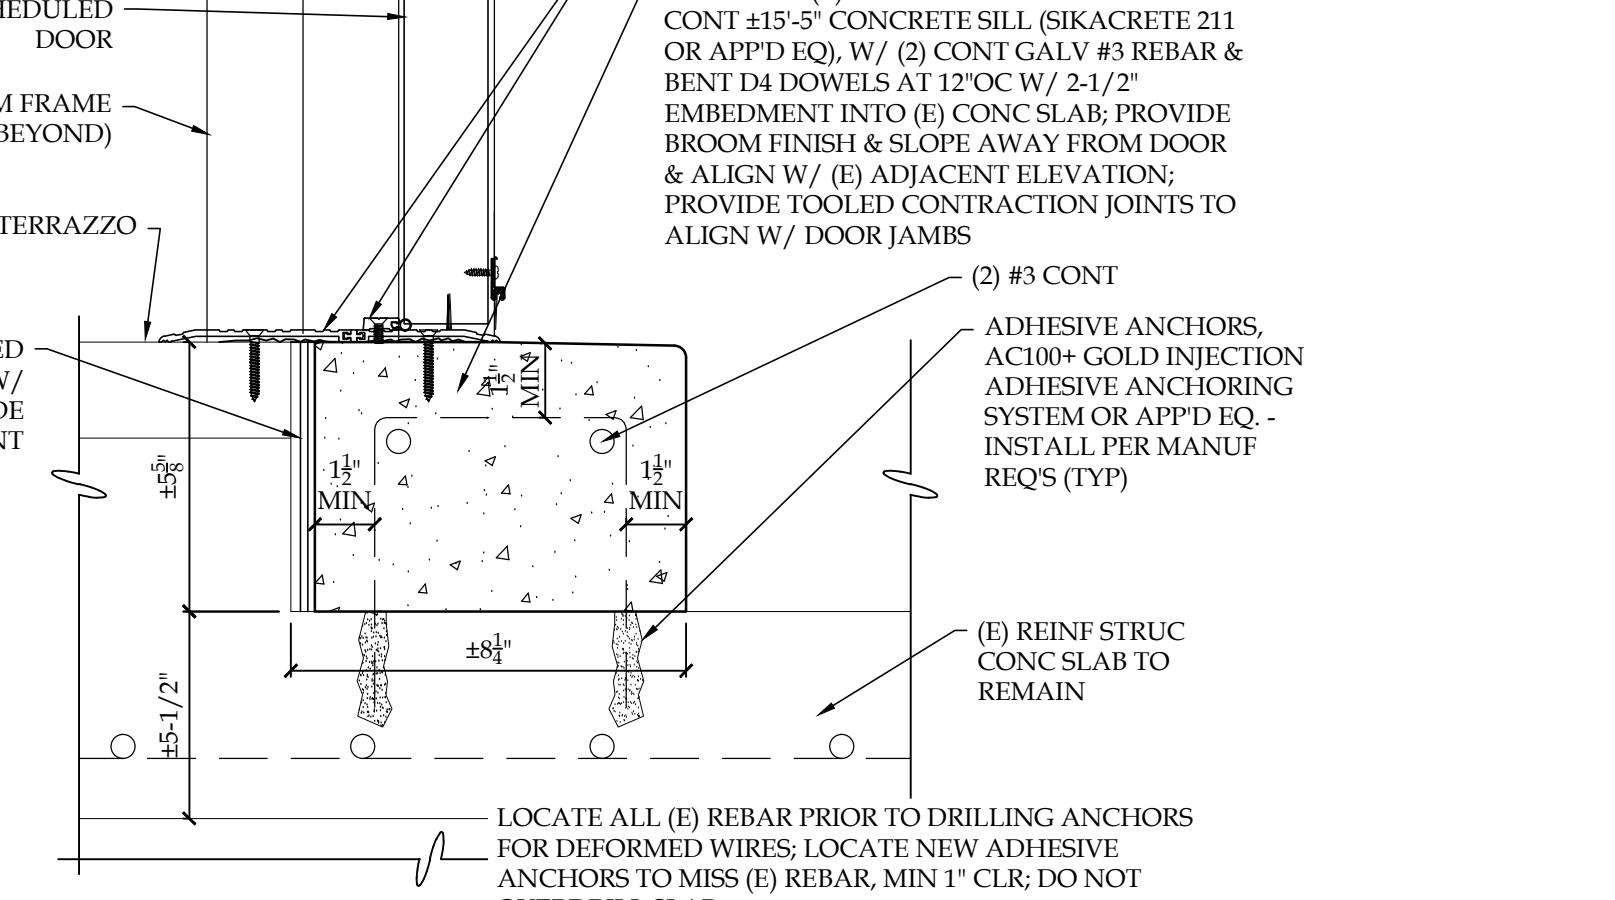
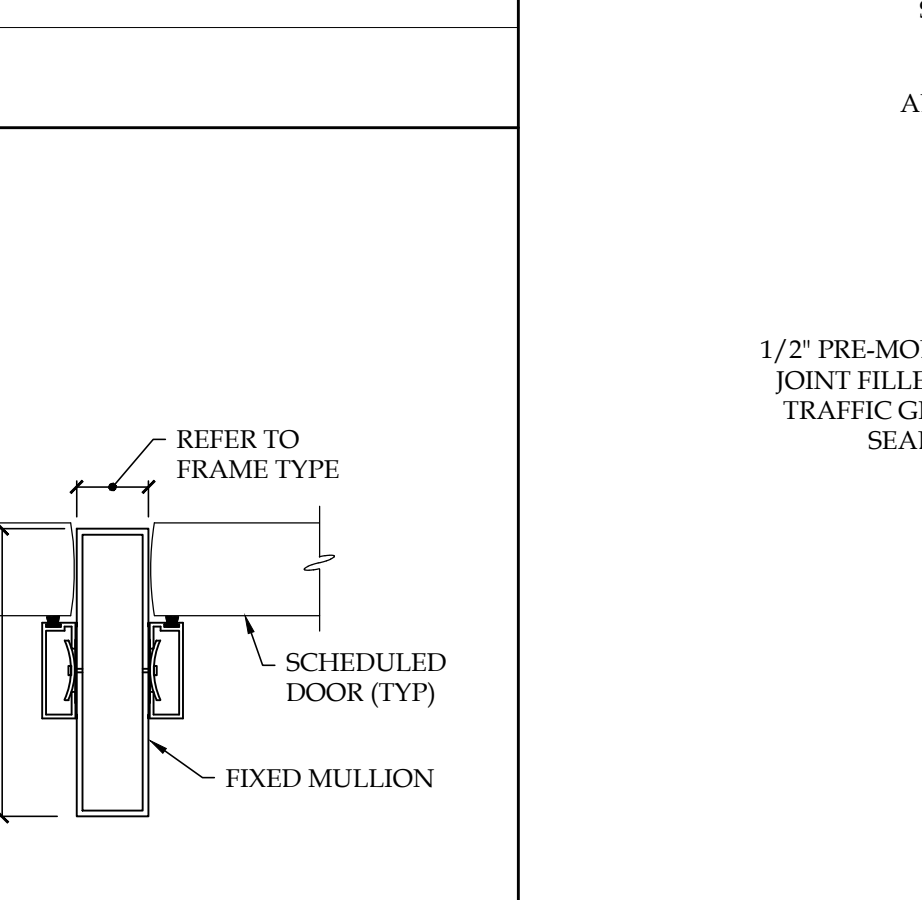
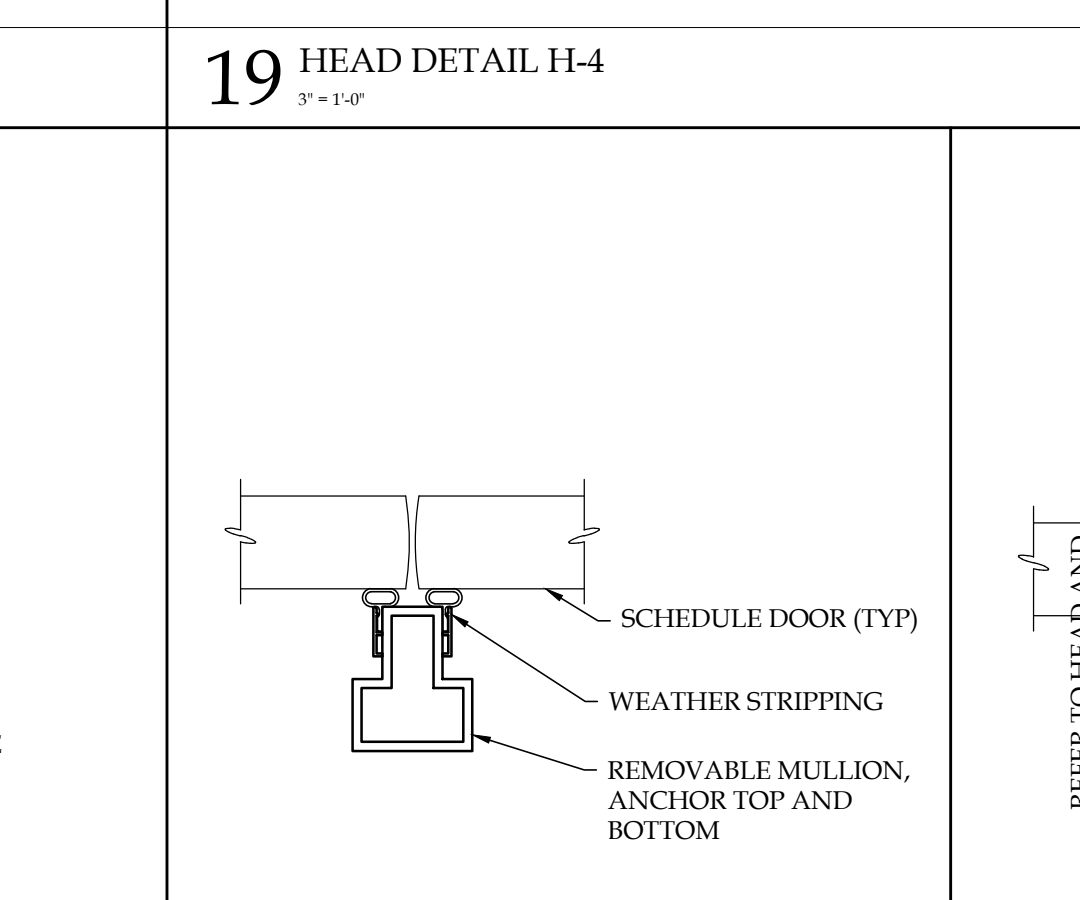
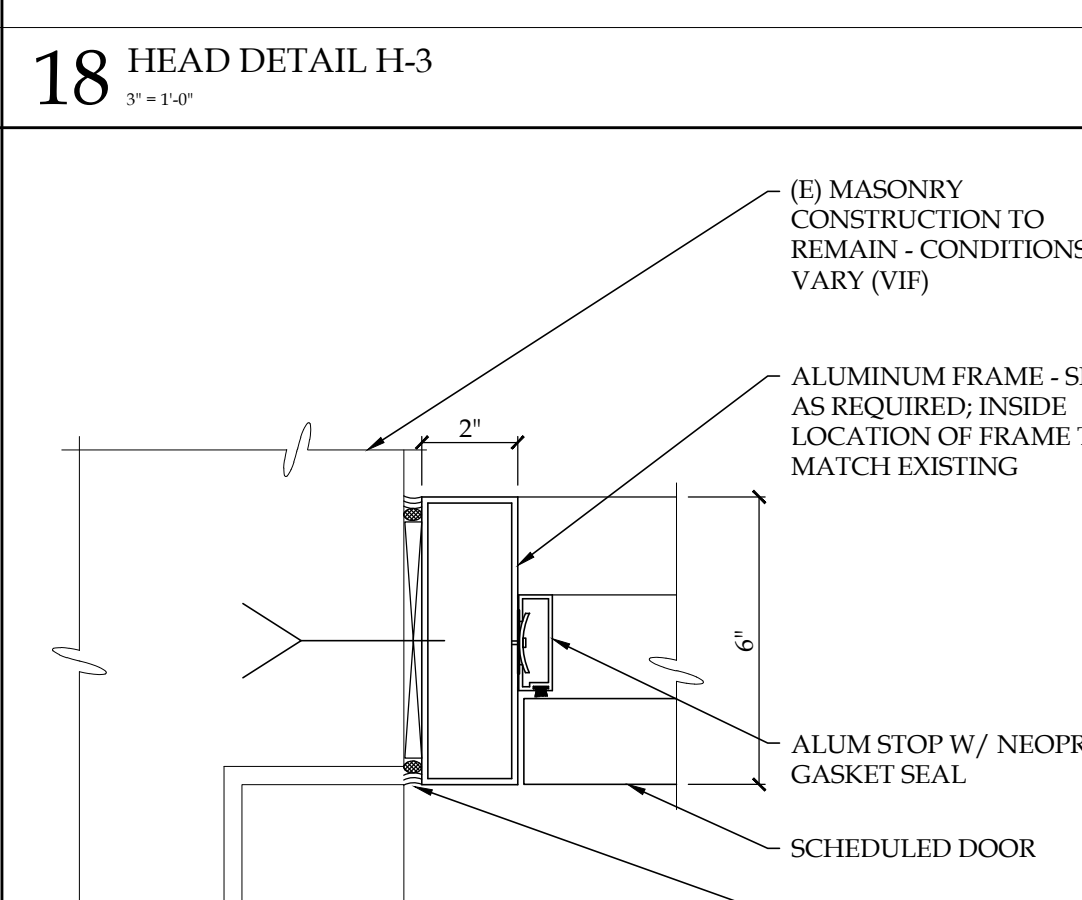
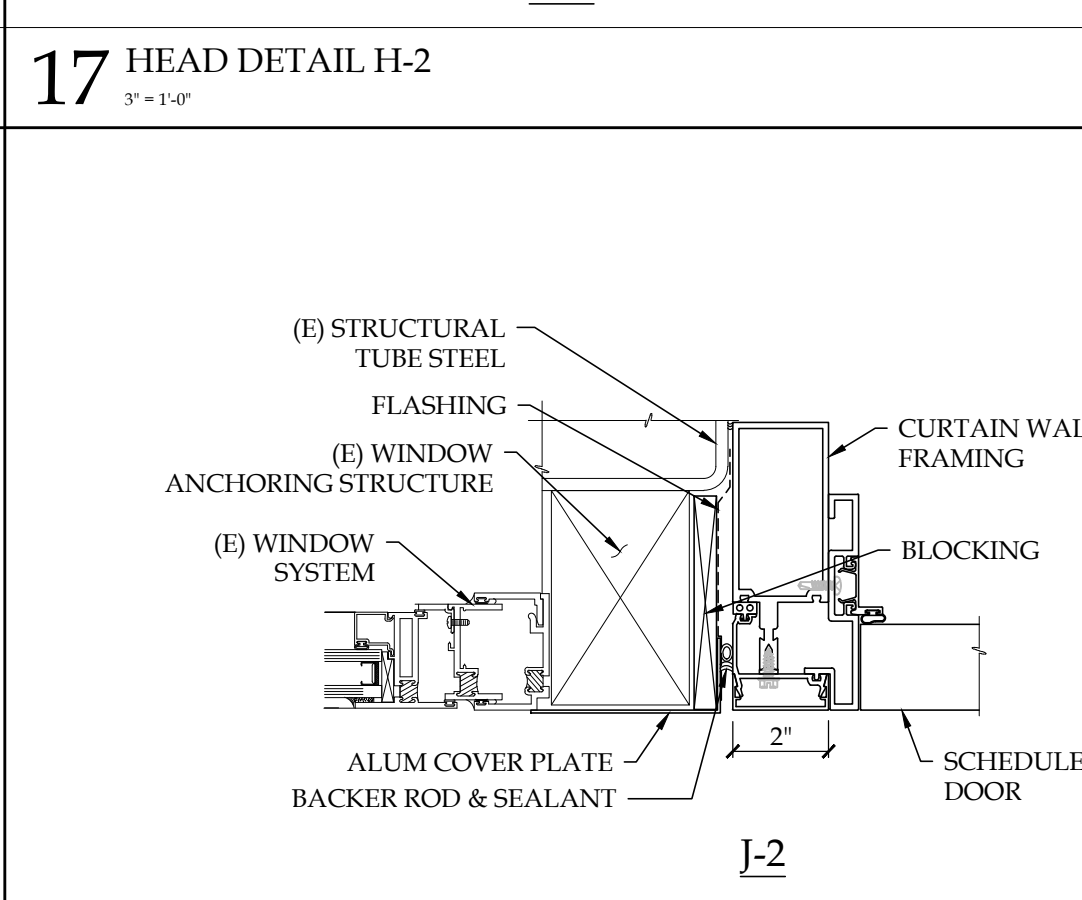
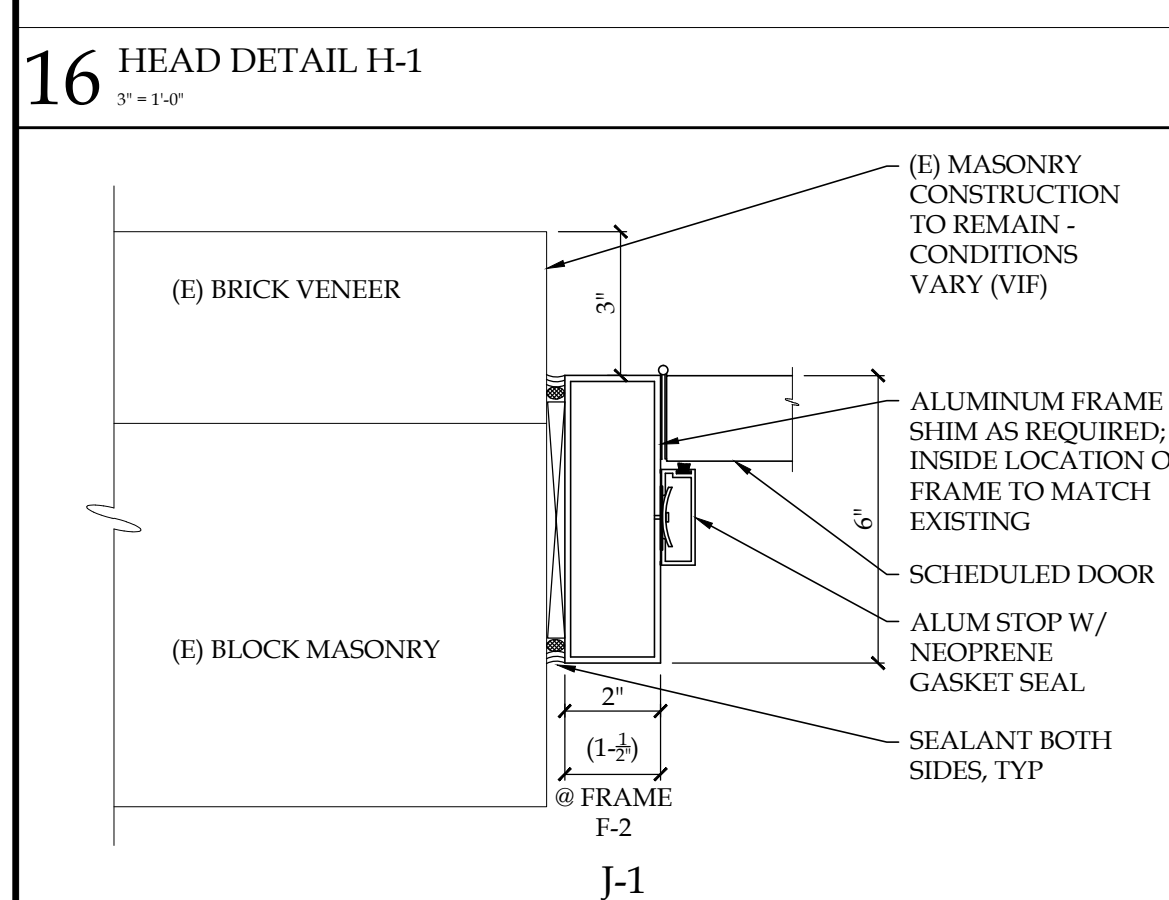
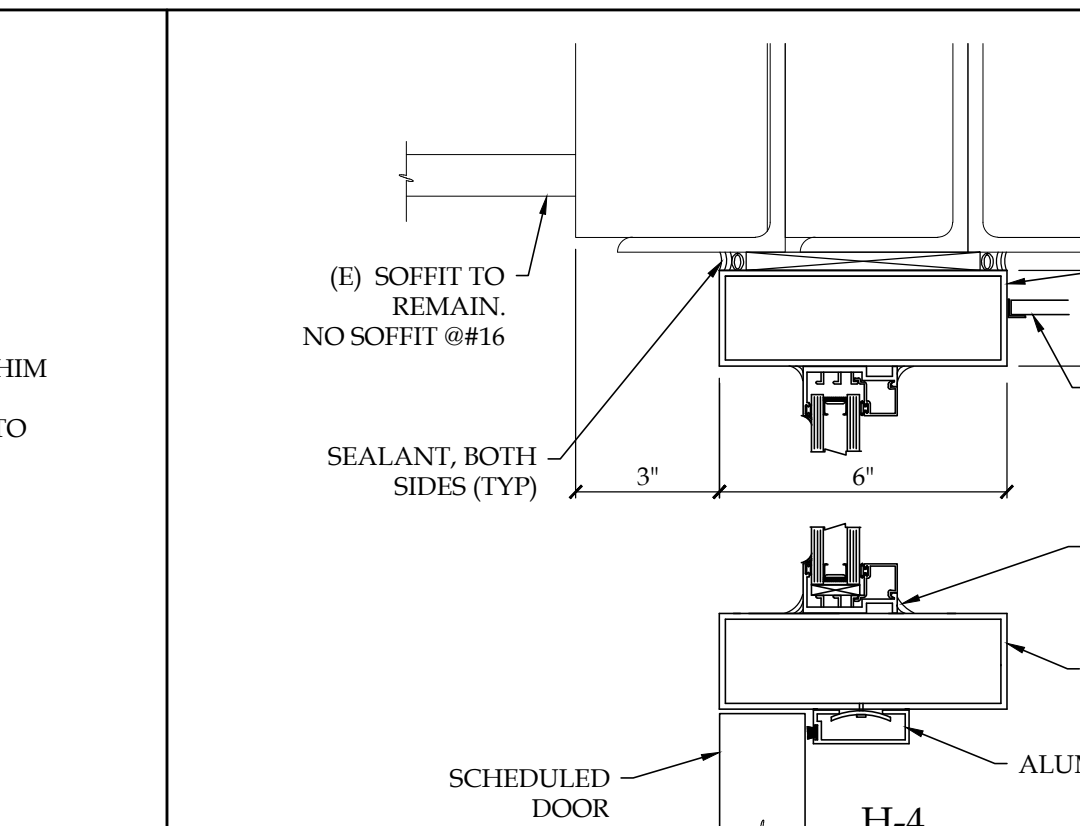
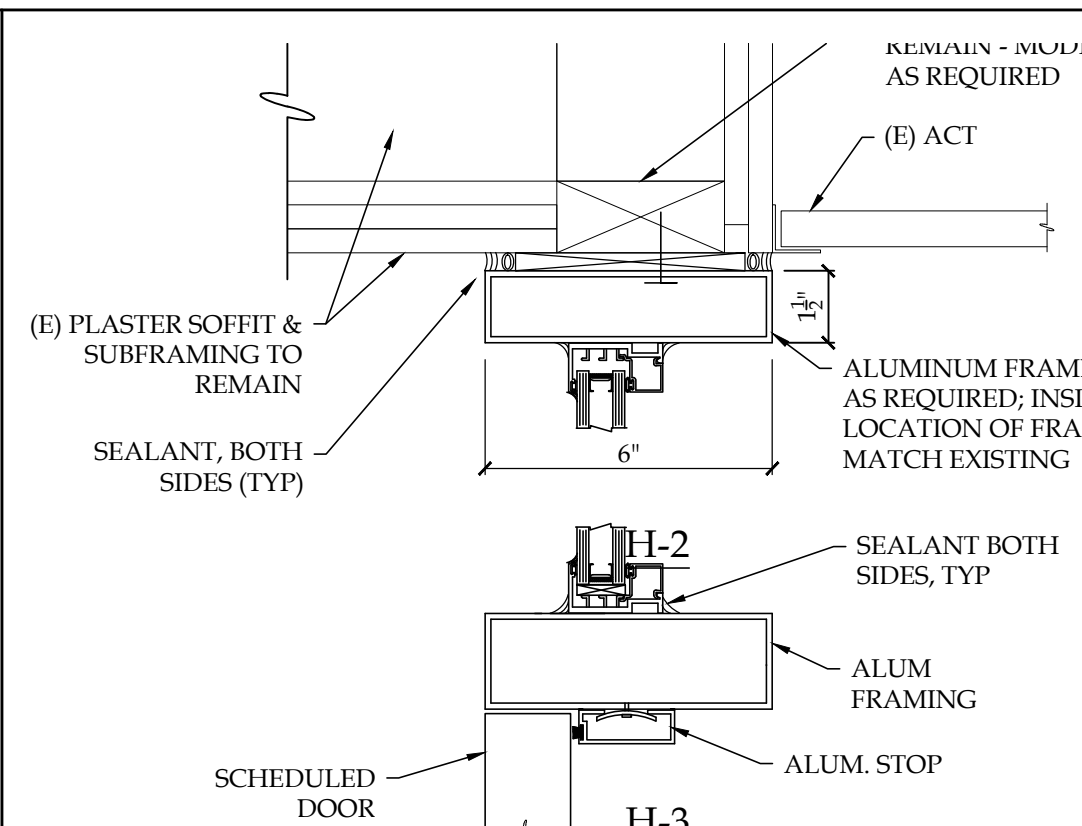
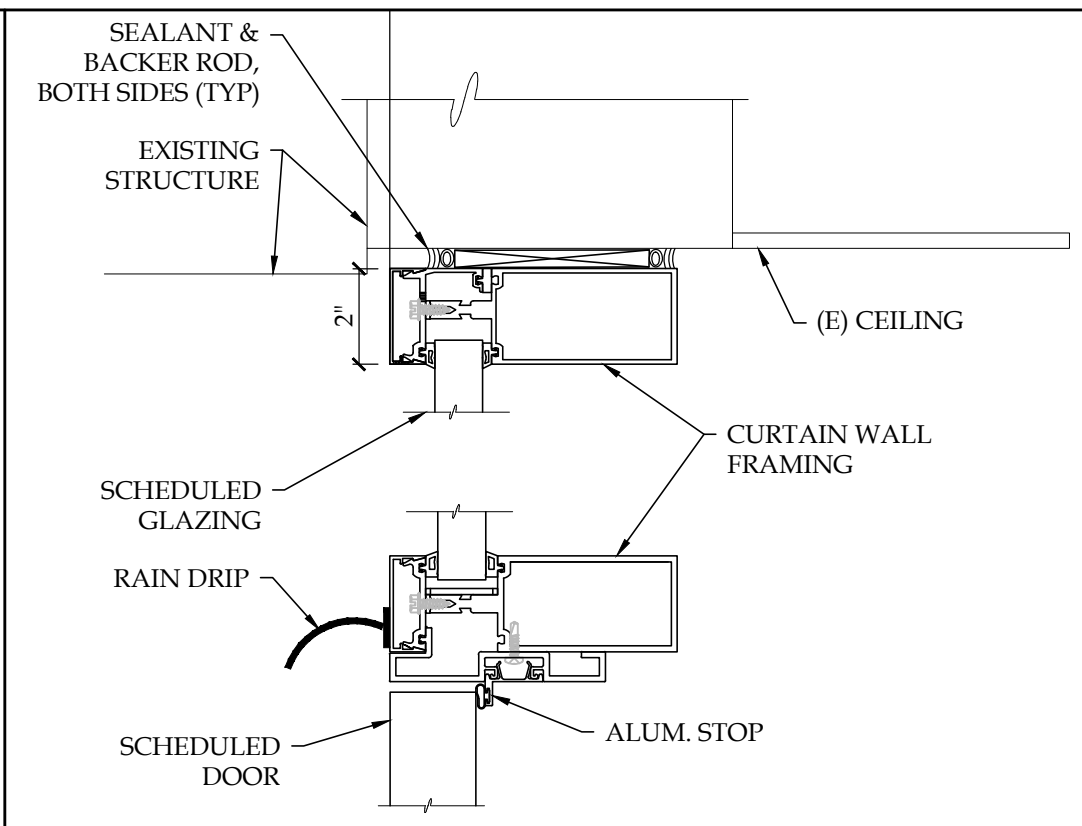
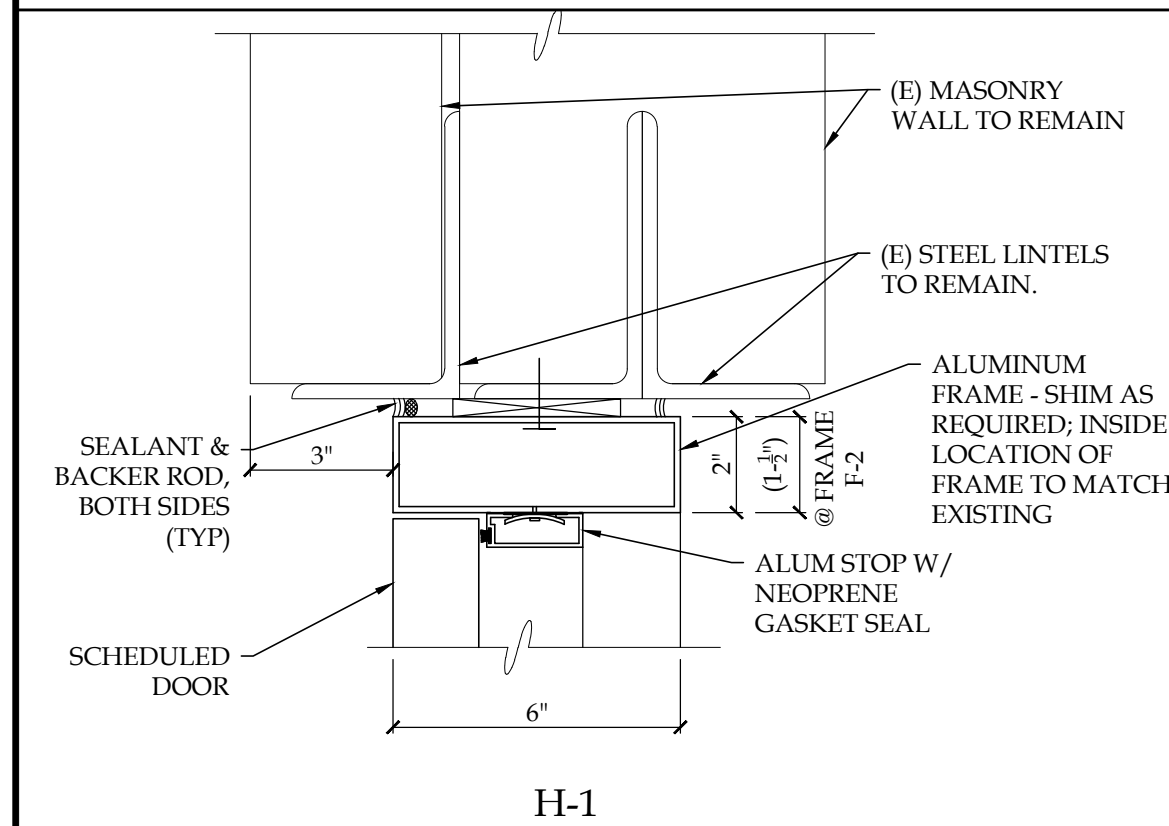
EGRESS ANALYSIS

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 W: www.becica.com

Signature/Date
 STEVEN A. BECICA, R.A., N.J. 21A101137600

Exterior Door Replacement
 & Related Work at the
 Kingston Elementary School
 320 KINGSTON ROAD, CHERRY HILL, NEW JERSEY 08034
 Lot: 17 Block: 339.05

Cherry Hill Board Of Education
 PO Box 5015, 45 Randolph Terrace, Cherry Hill, New Jersey 08034

Contractor shall check and verify all conditions and dimensions at the site before proceeding with this work.

#	Date	Description

Set Issue:
 Issued for Bidding
 Issue Date: April 5, 2019
 Drawing Title:
**Plans, Details
 Notes & Schedules**
 Drawn by: _____ Checked by: _____
 Project Number:
19CHS-07020
 DOE State Plan Number #:
 Drawing Number:
A-1.1

DOOR SCHEDULE

DOOR NUMBER	DOOR				FRAME				MISCELLANEOUS				REMARKS		
	SIZE		DOOR TYPE	# OF LEAVES	DOOR MATL	DOOR THICKN	FRAME TYPE	FRAME MATERIAL	MULLION	JAMB	HEAD	THRESHOLD		H.W.SET	GLASS
	WIDTH	HEIGHT													
2	3'-0" 2'-4"	7'-0"	D-1	2	FRP	1-3/4"	F-1	ALUM	-	J-1	H-1	T-1	4.1	-	
3	3'-0" 2'-0"	7'-0"	D-1	2	FRP	1-3/4"	F-3	ALUM	REMOVABLE	J-1	H-1	T-1	6.1*	-	* FLUSH PULL FPN3 INTEGRAL WITH DOOR BY DOOR MANUFACTURE
4	3'-0" 2'-0"	7'-0"	D-1	2	FRP	1-3/4"	F-1	ALUM	-	J-1	H-1	T-1	12*	-	* FLUSH PULL FPN3 INTEGRAL WITH DOOR BY DOOR MANUFACTURE
5	3'-0" 2'-0"	7'-0"	D-1	2	FRP	1-3/4"	F-1	ALUM	-	J-1	H-1	T-1	12*	-	* FLUSH PULL FPN3 INTEGRAL WITH DOOR BY DOOR MANUFACTURE
6	3'-1"	7'-0"	D-2	2	FRP	1-3/4"	F-2	ALUM	FIXED	J-2	H-2	T-1	7.1	GL-1	
11	3'-2"	7'-0"	D-2	2	FRP	1-3/4"	F-3	ALUM	REMOVABLE	J-1	H-1	T-1	8	GL-1	
15A/15B	3'-4"	7'-0"	D-2	2	FRP	1-3/4"	F-4	ALUM	REMOVABLE	J-1	H-1	T-1	8	GL-1	
15C	3'-5"	7'-1"	D-2	1	FRP	1-3/4"	F-4	ALUM	-	J-1	H-1	T-1	10	GL-1	

DOOR SCHEDULE NOTES:

- (E) STEEL LINTELS ABOVE OPENING TO BE SCRAPPED, CLEANED, PRIMED & PAINTED
- DOOR & FRAME TO RECEIVE ELECTRICAL POWER TRANSFER FOR FUTURE CARD ACCESS- SEE HARDWARE SCHEDULE. CONTRACTOR TO TERMINATE CONTROL WIRING AND COIL ABOVE CEILING FOR FUTURE CONNECTION TO OWNER PROVIDED POWER SUPPLY.
- PROVIDE HEAD & JAMB ANGLE TRIM AT FRAME EXTERIOR TO MATCH NEW FRAME.

GLAZING SCHEDULE

GL-1: 1" INSULATED, LAMINATED, TINTED (EVERGREEN), SAFETY GLAZING

GENERAL DOOR / FRAME NOTES:

- DEMOLISH (E) FRAME & DOOR SYSTEMS IN THEIR ENTIRETY AT ALL LOCATIONS TO RECEIVE NEW DOOR AND FRAMES AS INDICATED; PREPARE ADJACENT FINISHES TO ACCOMMODATE NEW ALUMINUM FRAME & DOORS COLORS TO BE SELECTED BY ARCHITECT
- REPAIR (E) FINISHES TO MATCH (E) ADJACENT AS REQ'D TO ACCOMMODATE NEW WORK.
- FASTENER SELECTION AND PATTERN SHALL COMPLY WITH DESIGN LOADS.

LEGEND

ALUM (E) ALUMINUM EXISTING TO REMAIN
 (ER) EXISTING RELOCATED
 FRP FIBERGLASS REINFORCED POLYESTER
 (R) REMOVE EXISTING
 (RE) RELOCATE EXISTING
 V.I.F. VERIFY IN FIELD

CODE ANALYSIS

APPLICABLE CODES
 BUILDING SUBCODE EDITION INTERNATIONAL BUILDING CODE / 2015, NEW JERSEY ICC / ANSI A117.1 - 2009 INTERNATIONAL FIRE CODE / 2015
 ELECTRICAL SUBCODE NATIONAL ELECTRICAL CODE / 2015
 REHABILITATION SUBCODE NJUCC, SUBCHAPTER 6

BUILDING ANALYSIS
 (FROM IBC 2015 - NEW JERSEY EDITION)


THE FLOOR PLAN AREA AND HEIGHT OF THE SCHOOL BUILDING HAS NOT CHANGED UNDER THIS PROJECT, THEREFORE NO ANALYSIS OF THE EXISTING BUILDING HAS BEEN PROVIDED.

EGRESS ANALYSIS
 (FROM NEW JERSEY REHABILITATION SUBCODE 523-6)


THE OCCUPANT LOAD OF THE SCHOOL HAS NOT CHANGED UNDER THIS PROJECT, THEREFORE AN EGRESS ANALYSIS HAS NOT BEEN PROVIDED.

GENERAL NOTES:

- THE WORK IS GOVERNED BY THE NIUCC AND SUBCODES OF THE INTERNATIONAL BUILDING CODE 2015, NJ EDITION AND AS AMENDED BY THE PROJECT DOCUMENTS.
- THE CONTRACTOR IS RESPONSIBLE TO SECURE ALL PERMITS, TO OBTAIN APPROVALS AS REQUIRED AND COORDINATE INSPECTION WITH LOCAL BUILDING INSPECTOR. ALL PERMIT AND APPLICATION FEES WILL BE PAID BY THE OWNER AND DELIVERED BY THE CONTRACTOR.
- DRAWINGS & SPECIFICATIONS COMPLIMENT EACH OTHER. WORK NOT SHOWN ON DRAWINGS BUT CALLED FOR IN THE SPECIFICATIONS IS STILL REQUIRED, AND ALL WORK NOT CALLED FOR IN SPECIFICATIONS, BUT CALLED OUT OR SHOWN IN DRAWINGS IS STILL REQUIRED.
- ALL CONTRACTORS ARE ADVISED TO VISIT THE SITE AND VERIFY ALL AREAS, DIMENSIONS, AND CONDITIONS PRIOR TO SUBMITTING THEIR BIDS. THE CONTRACTOR MUST NOTIFY THE ARCHITECT OF ANY DISCREPANCIES AND/OR OMISSIONS IN WRITING AT LEAST TEN DAYS PRIOR TO THE RECEIPT OF BIDS. FAILURE TO SO NOTIFY THE ARCHITECT INDICATES THAT ANY ADDITIONAL COSTS ASSOCIATED WITH THE DISCREPANCIES AND / OR OMISSIONS ARE INCLUDED IN THE CONTRACTORS BID AND THAT NO CHANGE TO THE CONTRACT AMOUNT WILL BE MADE AFTER THE RECEIPT OF BIDS OR THE AWARD OF CONTRACTS.
- DRAWINGS INDICATE GENERAL AND TYPICAL DETAILS OF CONSTRUCTION. WHERE CONDITIONS ARE NOT SPECIFICALLY SHOWN, SIMILAR DETAILS OF CONSTRUCTION SHALL BE USED, SUBJECT TO REVIEW AND APPROVAL OF THE ARCHITECT AND ENGINEER.
- THE CONTRACTOR SHALL MAINTAIN FULL WORK SITE SAFETY & SECURITY AT ALL TIMES. THE CONTRACTOR SHALL PROVIDE TEMPORARY BARRICADES, ENCLOSURES AND ANY OTHER FORMS OF PROTECTION REQUIRED TO PROTECT THE BUILDING OCCUPANTS AND GENERAL PUBLIC FROM INJURY.
- THE CONTRACTOR IS RESPONSIBLE FOR ALL WORK, MATERIAL, EQUIPMENT, AND LABOR TO PROVIDE A COMPLETE, FINISHED, AND FUNCTIONAL SYSTEM WHETHER SPECIFIED OR IMPLIED.
- CONFINE ACTIVITIES TO THE IMMEDIATE WORK AREA ONLY. UTILIZE ONLY THOSE UTILITIES AND FACILITIES AS DESIGNATED BY THE OWNER. CONTRACTOR ACCESS BY PERSONNEL, PARKING, AND MATERIAL STORAGE SHALL BE ONLY IN AREAS DESIGNATED BY THE OWNER.
- DURING CONSTRUCTION, CLEAN AND PROTECT WORK IN PROGRESS. PROMPTLY REMOVE ANY DEBRIS FROM THE SITE. NO TRASH ACCUMULATION IS PERMITTED. TRANSPORT AND LEGALLY DISPOSE OF MATERIAL OFF SITE.
- INSPECT AND DOCUMENT EXISTING CONDITIONS, SURFACES, FINISHES, FURNISHINGS, EQUIPMENT, ETC IN THE VICINITY OF THE WORK WITH THE OWNER PRIOR TO COMMENCING THE WORK. RESTORE ALL CONDITIONS, ETC., DAMAGED BY THE WORK TO THE PRECONSTRUCTION CONDITION AND TO THE OWNER'S SATISFACTION.
- ALL ELECTRICAL WORK SHALL BE PERFORMED BY A NJ LICENSED ELECTRICAL CONTRACTOR IN STRICT COMPLIANCE WITH THE N.E.C.
- EXTERIOR WALLS SHALL REMAIN IN PLACE FOR SECURITY & WEATHER PROTECTION UNTIL SUCH TIME AS THEY CAN BE REMOVED AND REPLACED WITH NEW CONSTRUCTION TO PROVIDE SECURITY & WEATHER PROTECTION WITHIN THE SAME WORK DAY WHILE PROJECT IS STAFFED BY CONTRACTOR.
- PERFORM ALL DEMOLITION AND REMOVAL WORK IN SUCH A MANNER AS NOT TO REDUCE THE LOAD-CARRYING CAPACITY ABILITIES OF ANY STRUCTURAL MEMBERS, WALLS, ELEMENTS, ETC. PROVIDE SHORING DURING CONSTRUCTION TO SUITE CONDITIONS.
- COORDINATE ALL SERVICE AND UTILITY INTERRUPTIONS WITH THE OWNER TO AVOID INTERRUPTING THE OWNER'S OPERATIONS.

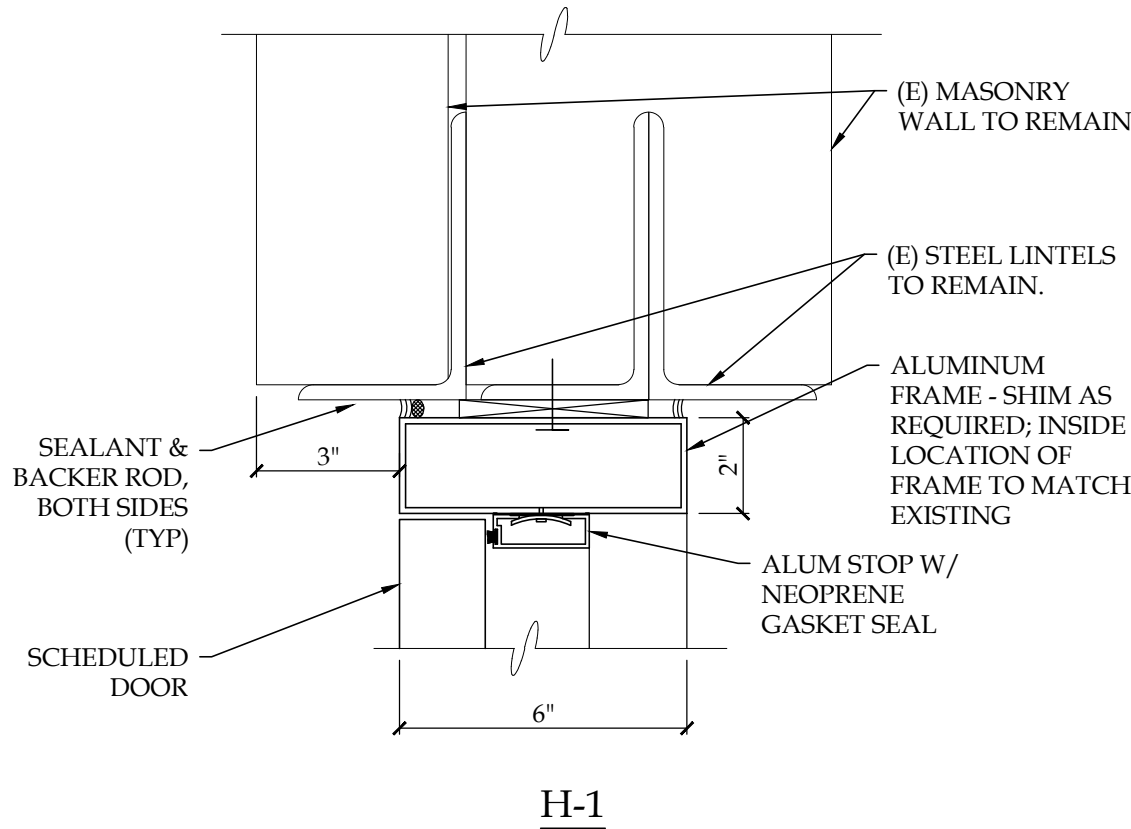


H-1

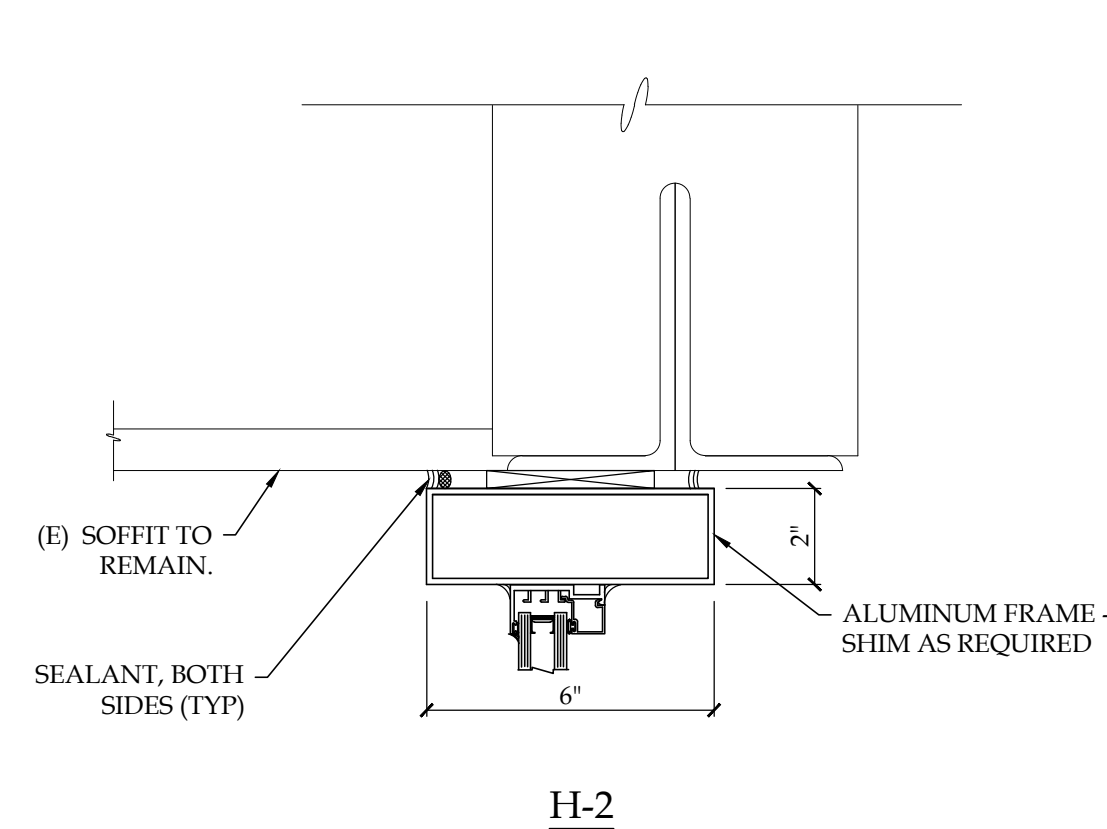


H-2

14 HEAD DETAIL H-1

15 HEAD DETAIL H-2

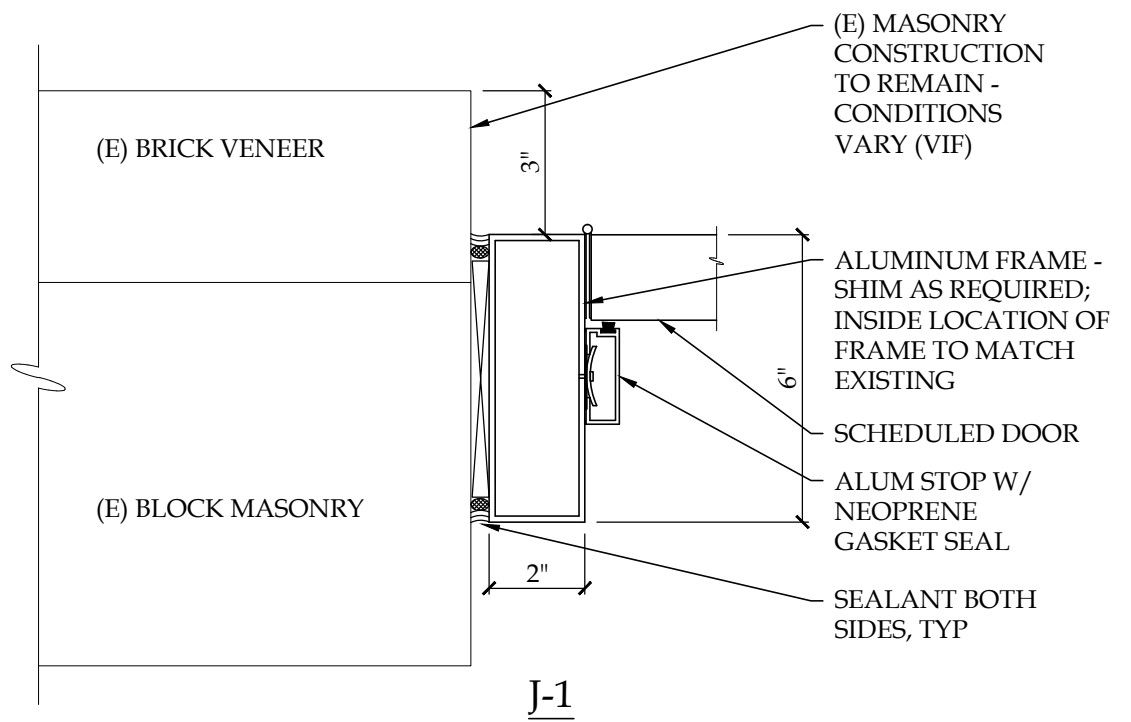


J-1

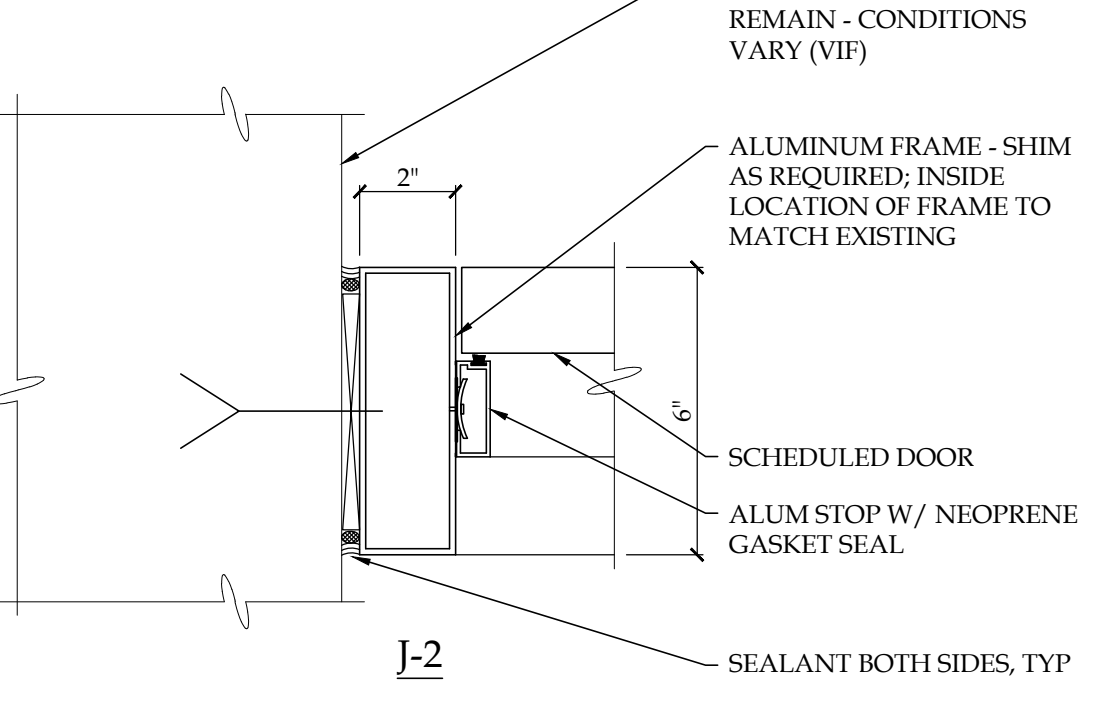


J-2

12 JAMB DETAIL J-1


13 JAMB DETAIL J-2

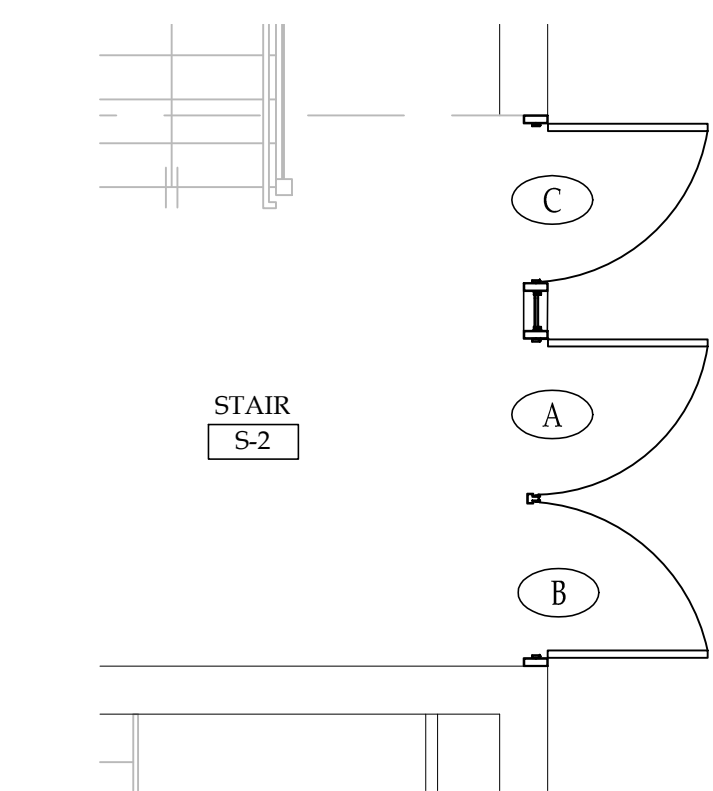


6 PARTIAL FLOOR PLAN @ DOOR #015

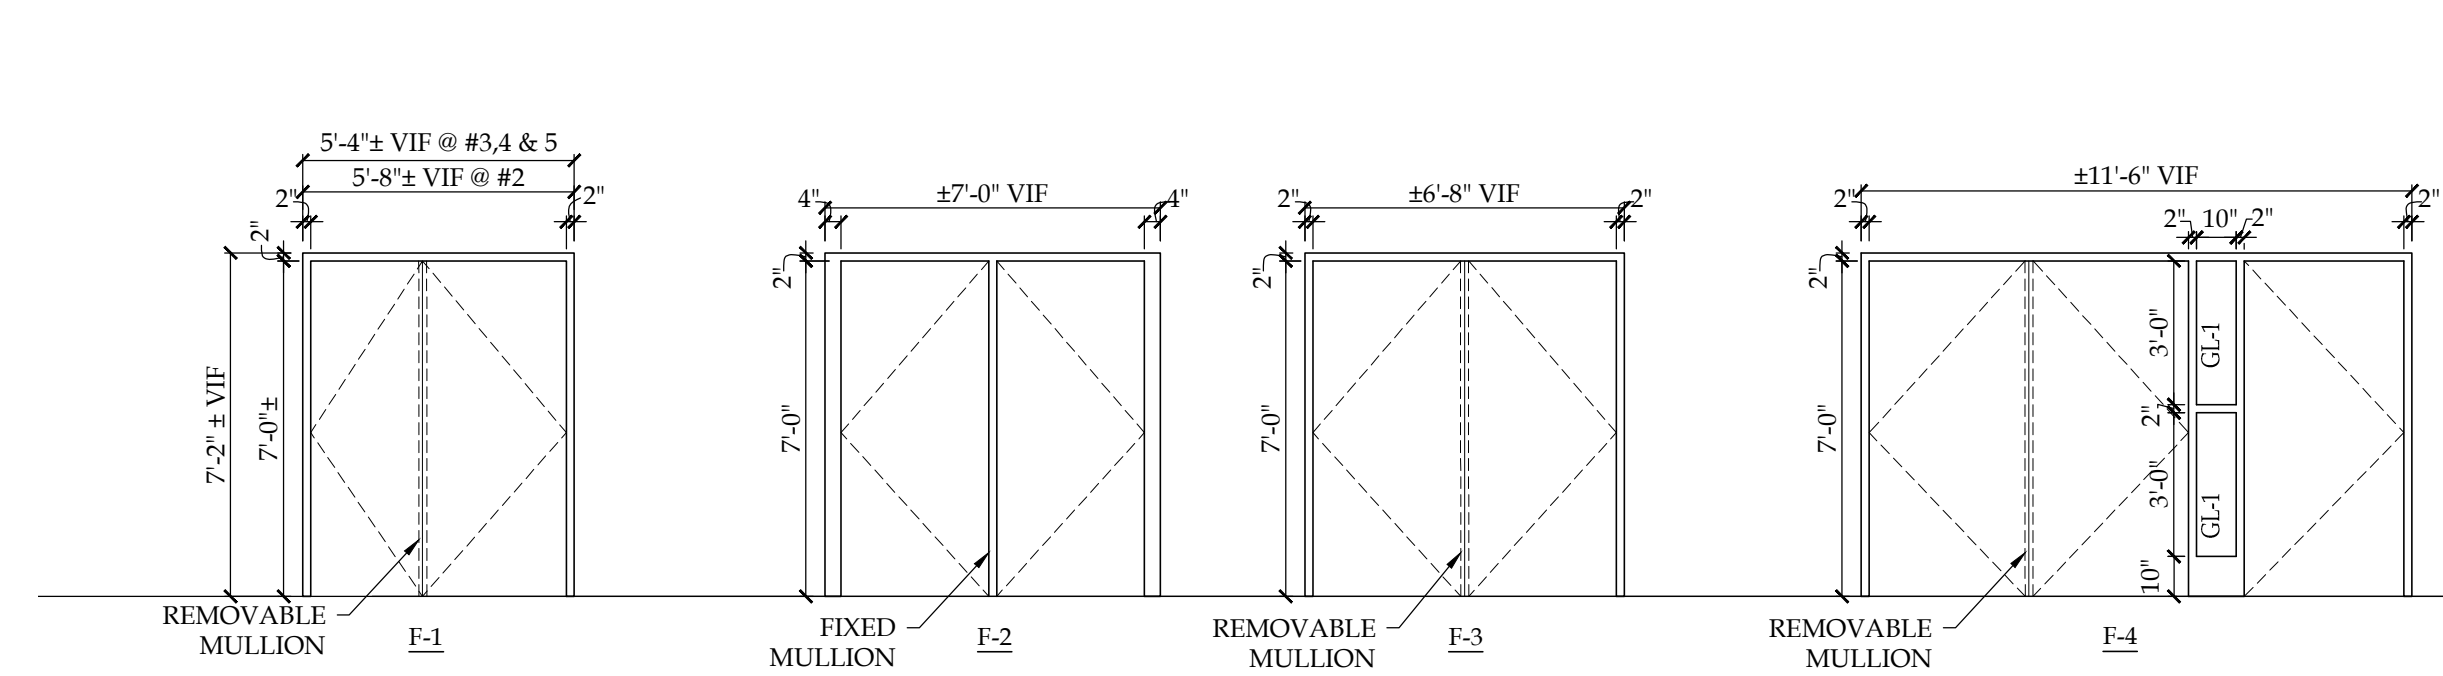


7 DOOR FRAME TYPES

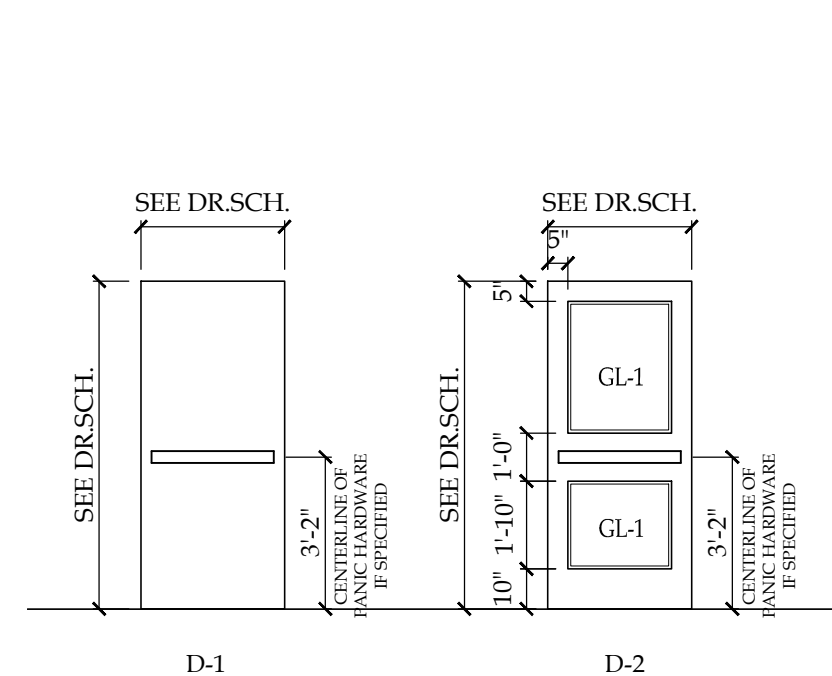


8 DOOR TYPES

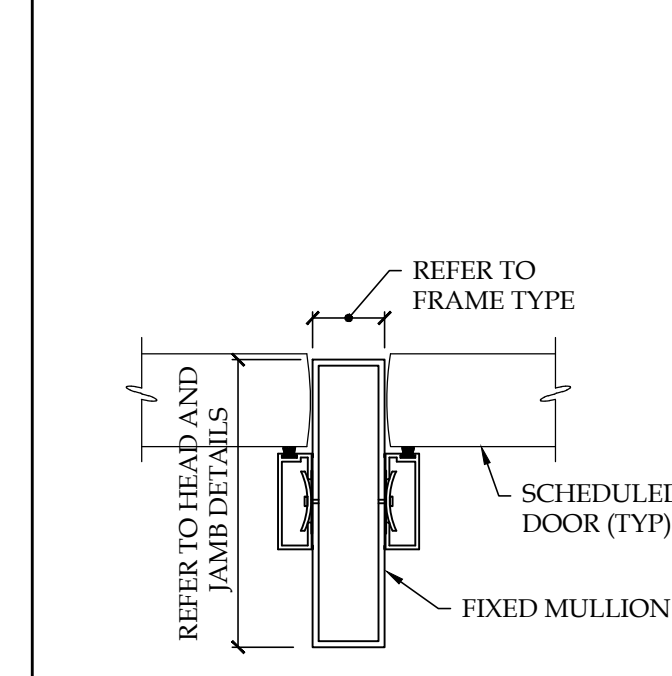


9 FIXED MULLION DETAIL

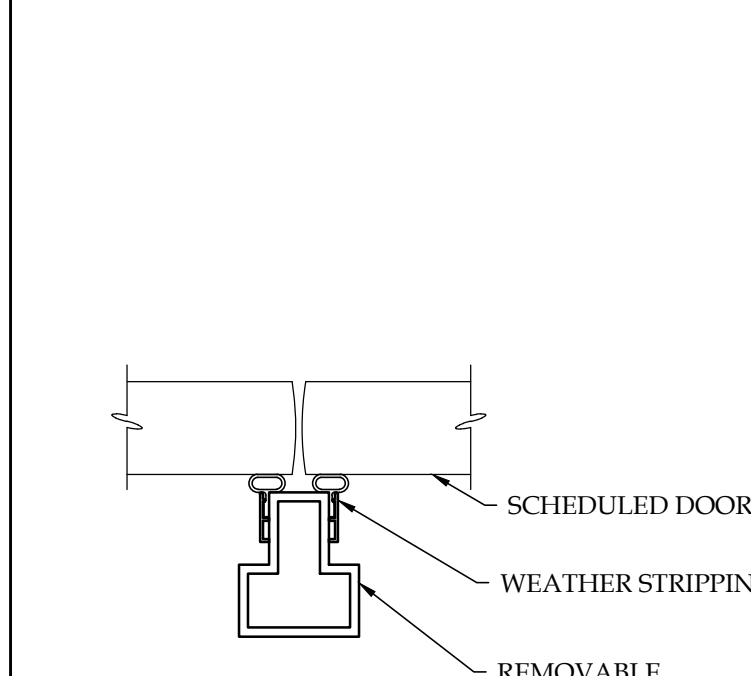


10 REMOVABLE MULLION DETAIL

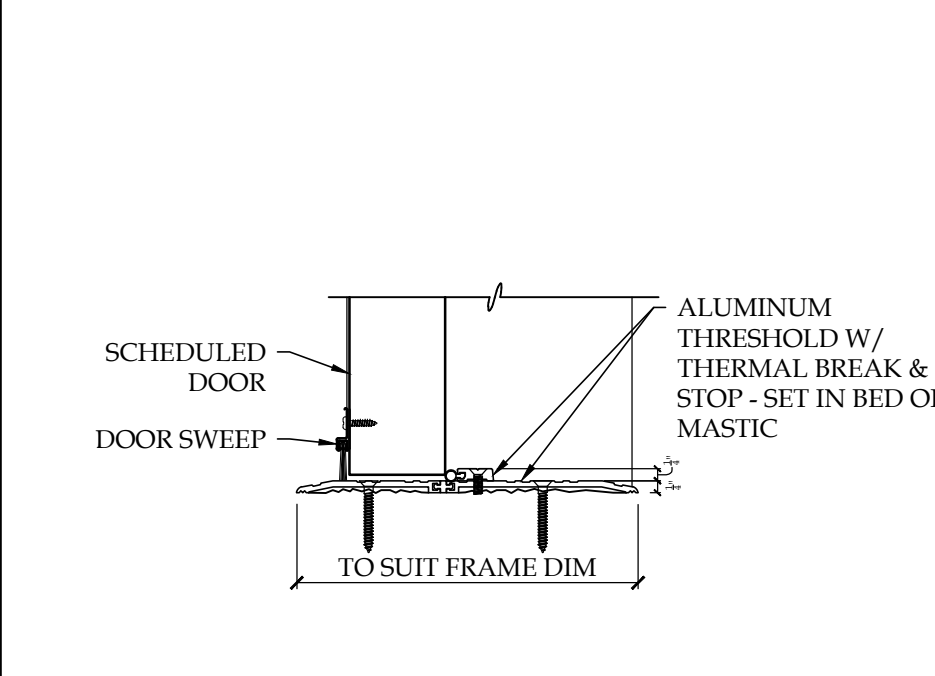


11 THRESHOLD T-1 DETAIL

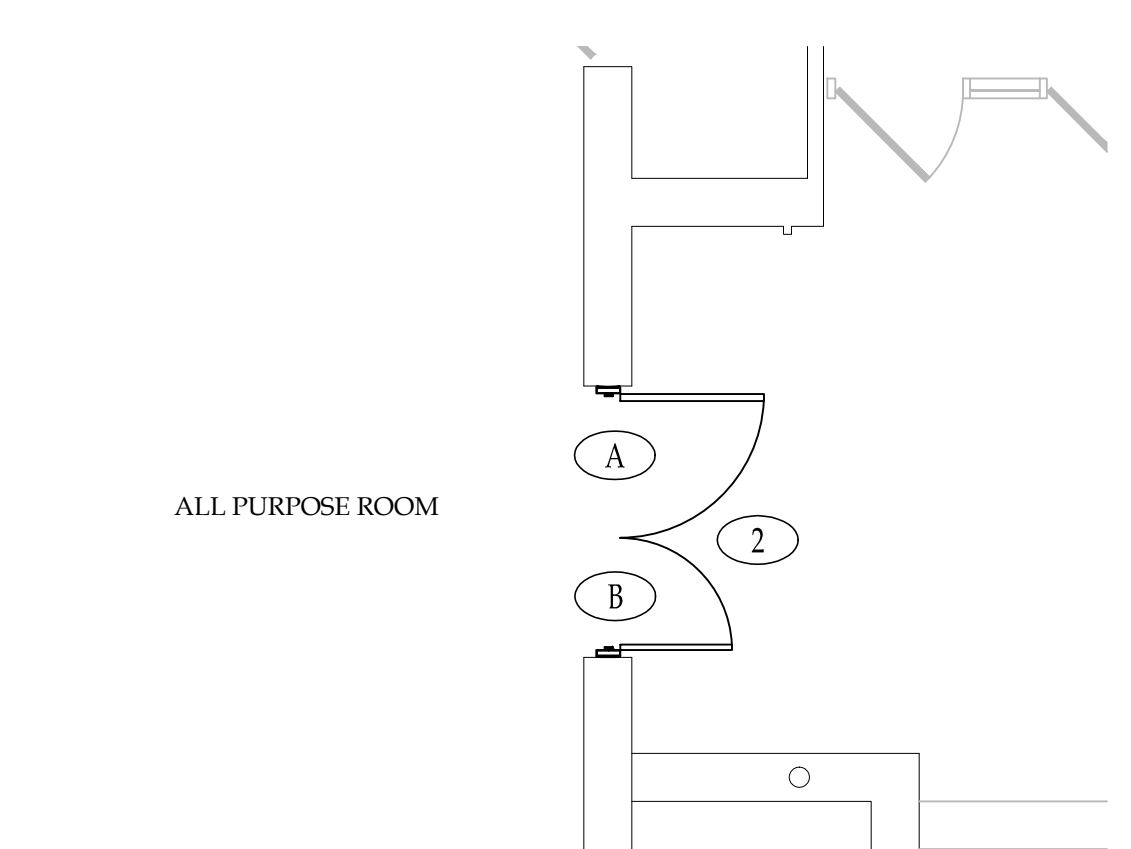


1 PARTIAL FLOOR PLAN @ DOOR #2

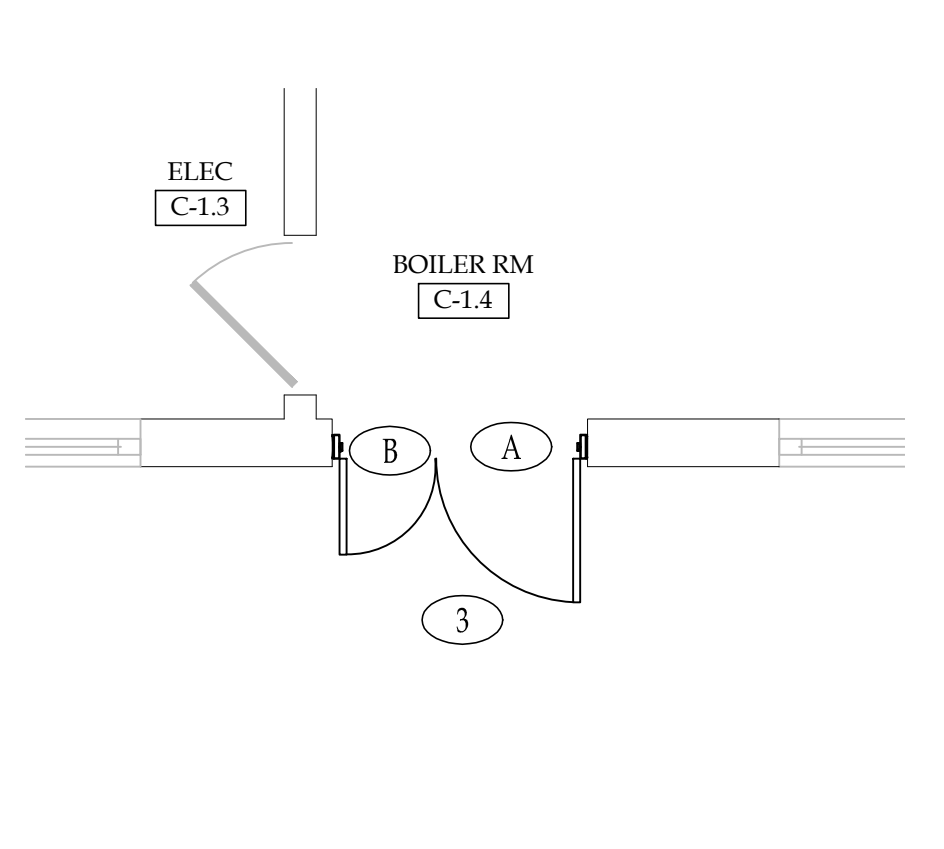


2 PARTIAL FLOOR PLAN @ DOOR #3

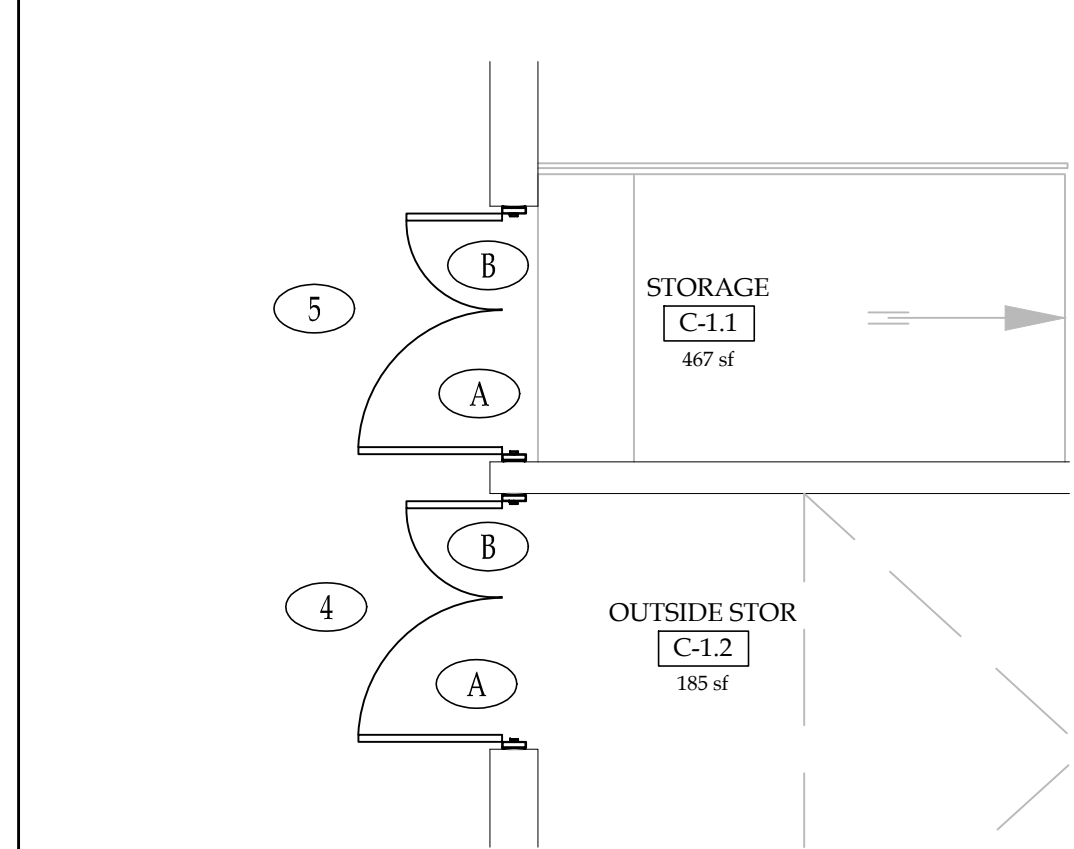


3 PARTIAL FLOOR PLAN @ DOOR #4 & 5

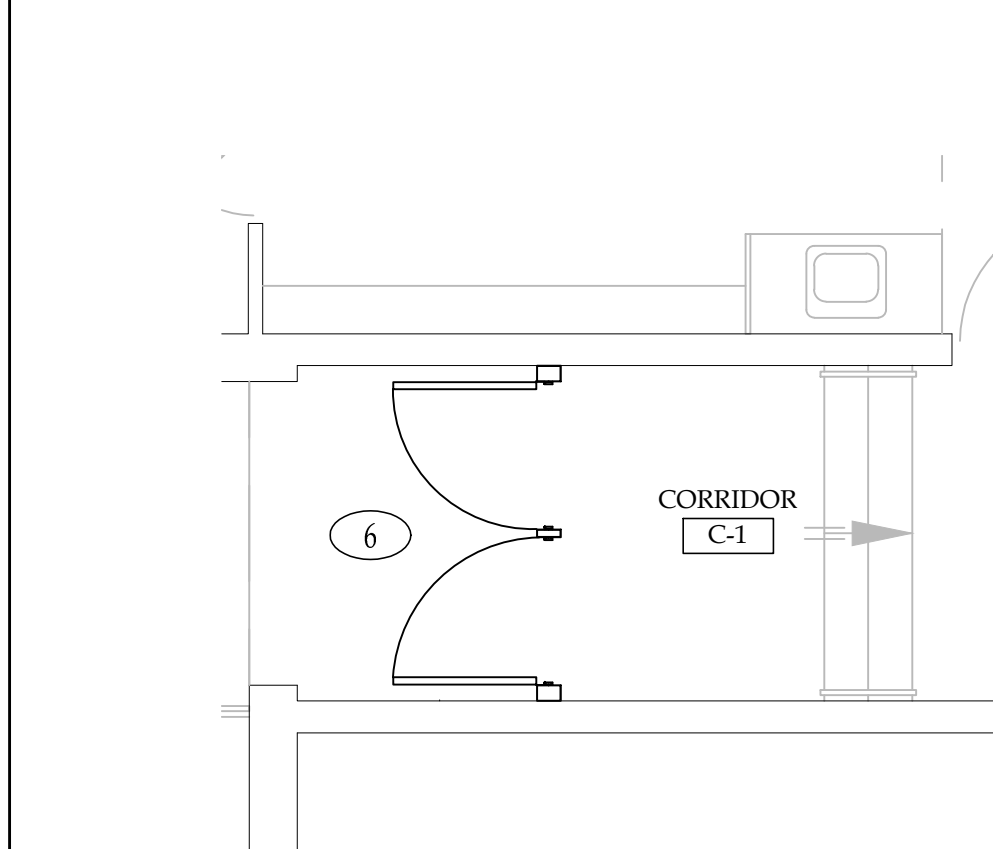

4 PARTIAL FLOOR PLAN @ DOOR #6

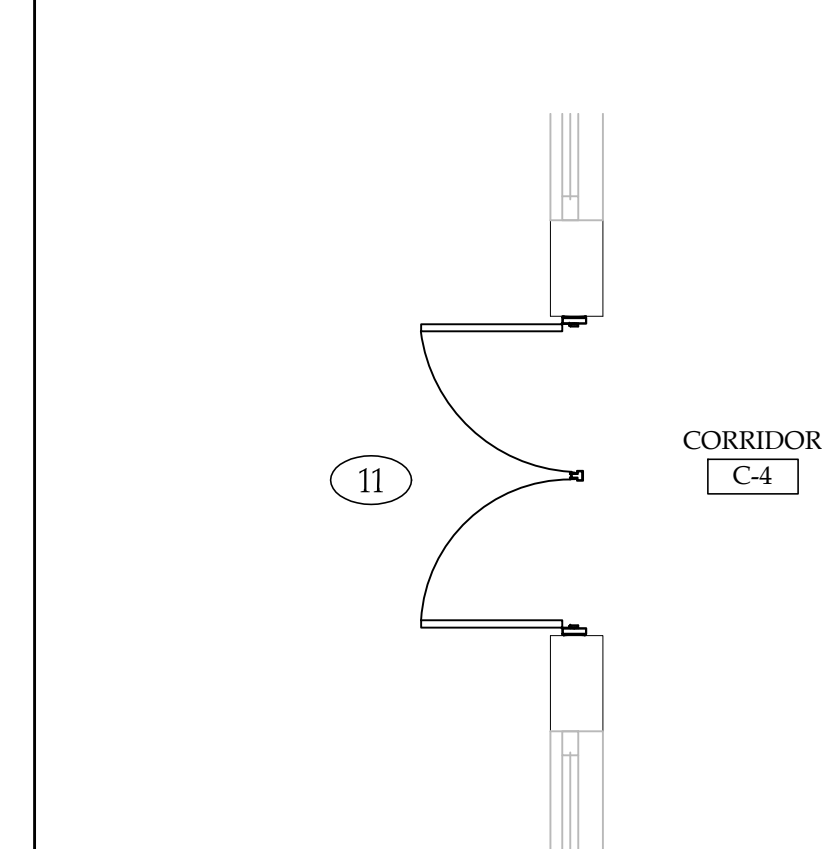

5 PARTIAL FLOOR PLAN @ DOOR #011

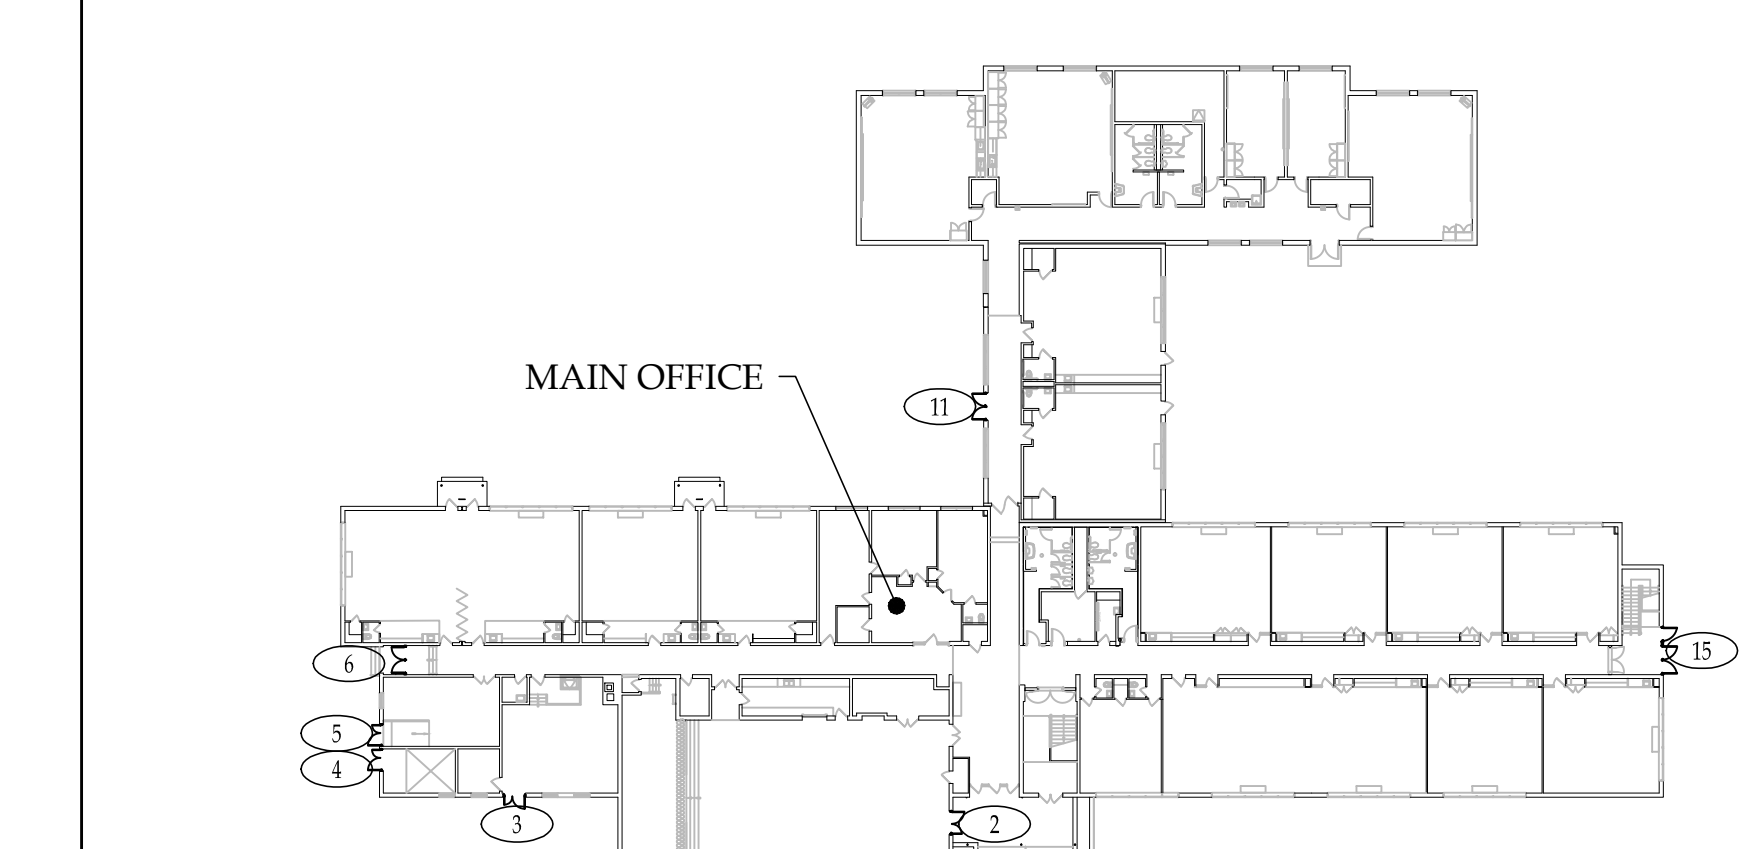

KEY PLAN

BECICA ASSOCIATES LLC
 Architecture/Engineering
 500 South Kings Highway
 Cherry Hill, New Jersey 08034
 P: 856.795.1180
 F: 856.354.6367
 W: www.becica.com

Signature/Date
 STEVEN A. BECICA, R.A., N.J. A.I.A. 21A010137600
 NJ Certificate of Professional Architecture - 21A00020700 / Engineering - 21E00002000

Exterior Door Replacement & Related Work at the Knight Elementary School
 140 Old Carriage Road, Cherry Hill, NEW JERSEY, NJ 08034
 Lot: 1 Block: 404.15
 Cherry Hill Board Of Education
 PO Box 5015, 45 Randolph Terrace, Cherry Hill, New Jersey 08034

Contractor shall check and verify all conditions and dimensions at the site before proceeding with this work.

#	Date	Description

Set Issue:
Issued for Bidding
 Issue Date: April 5, 2019
 Drawing Title:
Plans, Details Notes & Schedules
 Drawn by: _____ Checked by: _____
DB
 Project Number:
18CHS-08016
 DOE State Plan Number #:
 Drawing Number:
A-1.1

DOOR SCHEDULE															REMARKS
DOOR NUMBER	DOOR				FRAME					MISCELLANEOUS					
	SIZE		DOOR TYPE	# OF LEAVES	DOOR MAT'L	DOOR THICK'N	FRAME TYPE	FRAME MATERIAL	MULLION	JAMB	HEAD	THRESHOLD	H.WSET	GLASS	
WIDTH	HEIGHT														
12	3'-0"	7'-0"	D-1	2	FRP	1-3/4"	F-1	ALUM	FIXED	J-1	H-1	T-1	8.1	GL-1	REPLACE SILL FULL WIDTH REFER TO CONCRETE SILL DETAIL 7

- DOOR SCHEDULE NOTES:**
- (E) STEEL LINTELS ABOVE OPENING TO BE SCRAPPED, CLEANED, PRIMED & PAINTED
 - DOOR & FRAME TO RECEIVE ELECTRICAL POWER TRANSFER FOR FUTURE CARD ACCESS - SEE HARDWARE SCHEDULE. CONTRACTOR TO TERMINATE CONTROL WIRING AND COIL ABOVE CEILING FOR FUTURE CONNECTION TO OWNER PROVIDED POWER SUPPLY.
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GLAZING SCHEDULE
GL-1: 1" INSULATED, LAMINATED, TINTED (EVERGREEN), SAFETY GLAZING

LEGEND

ALUM	ALUMINUM
(E)	EXISTING TO REMAIN
(ER)	EXISTING RELOCATED
FRP	FIBERGLASS REINFORCED POLYESTER
(R)	REMOVE EXISTING
(RE)	RELOCATE EXISTING
V.I.F.	VERIFY IN FIELD

- GENERAL DOOR / FRAME NOTES:**
- DEMOLISH (E) FRAME & DOOR SYSTEMS IN THEIR ENTIRETY AT ALL LOCATIONS TO RECEIVE NEW DOOR AND FRAMES AS INDICATED. PREPARE ADJACENT FINISHES TO ACCOMMODATE NEW ALUMINUM FRAME & DOORS COLORS TO BE SELECTED BY ARCHITECT
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CODE ANALYSIS

APPLICABLE CODES

BUILDING SUBCODE EDITION: INTERNATIONAL BUILDING CODE / 2015, NEW JERSEY ICC / ANSI A117.1 - 2009 INTERNATIONAL FIRE CODE / 2015

ELECTRICAL SUBCODE: NATIONAL ELECTRICAL CODE / 2015

REHABILITATION SUBCODE: NJUCC, SUBCHAPTER 6

BUILDING ANALYSIS
(FROM IBC 2015 - NEW JERSEY EDITION)

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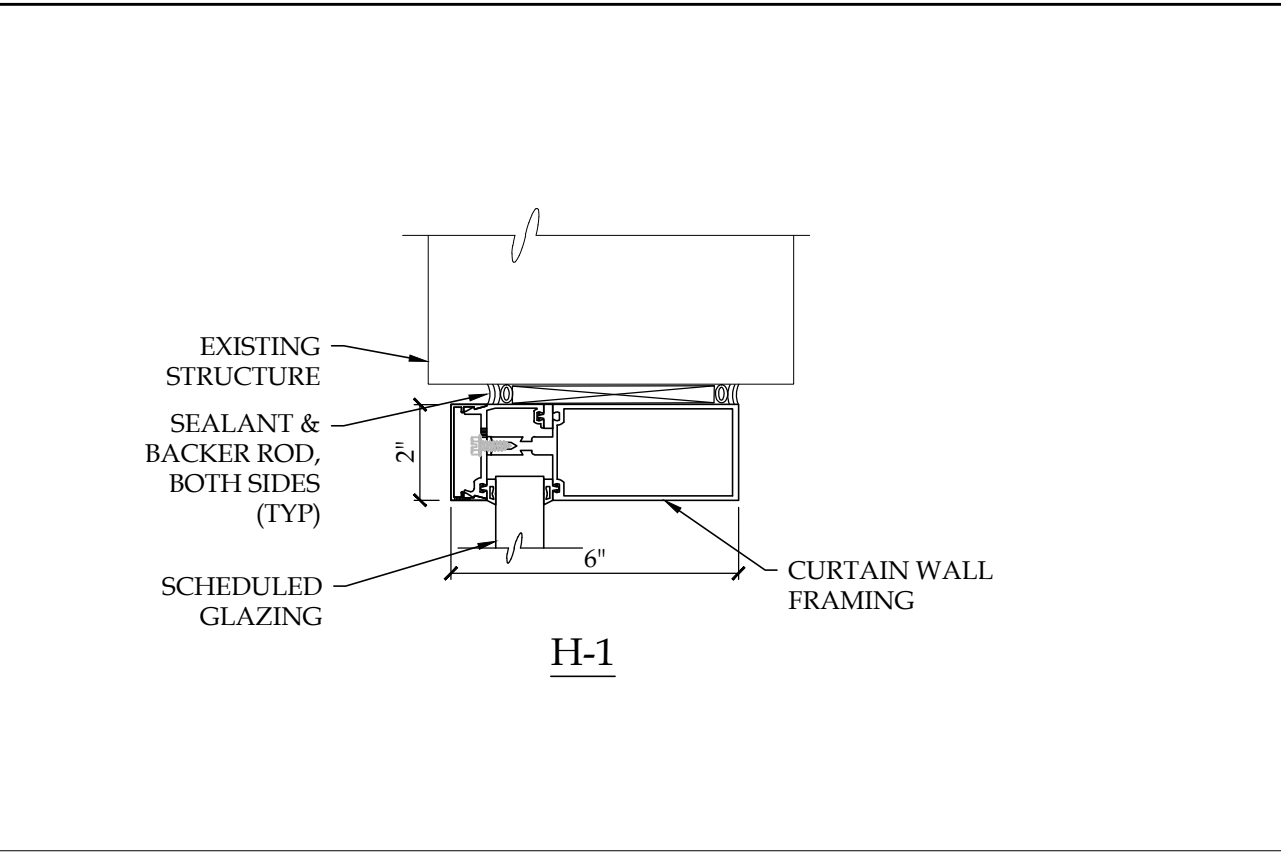
EGRESS ANALYSIS
(FROM NEW JERSEY REHABILITATION SUBCODE 523-6)

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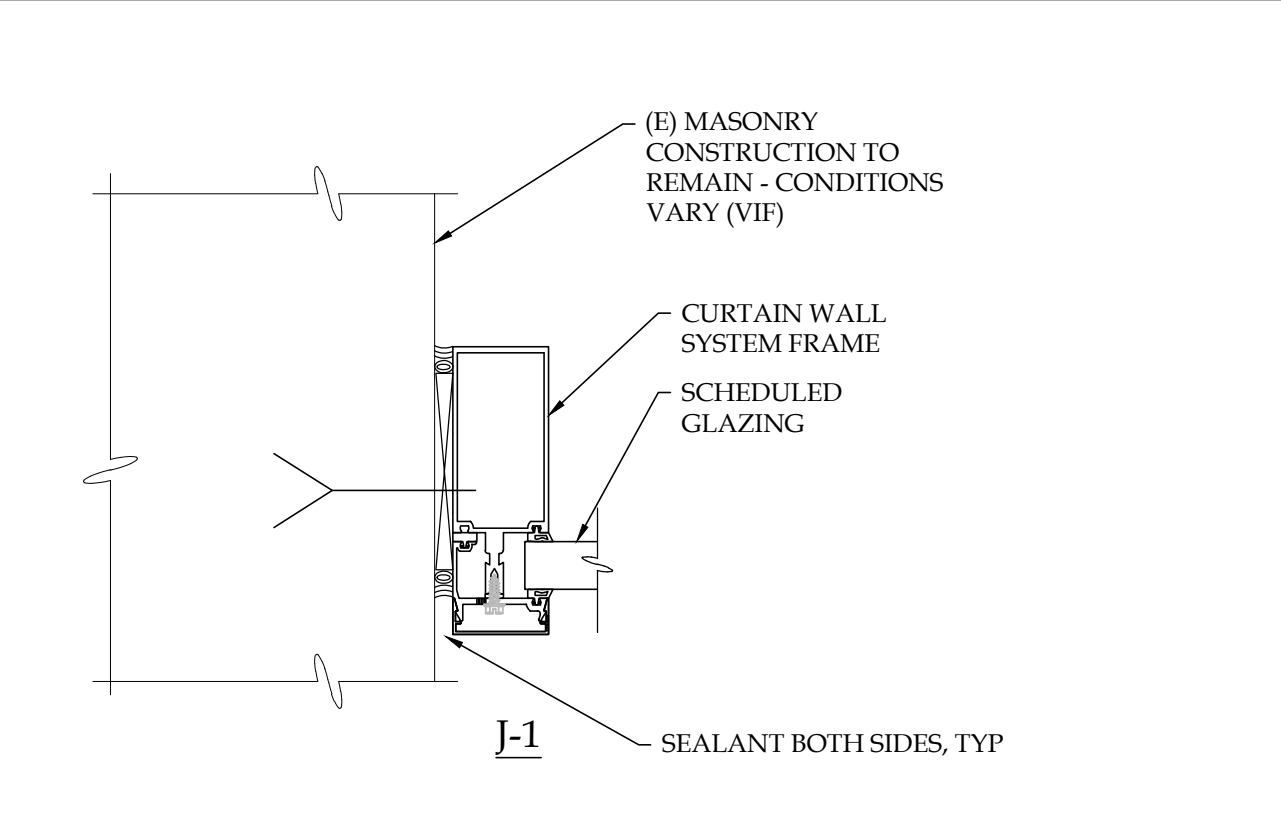
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BECICA ASSOCIATES LLC
Architecture/Engineering
500 South Kings Highway
Cherry Hill, New Jersey 08034
P: 856.795.1180
F: 856.354.6367
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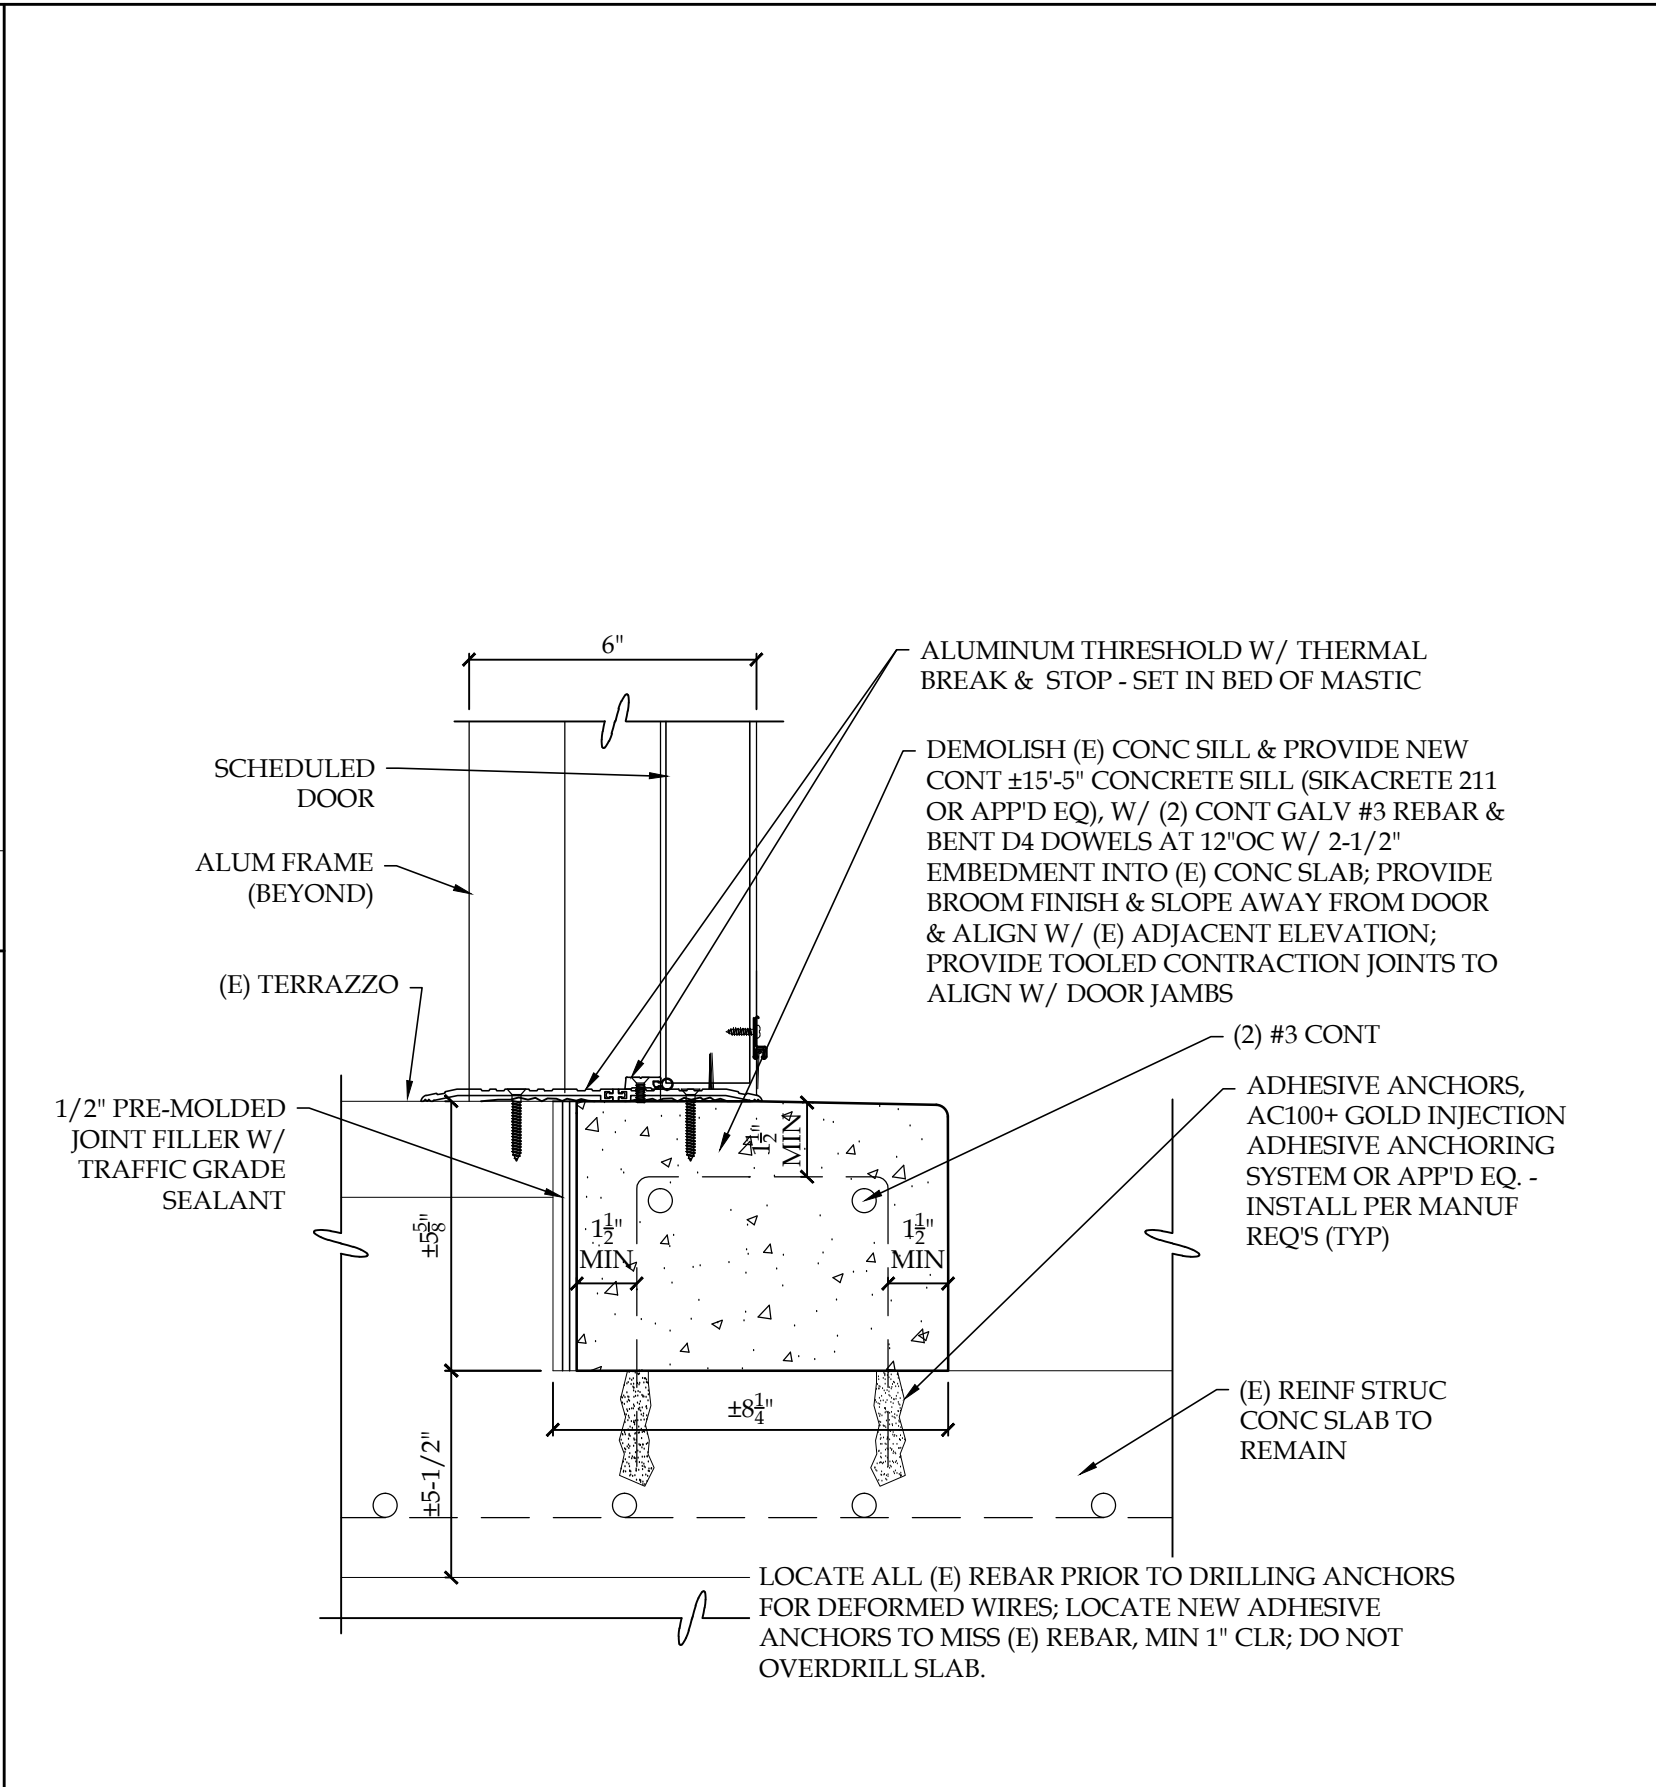
NJ Certificate of Professional Architecture - 21A00027010 / Engineering - #461862620




8 HEAD DETAIL H-1
3/4" = 1'-0"




6 JAMB DETAIL J-1
3/4" = 1'-0"




7 CONCRETE SILL REPLACEMENT DETAIL
3/4" = 1'-0"

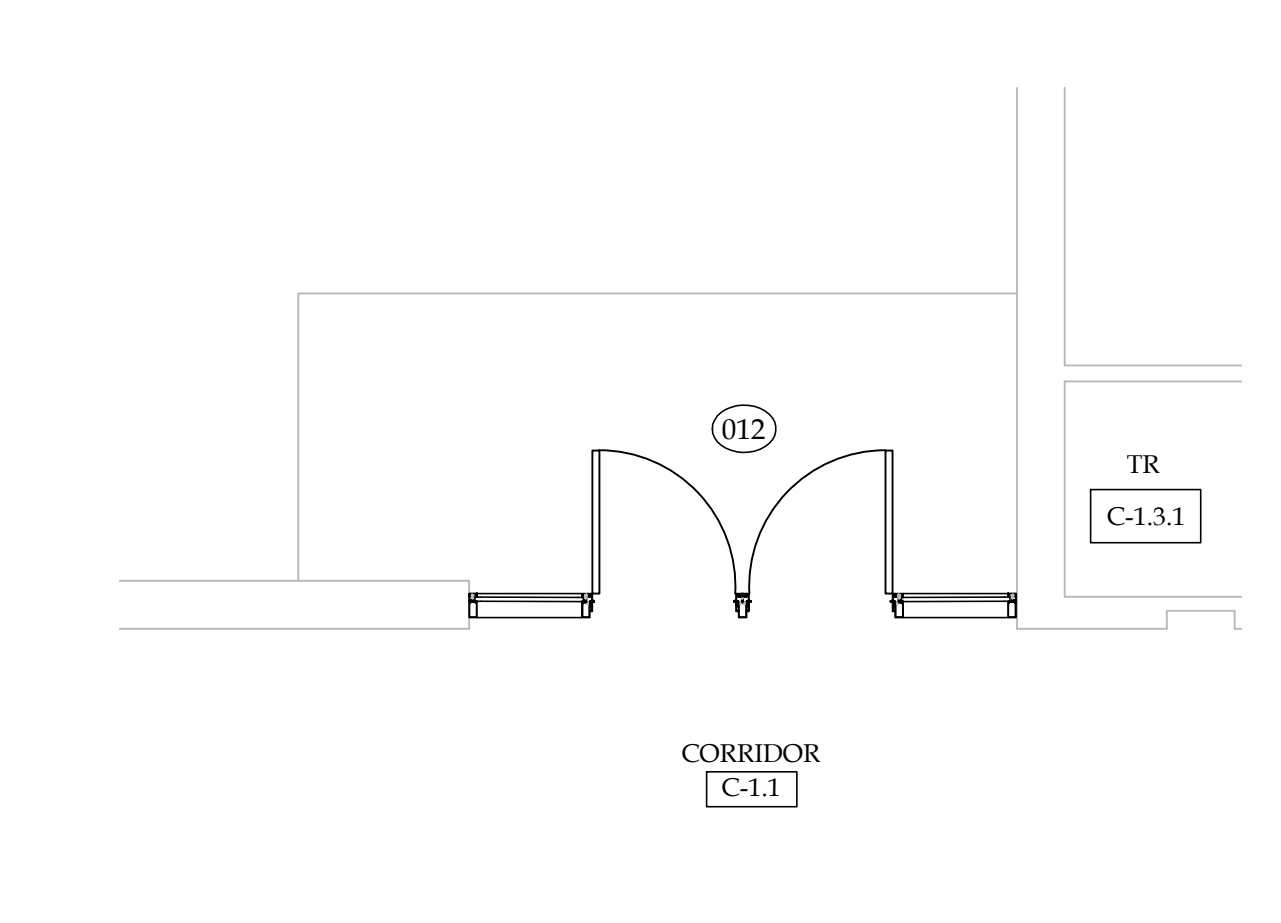


1 PARTIAL FLOOR PLAN @ DOOR #012
1/4" = 1'-0"

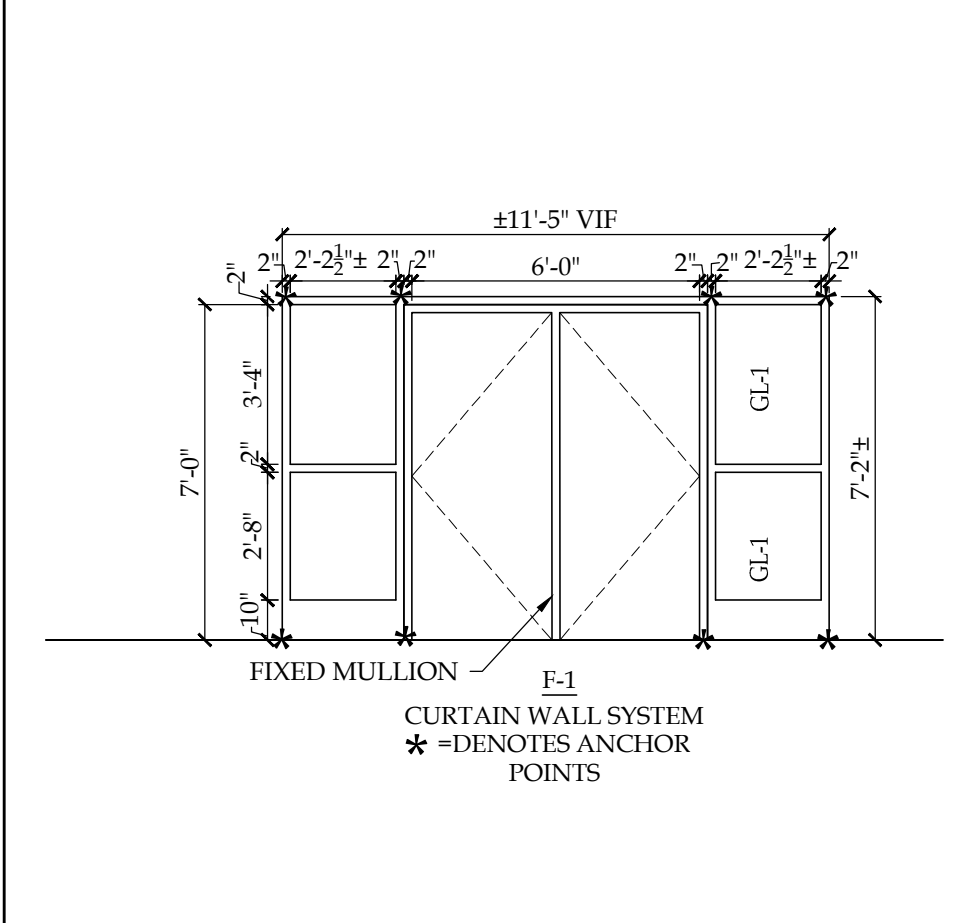


2 DOOR FRAME TYPES
1/4" = 1'-0"

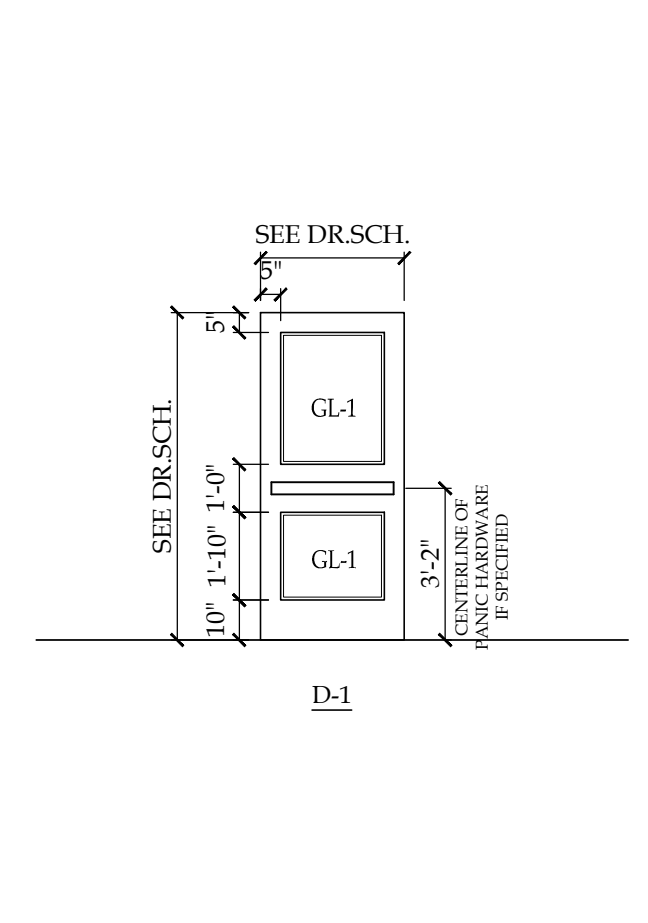


3 DOOR TYPES
1/4" = 1'-0"

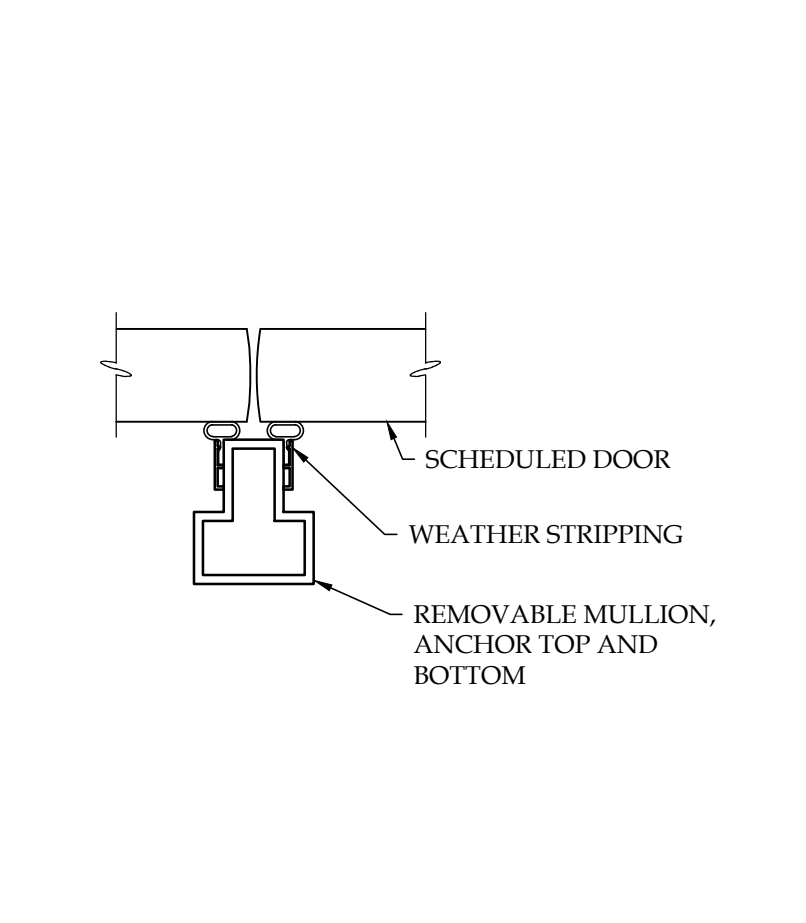

4 REMOVABLE MULLION DETAIL
3/4" = 1'-0"

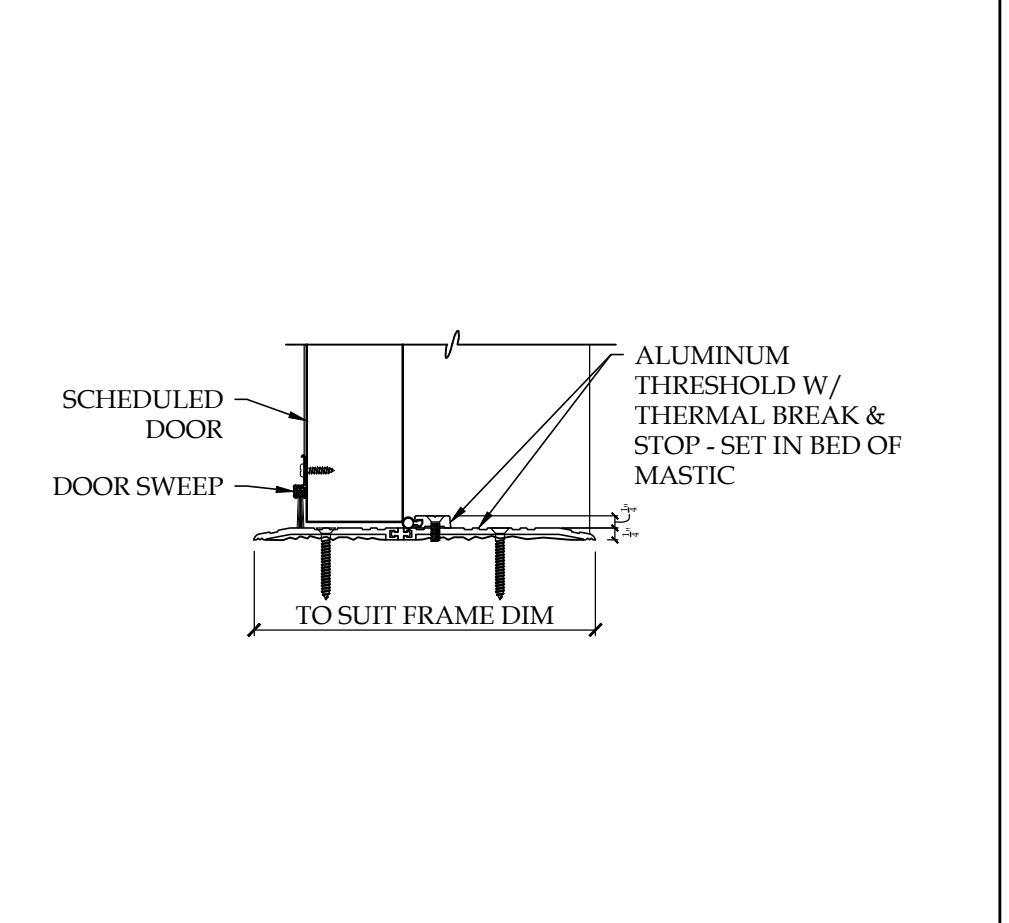

5 THRESHOLD DETAIL T-1
3/4" = 1'-0"

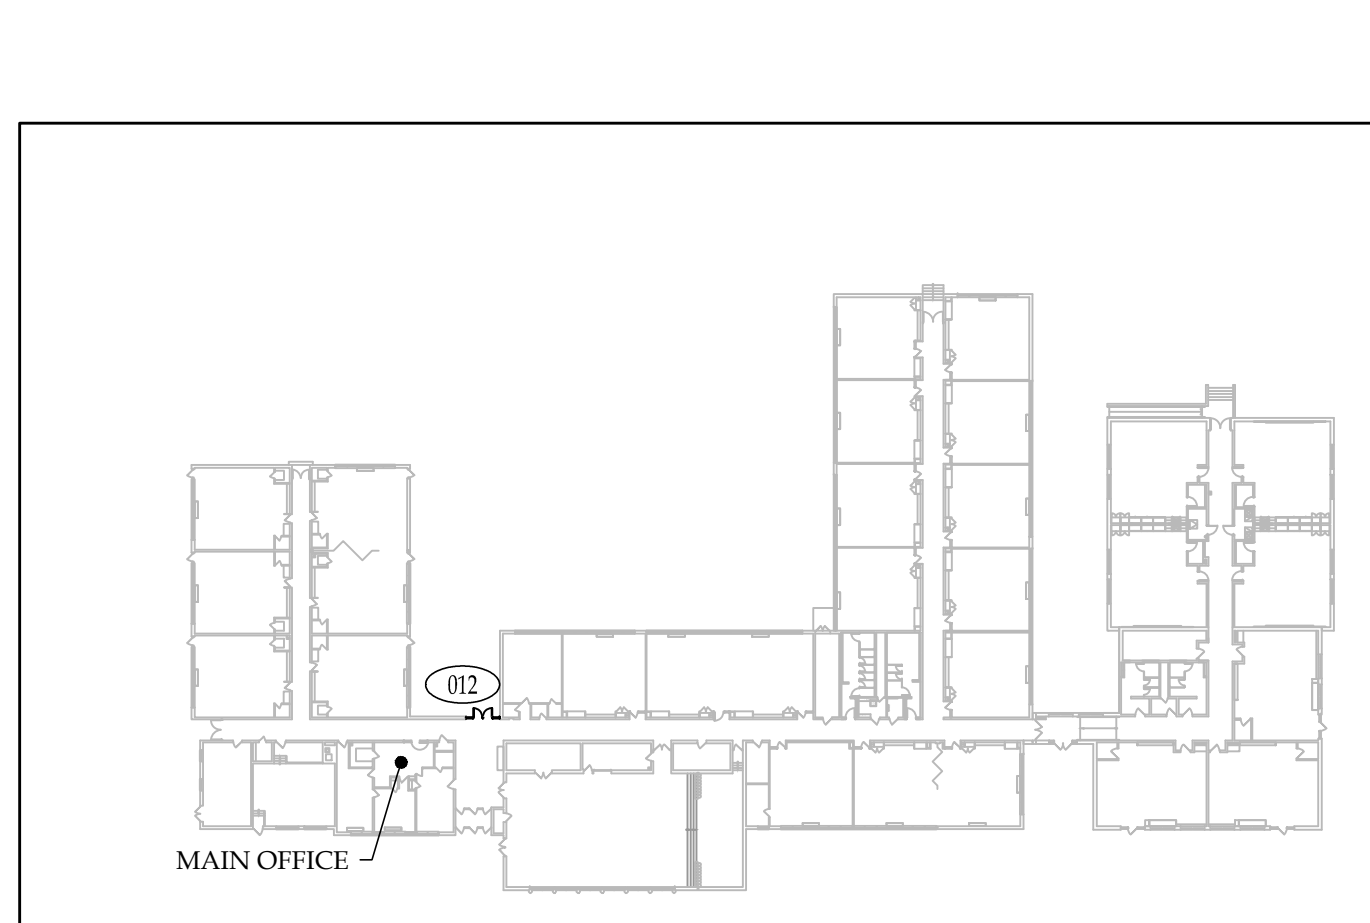

KEY PLAN

Exterior Door Replacement & Related Work at the Mann Elementary School
150 Walt Whitman Boulevard, Cherry Hill, NJ 08003
Lot: 7 Block: 529.08
Cherry Hill Board Of Education
PO Box 5015, 45 Randolph Terrace, Cherry Hill, New Jersey 08034

Contractor shall check and verify all conditions and dimensions at the site before proceeding with this work.

Revisions		
#	Date	Description

Set Issue:

Issued for Bidding

Issue Date: April 5, 2019

Drawing Title:
**Plans, Details
Notes & Schedules**

Drawn by: _____ Checked by: _____

DB

Project Number:
19CHS-09010
DOE State Plan Number #:

Drawing Number:
A-1.1

DOOR SCHEDULE														REMARKS	
DOOR NUMBER	DOOR				FRAME				MISCELLANEOUS						
	SIZE WIDTH HEIGHT	DOOR TYPE	# OF LEAVES	DOOR MAT'L	DOOR THICKN	FRAME TYPE	FRAME MATERIAL	MULLION	JAMB	HEAD	THRESHOLD	H/W SET	GLASS		
5A 5B	3'-0" 2'-6"	7'-0"	D-1	2	FRP	1-3/4"	F-2	ALUM	-	J-2	H-2	T-1	4	GL-1	
6	3'-0"	7'-0"	D-2	1	FRP	1-3/4"	F-1	ALUM	-	J-1	H-1	T-1	13"	GL-1	FLUSH PULL FRP3 INTEGRAL WITH DOOR BY DOOR MANUFACTURE
15	3'-0"	7'-0"	D-1	2	FRP	1-3/4"	F-3	ALUM	REMOVABLE	J-3	H-3	T-1	8	GL-1	

- DOOR SCHEDULE NOTES:**
- (E) STEEL LINTELS ABOVE OPENING TO BE SCRAPED, CLEANED, PRIMED & PAINTED
 - DOOR & FRAME TO RECEIVE ELECTRICAL POWER TRANSFER FOR FUTURE CARD ACCESS - SEE HARDWARE SCHEDULE. CONTRACTOR TO TERMINATE CONTROL WIRING AND COIL ABOVE CEILING FOR FUTURE CONNECTION TO OWNER PROVIDED POWER SUPPLY.
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GLAZING SCHEDULE
GL-1: 1" INSULATED, LAMINATED, TINTED (EVERGREEN), SAFETY GLAZING

- LEGEND**
- ALUM ALUMINUM
 - (E) EXISTING TO REMAIN
 - (FR) EXISTING RELOCATED
 - FRP FIBERGLASS REINFORCED POLYESTER
 - (R) REMOVE EXISTING
 - (RE) RELOCATE EXISTING
 - V.I.F. VERIFY IN FIELD

- GENERAL DOOR / FRAME NOTES:**
- DEMOLISH (E) FRAME & DOOR SYSTEMS IN THEIR ENTIRETY AT ALL LOCATIONS TO RECEIVE NEW DOOR AND FRAMES AS INDICATED; PREPARE ADJACENT FINISHES TO ACCOMMODATE NEW ALUMINUM FRAME & DOORS COLORS TO BE SELECTED BY ARCHITECT
 - REPAIR (E) FINISHES TO MATCH (E) ADJACENT AS REQ'D TO ACCOMMODATE NEW WORK.
 - FASTENER SELECTION AND PATTERN SHALL COMPLY WITH DESIGN LOADS.

CODE ANALYSIS

APPLICABLE CODES

BUILDING SUBCODE EDITION INTERNATIONAL BUILDING CODE / 2015, NEW JERSEY ICC / ANSI A117.1 - 2009 INTERNATIONAL FIRE CODE / 2015

ELECTRICAL SUBCODE NATIONAL ELECTRICAL CODE / 2015

REHABILITATION SUBCODE NJUCC, SUBCHAPTER 6







BUILDING ANALYSIS
(FROM IBC 2015 - NEW JERSEY EDITION)


THE FLOOR PLAN AREA AND HEIGHT OF THE SCHOOL BUILDING HAS NOT CHANGED UNDER THIS PROJECT, THEREFORE NO ANALYSIS OF THE EXISTING BUILDING HAS BEEN PROVIDED.

EGRESS ANALYSIS
(FROM NEW JERSEY REHABILITATION SUBCODE 523-6)

THE OCCUPANT LOAD OF THE SCHOOL HAS NOT CHANGED UNDER THIS PROJECT, THEREFORE AN EGRESS ANALYSIS HAS NOT BEEN PROVIDED.

- GENERAL NOTES:**
- THE WORK IS GOVERNED BY THE NIUCC AND SUBCODES OF THE INTERNATIONAL BUILDING CODE 2015, NJ EDITION AND AS AMENDED BY THE PROJECT DOCUMENTS.
 - THE CONTRACTOR IS RESPONSIBLE TO SECURE ALL PERMITS, TO OBTAIN APPROVALS AS REQUIRED AND COORDINATE INSPECTION WITH LOCAL BUILDING INSPECTOR. ALL PERMIT AND APPLICATION FEES WILL BE PAID BY THE OWNER AND DELIVERED BY THE CONTRACTOR.
 - DRAWINGS & SPECIFICATIONS COMPLIMENT EACH OTHER. WORK NOT SHOWN ON DRAWINGS BUT CALLED FOR IN THE SPECIFICATIONS IS STILL REQUIRED, AND ALL WORK NOT CALLED FOR IN SPECIFICATIONS, BUT CALLED OUT OR SHOWN IN DRAWINGS IS STILL REQUIRED.
 - ALL CONTRACTORS ARE ADVISED TO VISIT THE SITE AND VERIFY ALL AREAS, DIMENSIONS, AND CONDITIONS PRIOR TO SUBMITTING THEIR BIDS. THE CONTRACTOR MUST NOTIFY THE ARCHITECT OF ANY DISCREPANCIES AND/OR OMISSIONS IN WRITING AT LEAST TEN DAYS PRIOR TO THE RECEIPT OF BIDS. FAILURE TO SO NOTIFY THE ARCHITECT INDICATES THAT ANY ADDITIONAL COSTS ASSOCIATED WITH THE DISCREPANCIES AND / OR OMISSIONS ARE INCLUDED IN THE CONTRACTORS BID AND THAT NO CHANGE TO THE CONTRACT AMOUNT WILL BE MADE AFTER THE RECEIPT OF BIDS OR THE AWARD OF CONTRACTS.
 - DRAWINGS INDICATE GENERAL AND TYPICAL DETAILS OF CONSTRUCTION. WHERE CONDITIONS ARE NOT SPECIFICALLY SHOWN, SIMILAR DETAILS OF CONSTRUCTION SHALL BE USED, SUBJECT TO REVIEW AND APPROVAL OF THE ARCHITECT AND ENGINEER.
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 - DURING CONSTRUCTION, CLEAN AND PROTECT WORK IN PROGRESS. PROMPTLY REMOVE ANY DEBRIS FROM THE SITE. NO TRASH ACCUMULATION IS PERMITTED. TRANSPORT AND LEGALLY DISPOSE OF MATERIAL OFF SITE.
 - INSPECT AND DOCUMENT EXISTING CONDITIONS, SURFACES, FINISHES, FURNISHINGS, EQUIPMENT, ETC IN THE VICINITY OF THE WORK WITH THE OWNER PRIOR TO COMMENCING THE WORK. RESTORE ALL CONDITIONS, ETC., DAMAGED BY THE WORK TO THE PRECONSTRUCTION CONDITION AND TO THE OWNER'S SATISFACTION.
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 - EXTERIOR WALLS SHALL REMAIN IN PLACE FOR SECURITY & WEATHER PROTECTION UNTIL SUCH TIME AS THEY CAN BE REMOVED AND REPLACED WITH NEW CONSTRUCTION TO PROVIDE SECURITY & WEATHER PROTECTION WITHIN THE SAME WORK DAY WHILE PROJECT IS STAFFED BY CONTRACTOR.
 - PERFORM ALL DEMOLITION AND REMOVAL WORK IN SUCH A MANNER AS NOT TO REDUCE THE LOAD-CARRYING CAPACITY ABILITIES OF ANY STRUCTURAL MEMBERS, WALLS, ELEMENTS, ETC. PROVIDE SHORING DURING CONSTRUCTION TO SUITE CONDITIONS.
 - COORDINATE ALL SERVICE AND UTILITY INTERRUPTIONS WITH THE OWNER TO AVOID INTERRUPTING THE OWNER'S OPERATIONS.

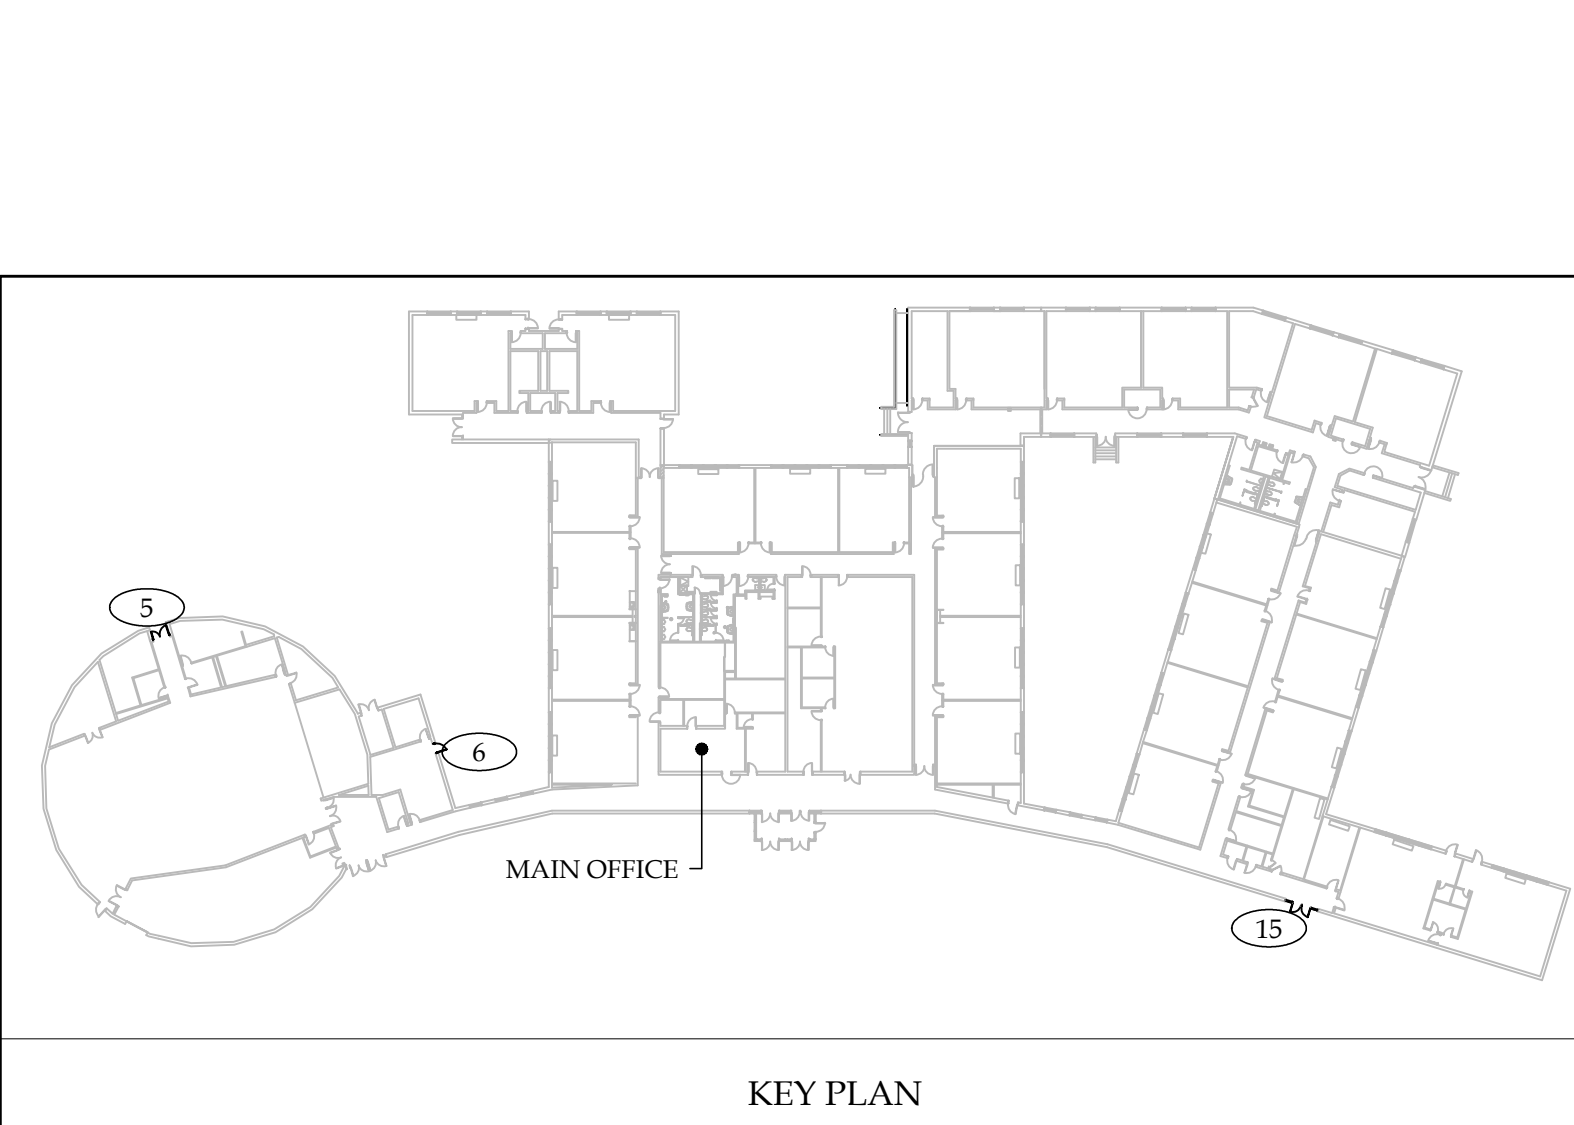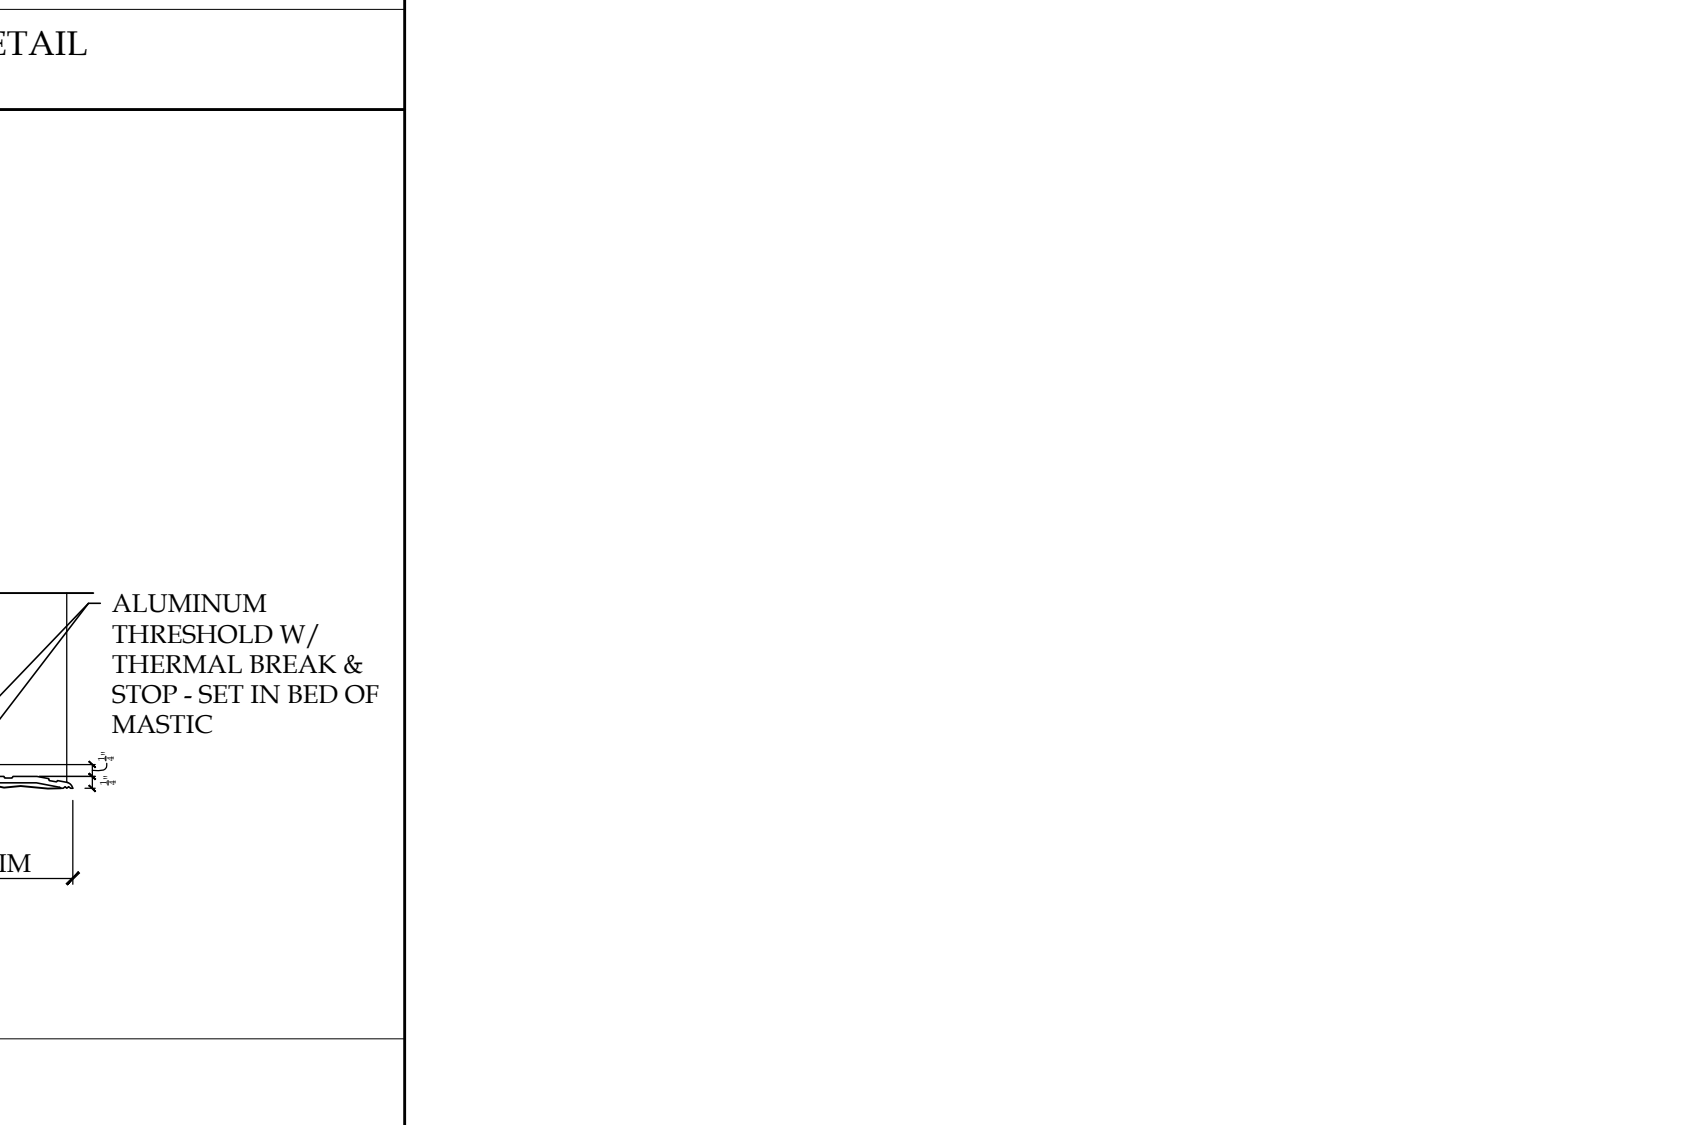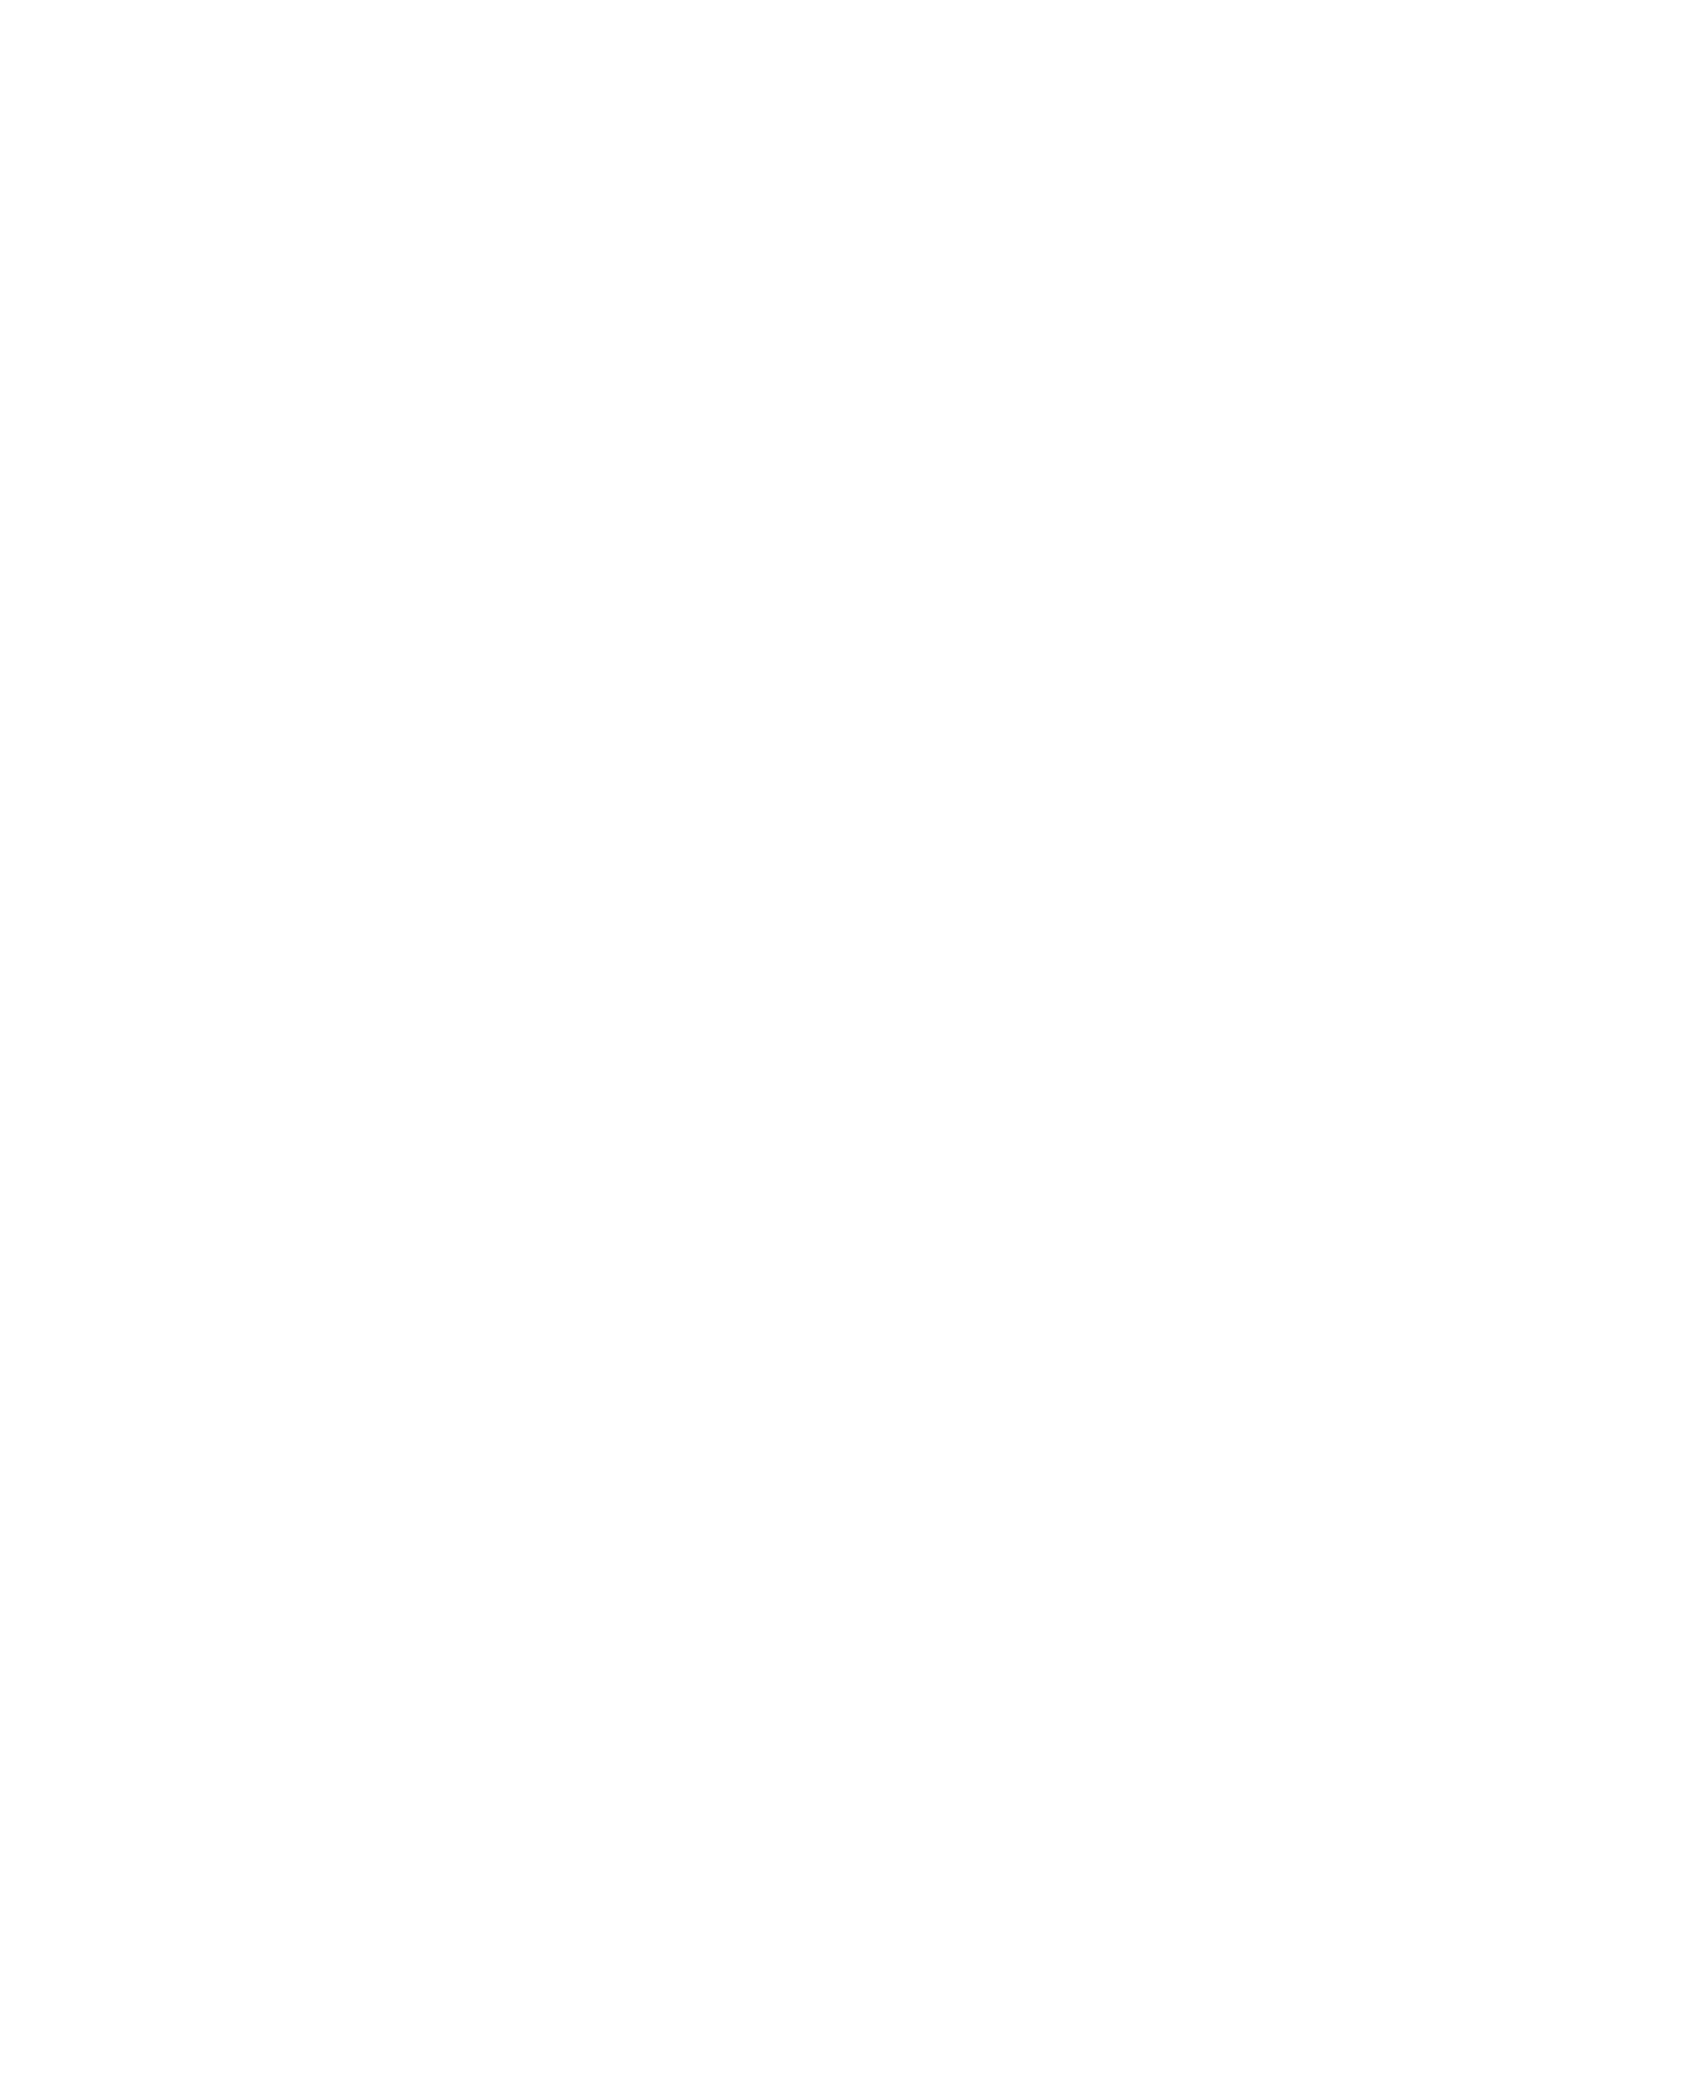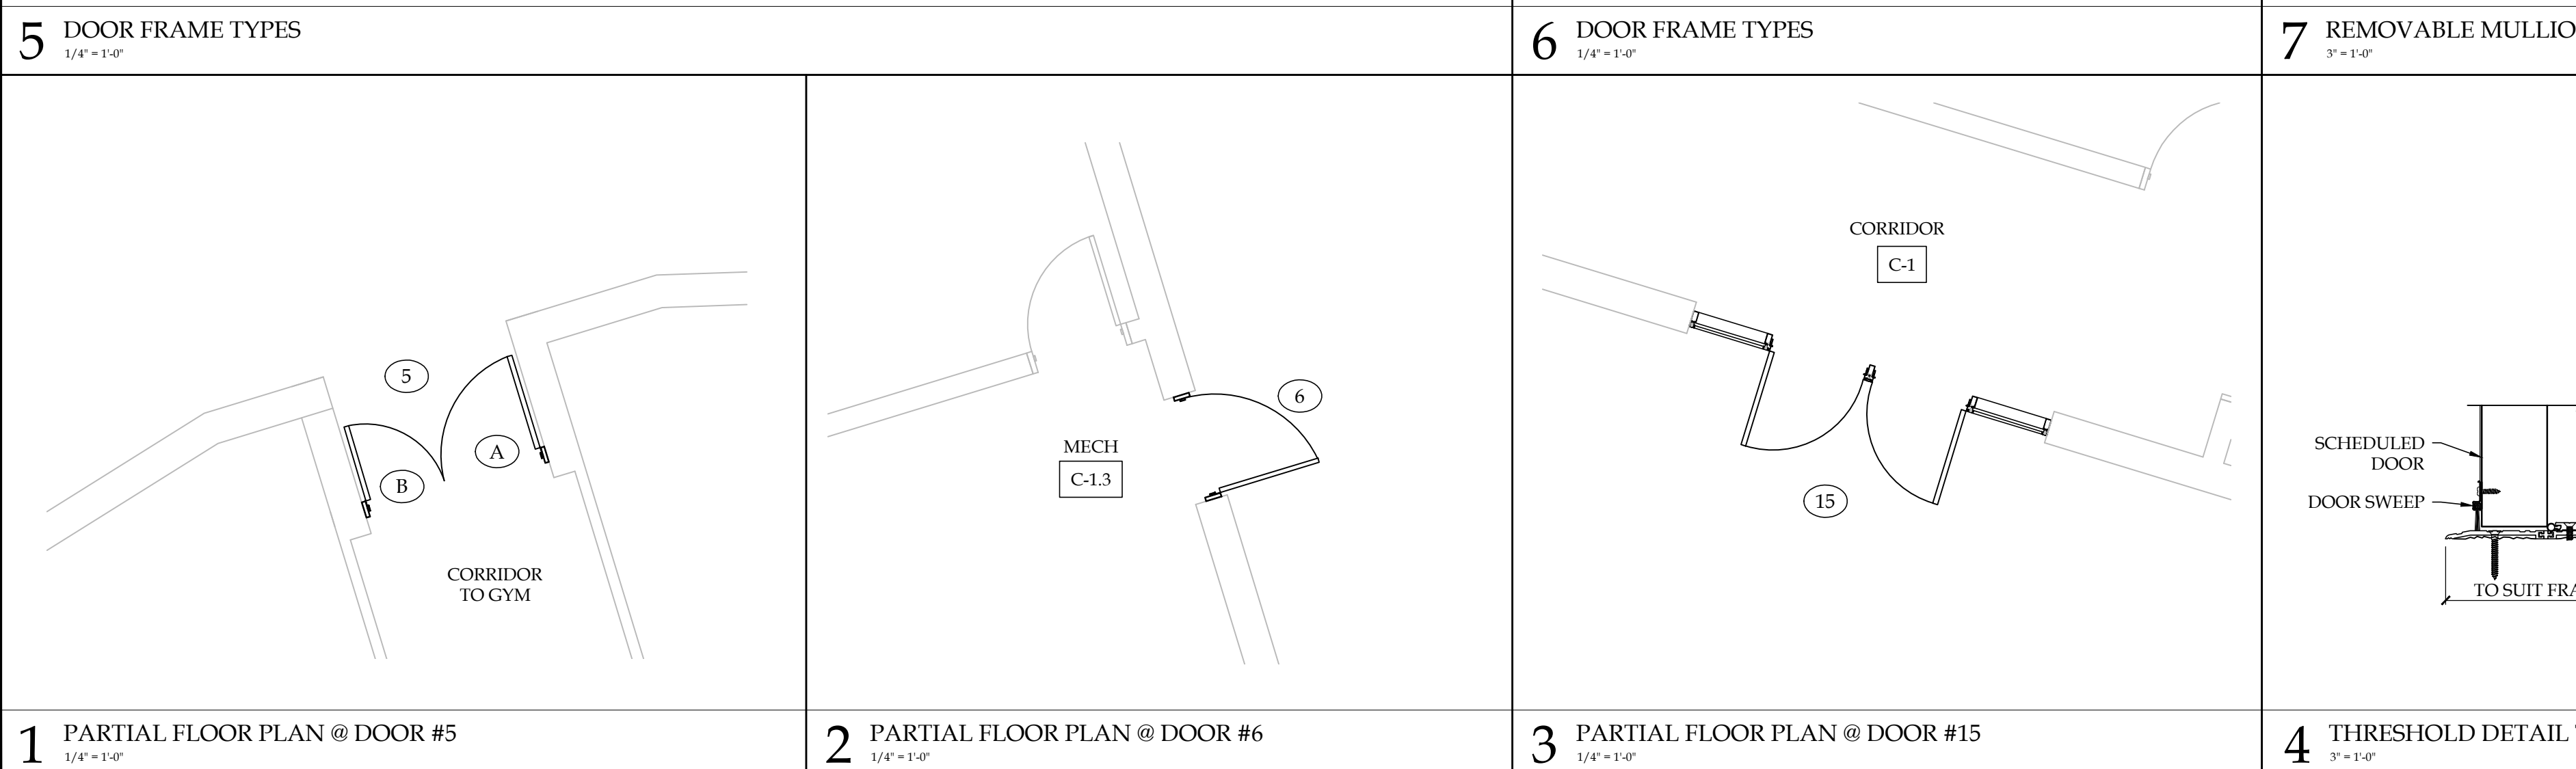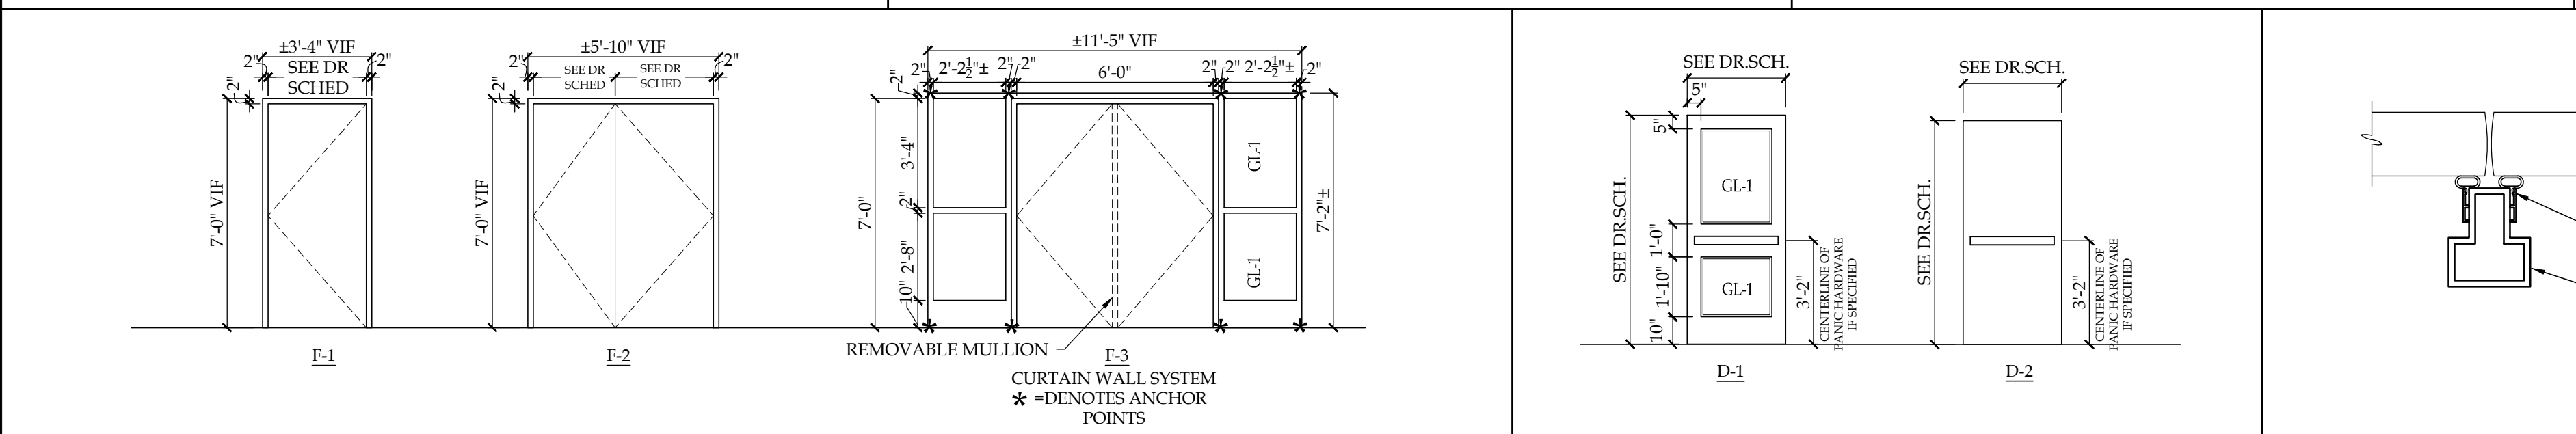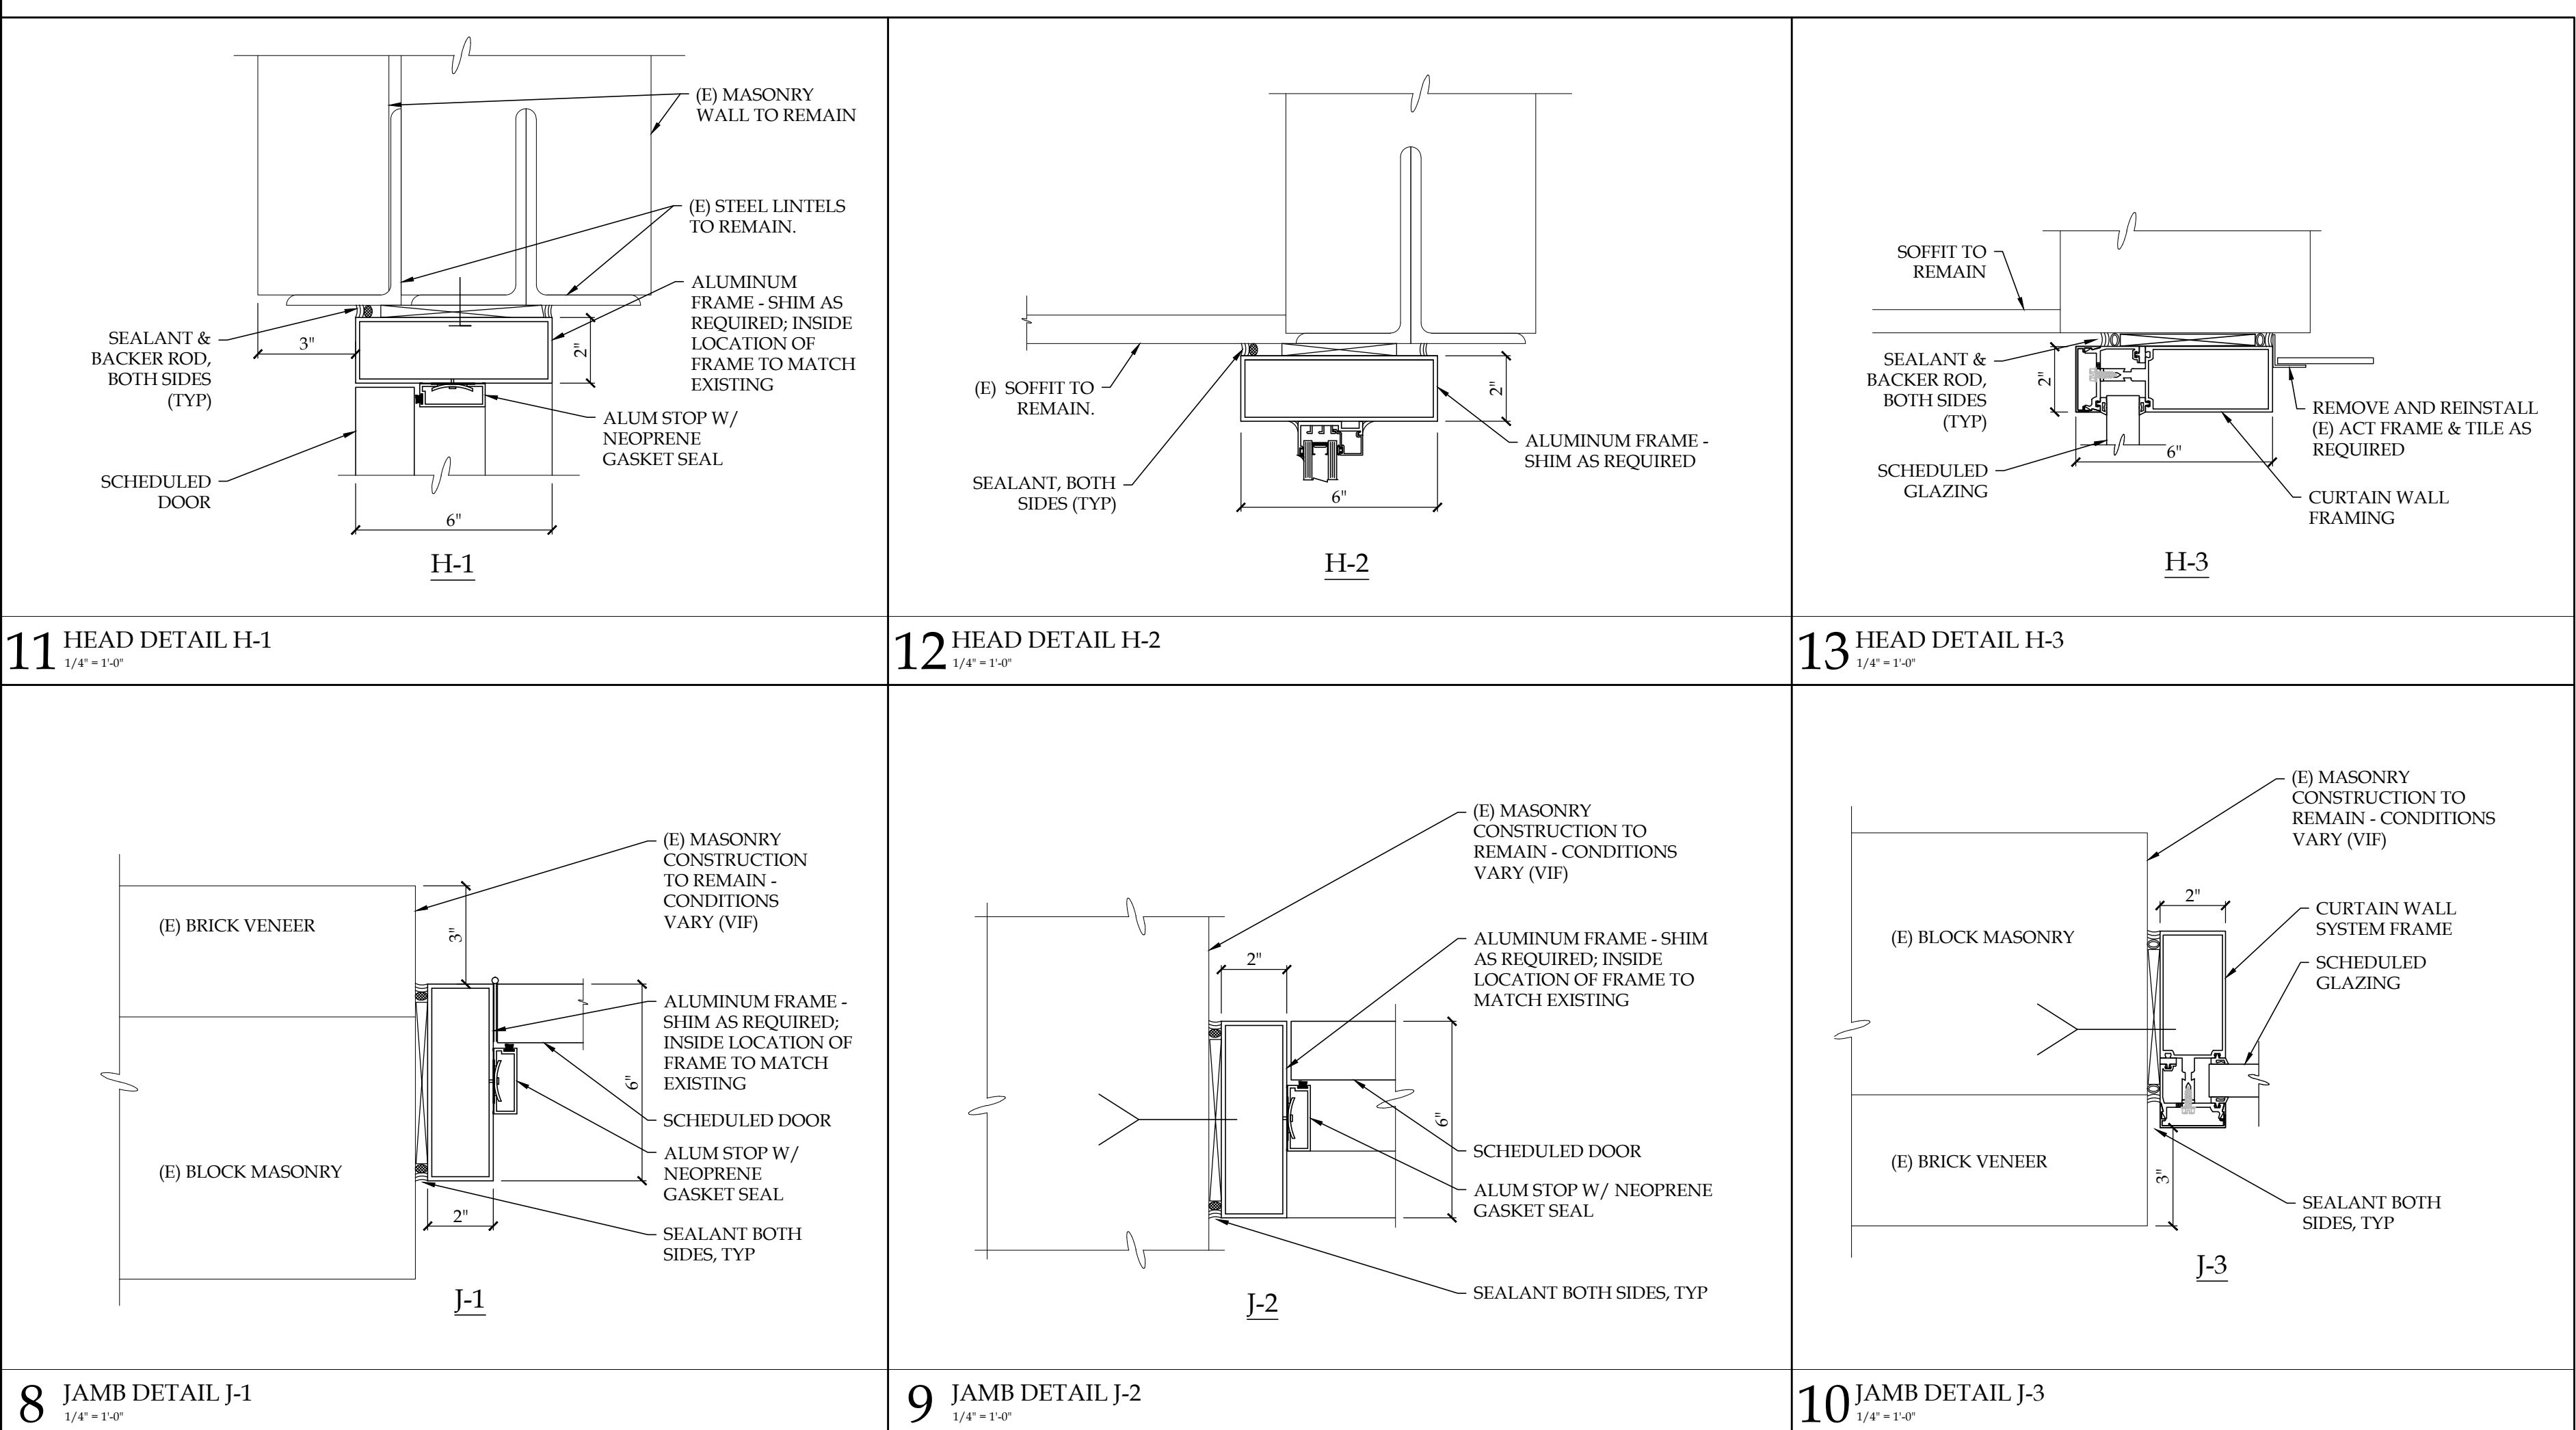

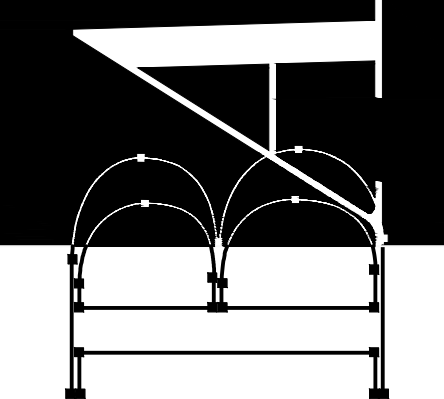

BECICA ASSOCIATES LLC
Architecture/Engineering
500 South Kings Highway
Cherry Hill, New Jersey 08034
P: 856.795.1180
F: 856.354.6367
W: www.becica.com

Exterior Door Replacement & Related Work at the
Stockton Elementary School
200 Wexford Dr. Cherry Hill, New Jersey 08003
Lot: 2 Block: 471.00
Cherry Hill Board Of Education
PO Box 5015, 45 Randolph Terrace, Cherry Hill, New Jersey 08034

Contractor shall check and verify all conditions and dimensions at the site before proceeding with this work.

#	Date	Description

Set Issue:

Issued for Bidding

Issue Date: April 5, 2019


Drawing Title:
**Plans, Details
Notes & Schedules**

Drawn by: _____ Checked by: _____

Project Number:
DB

19CHS-12014
DOE State Plan Number #:

Drawing Number:
A-1.1

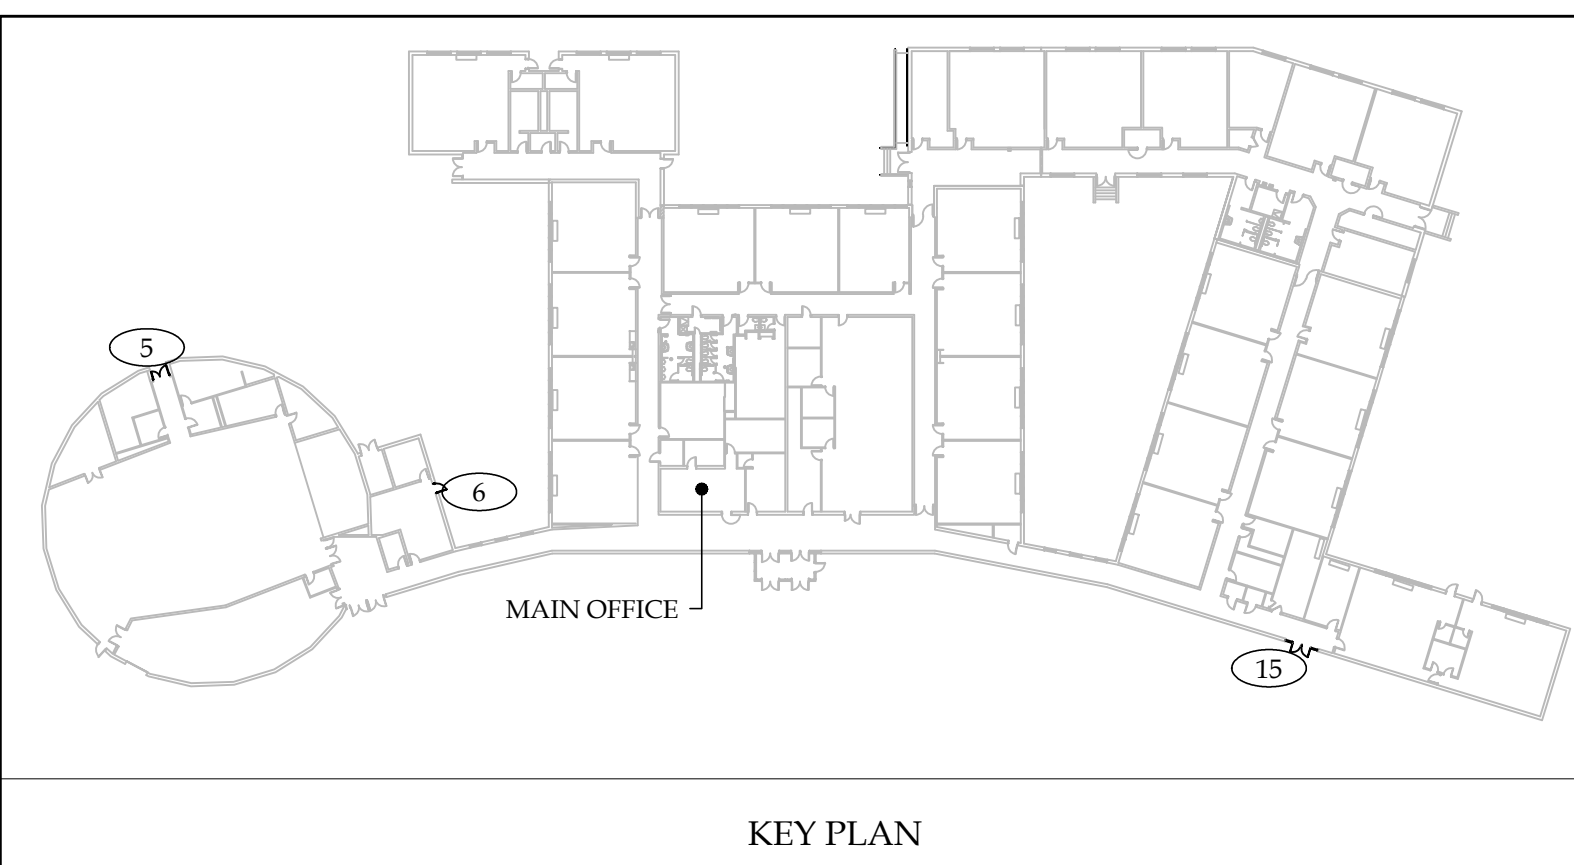

Signature/Date
 STEVEN A. BECICA, R.A., N.J. License No. 12A101137600
 NJ Certificate of Professional Architectural Registration - 22A00027000 / Engineering - #6168262600

DOOR SCHEDULE															
DOOR NUMBER	DOOR					FRAME					MISCELLANEOUS			REMARKS	
	SIZE		DOOR TYPE	# OF LEAVES	DOOR MATL	DOOR THICKN	FRAME TYPE	FRAME MATERIAL	MULLION	JAMB	HEAD	THRESHOLD	H.W.SET		GLASS
	WIDTH	HEIGHT													
008	3'-2"	7'-0"	D-1	2	FRP	1-3/4"	F-1	ALUM	FIXED	J-1	H-1	T-1	7.1	GL-1	CONTRACTOR TO SECURE THE SERVICE OF FRANKLIN ALARM 856-778-4424 TO REMOVE AND REINSTALL FRAME MOUNTED MOTION SENSOR

DOOR SCHEDULE NOTES:

- (E) STEEL LINTELS ABOVE OPENING TO BE SCRAPED, CLEANED, PRIMED & PAINTED
- DOOR & FRAME TO RECEIVE ELECTRICAL POWER TRANSFER FOR FUTURE CARD ACCESS - SEE HARDWARE SCHEDULE. CONTRACTOR TO TERMINATE CONTROL WIRING AND COIL ABOVE CEILING FOR FUTURE CONNECTION TO OWNER PROVIDED POWER SUPPLY.
- PROVIDE HEAD & JAMB ANGLE TRIM AT FRAME EXTERIOR TO MATCH NEW FRAME.

GLAZING SCHEDULE

GL-1: 1" INSULATED, LAMINATED, TINTED (EVERGREEN), SAFETY GLAZING

LEGEND

ALUM ALUMINUM
 (E) EXISTING TO REMAIN
 (ER) EXISTING RELOCATED
 FRP FIBERGLASS REINFORCED POLYESTER
 (R) REMOVE EXISTING
 (RE) RELOCATE EXISTING
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BUILDING ANALYSIS
 (FROM IBC 2015 - NEW JERSEY EDITION)


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 (FROM NEW JERSEY REHABILITATION SUBCODE 5-23-6)


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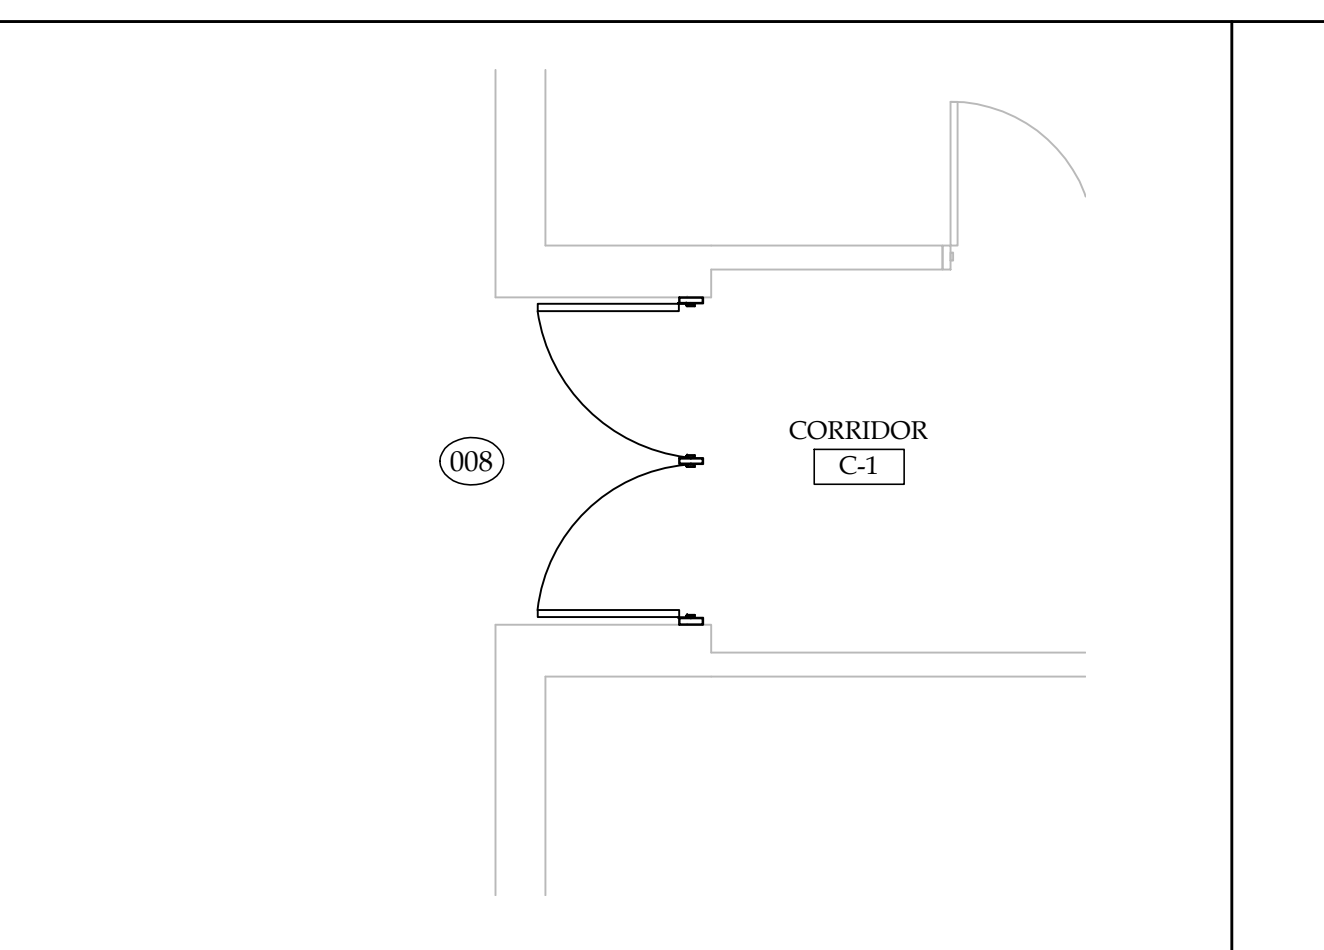
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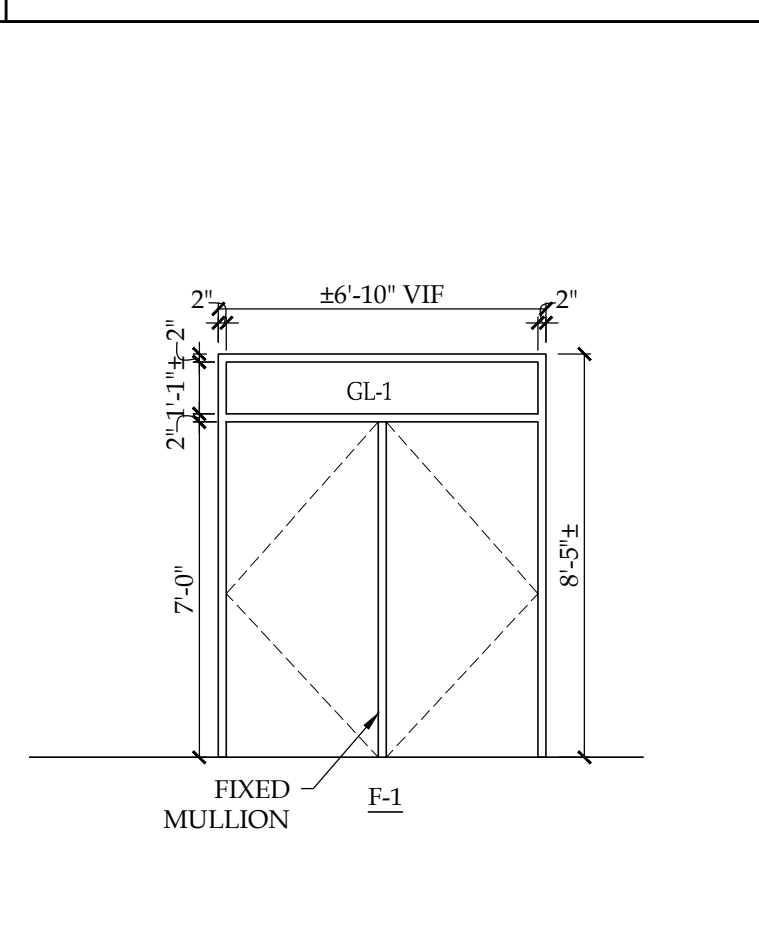
7 HEAD DETAIL H-1
3/4" = 1'-0"




6 JAMB DETAIL J-1
3/4" = 1'-0"

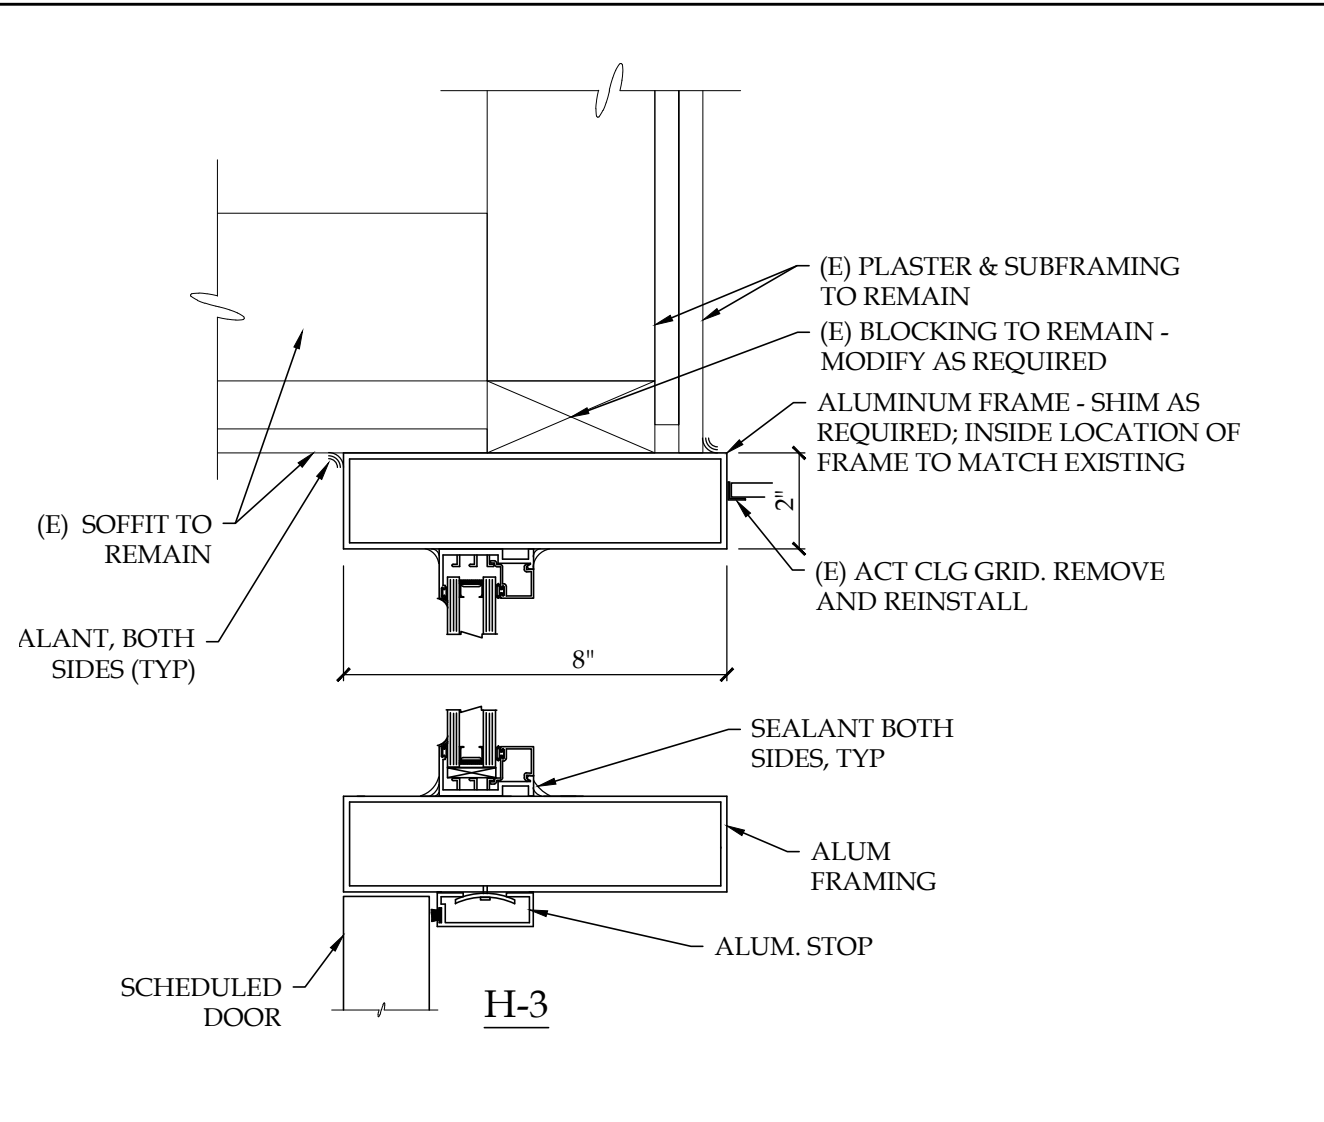


1 PARTIAL FLOOR PLAN @ DOOR #008
1/4" = 1'-0"

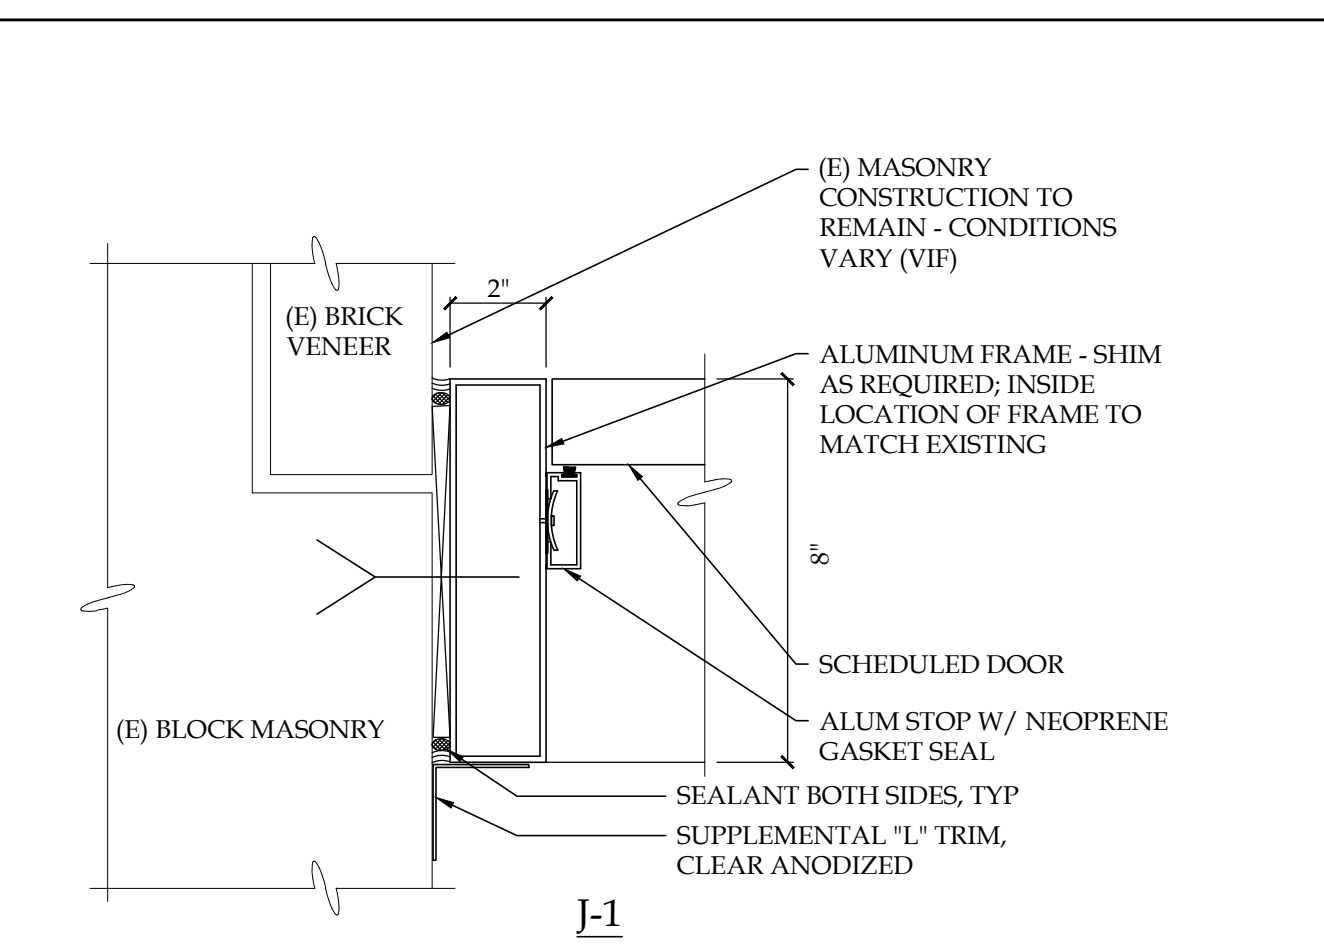


2 DOOR FRAME TYPES
1/4" = 1'-0"

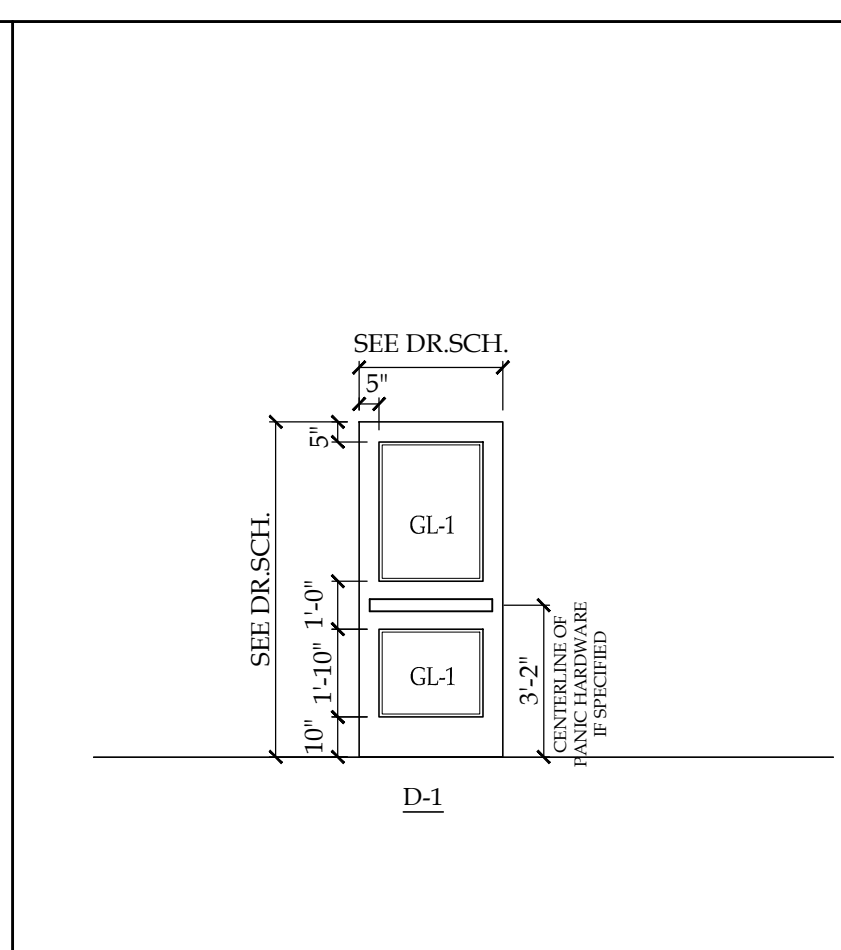


3 DOOR TYPES
1/4" = 1'-0"

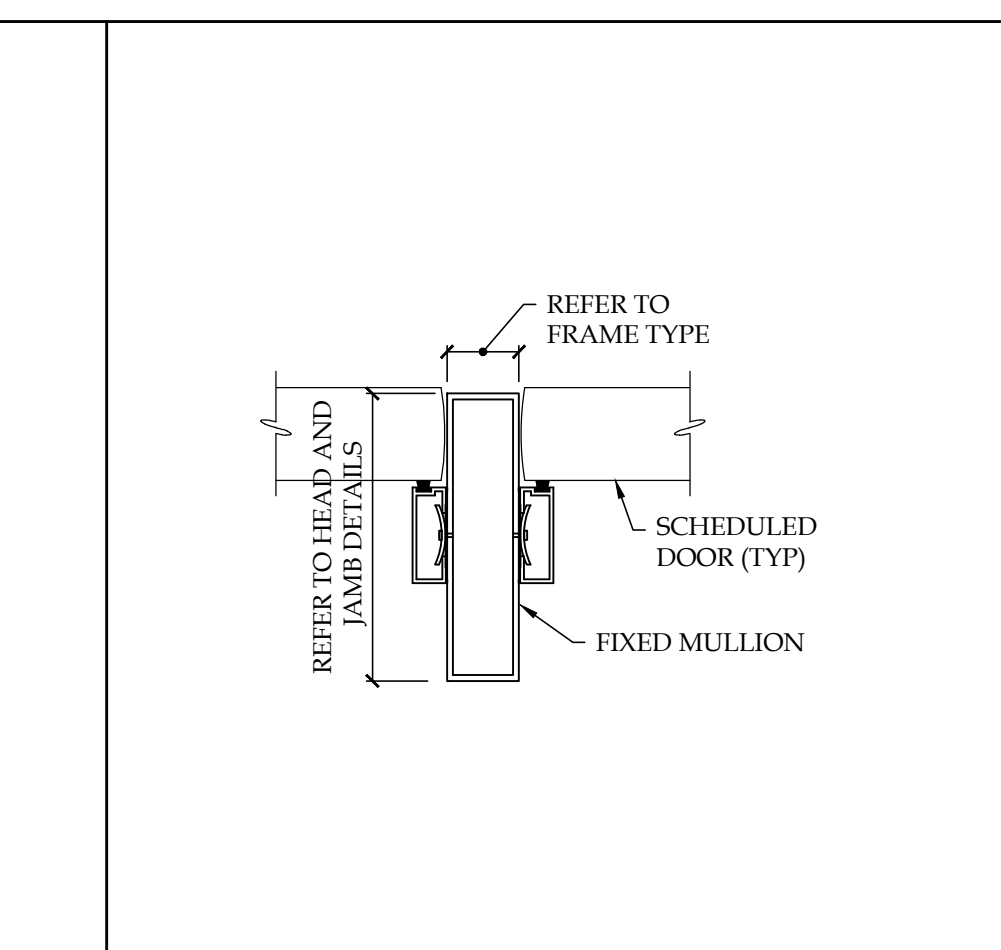


4 FIXED MULLION DETAIL
3/4" = 1'-0"

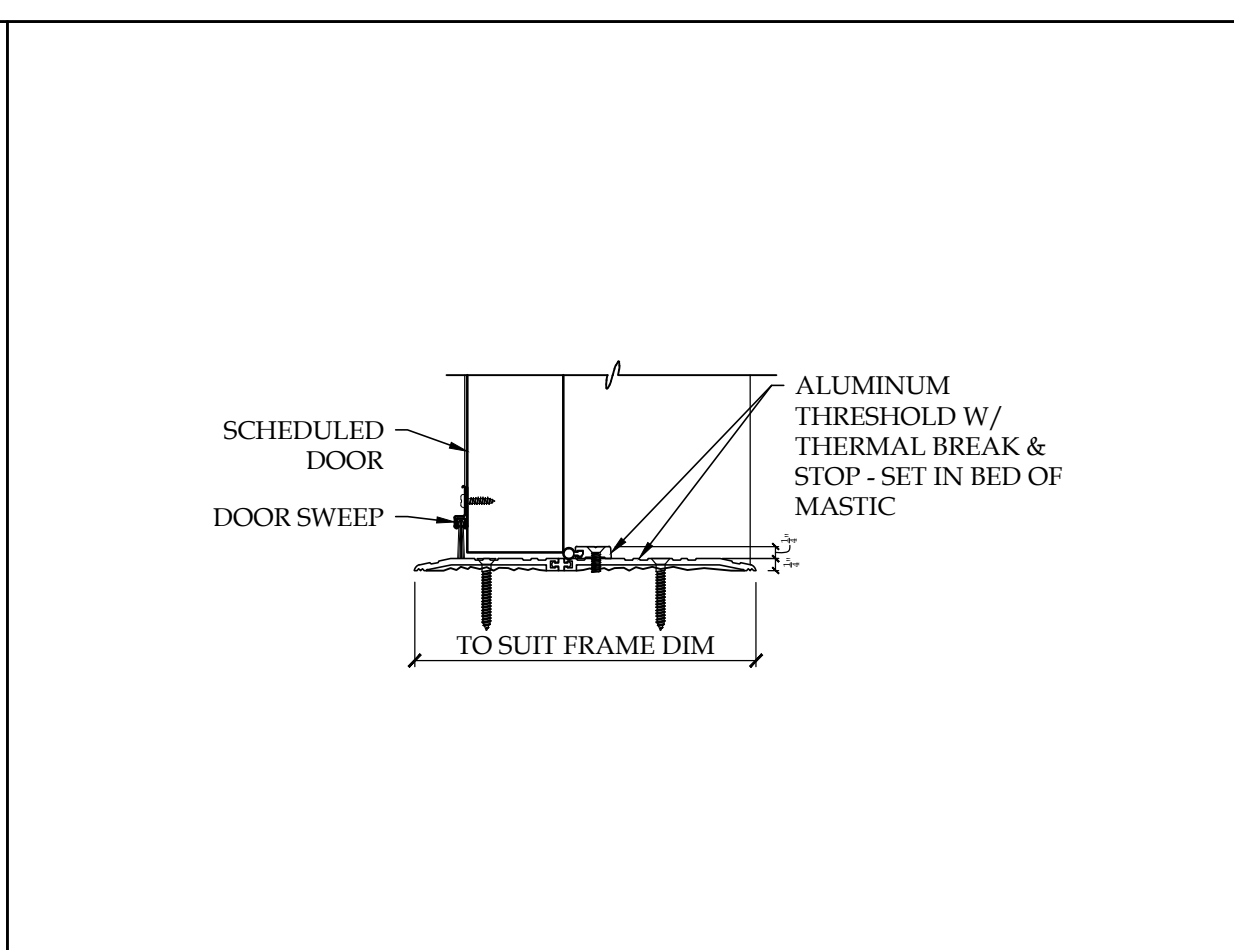

5 THRESHOLD DETAIL T-1
3/4" = 1'-0"

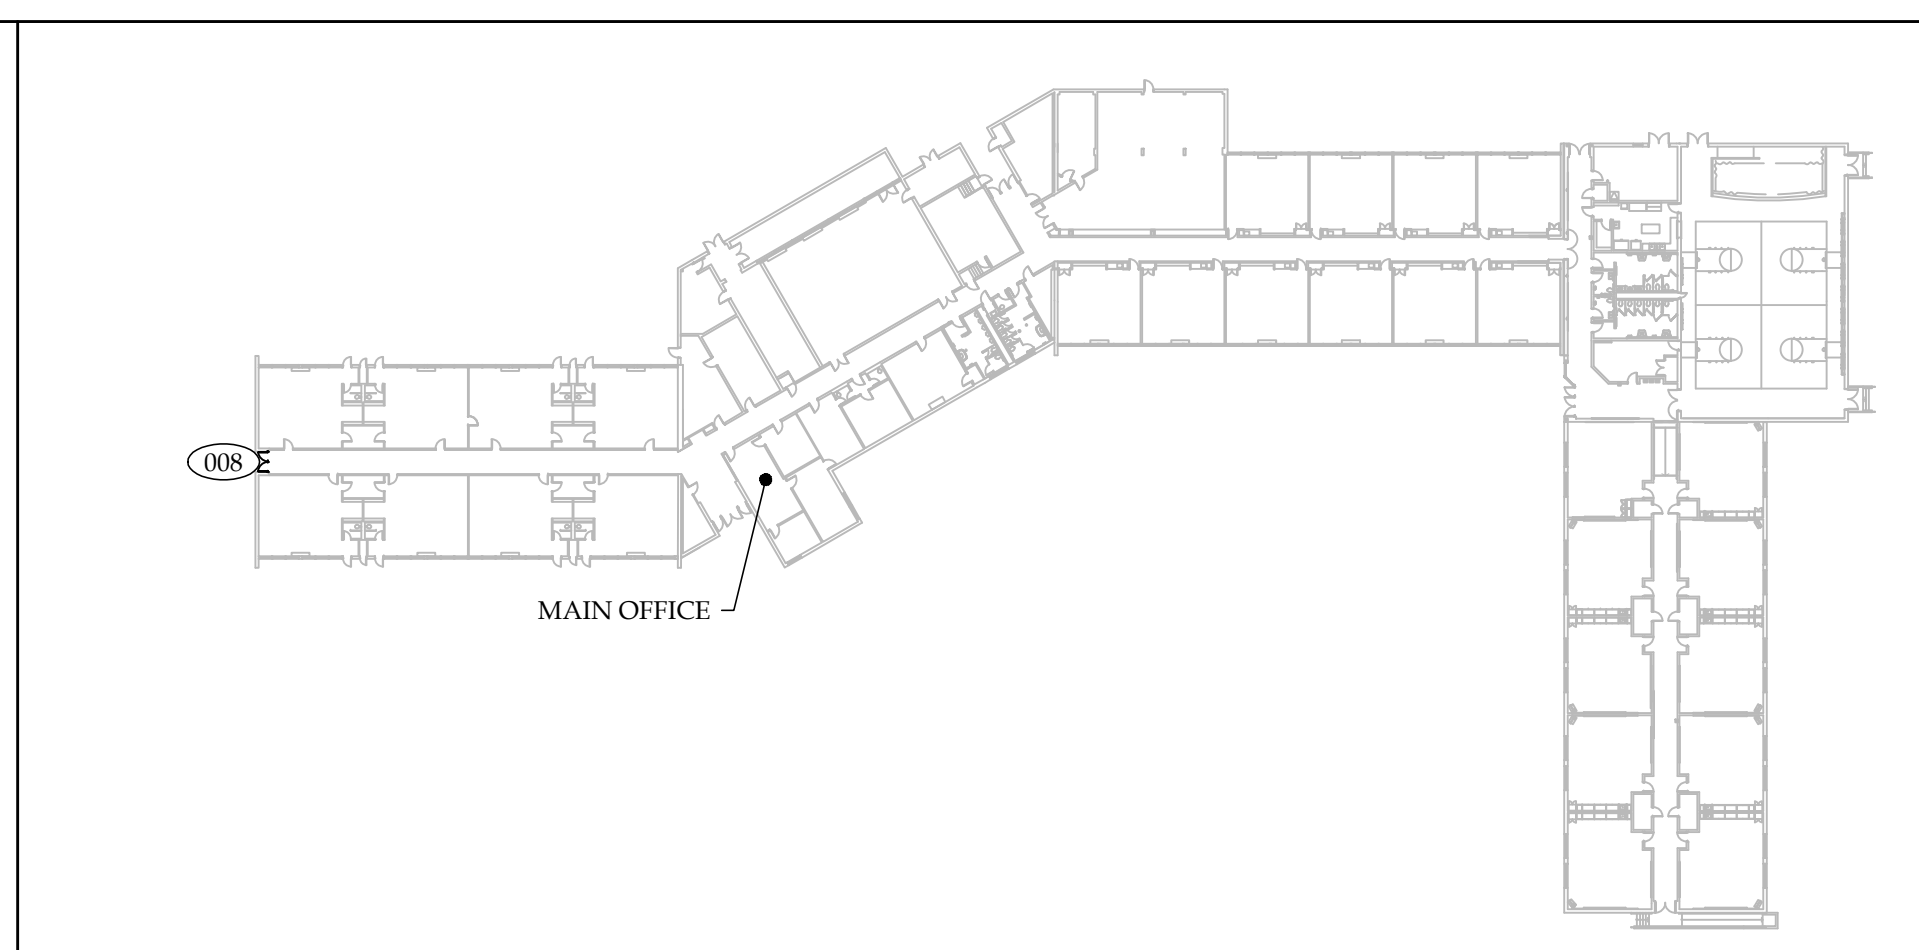

KEY PLAN

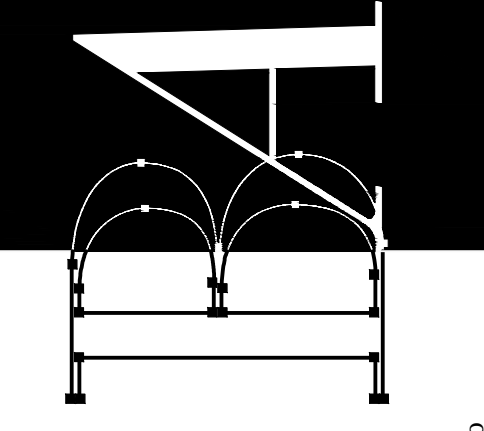

BECICA ASSOCIATES LLC
 Architecture/Engineering
 500 South Kings Highway
 Cherry Hill, New Jersey 08034
 P: 856.795.1180
 F: 856.354.6367
 W: www.becica.com

Signature/Date
 STEVEN A. BECICA, R.A., N.J. 21A010137600
 NJ Certificate of Professional Architecture - 21A00027000 / Engineering - 21A00026000

Exterior Door Replacement & Related Work at the
Woodcrest Elementary School
 400 CRANFORD ROAD, CHERRY HILL, NEW JERSEY 08003
 Lot: 1 Block: 528.17
 Cherry Hill Board Of Education
 PO Box 0015, 45 Randolph Terrace, Cherry Hill, New Jersey 08034

Contractor shall check and verify all conditions and dimensions at the site before proceeding with this work.

Revisions		
#	Date	Description

Set Issue:
Issued for Bidding
 Issue Date: April 5, 2019
 Drawing Title:
**Plans, Details
 Notes & Schedules**
 Drawn by: _____ Checked by: _____
DB
 Project Number:
19CHS-13021
 DOE State Plan Number #:
 Drawing Number:
A-1.1

DOOR NUMBER	DOOR						FRAME					MISCELLANEOUS			REMARKS
	SIZE		DOOR TYPE	# OF LEAVES	DOOR MATL.	DOOR THICK'N	FRAME TYPE	FRAME MATERIAL	MULLION	JAMB	HEAD	THRESHOLD	H.W SET	GLASS	
	WIDTH	HEIGHT													
24	3'-0"	6'-8"	D-1	2	FRP	1-3/4"	F-2	ALUM	REMOVABLE	J-1	H-1	T-1	6	-	
25A 25B	2'-0" 3'-0"	6'-8"	D-1 D-2	2	FRP	1-3/4"	F-1	ALUM	-	J-1	H-1	T-1	12	N/A GL-1	

DOOR SCHEDULE NOTES:

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GL-1: 1" INSULATED, LAMINATED, TINTED (EVERGREEN), SAFETY GLAZING

LEGEND

ALUM	ALUMINUM
(E)	EXISTING TO REMAIN
(ER)	EXISTING RELOCATED
FRP	FIBERGLASS REINFORCED POLYESTER
(R)	REMOVE EXISTING
(RE)	RELOCATE EXISTING
V.I.F.	VERIFY IN FIELD

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REHABILITATION SUBCODE NJUCC, SUBCHAPTER 6

BUILDING ANALYSIS
(FROM IBC 2015 - NEW JERSEY EDITION)


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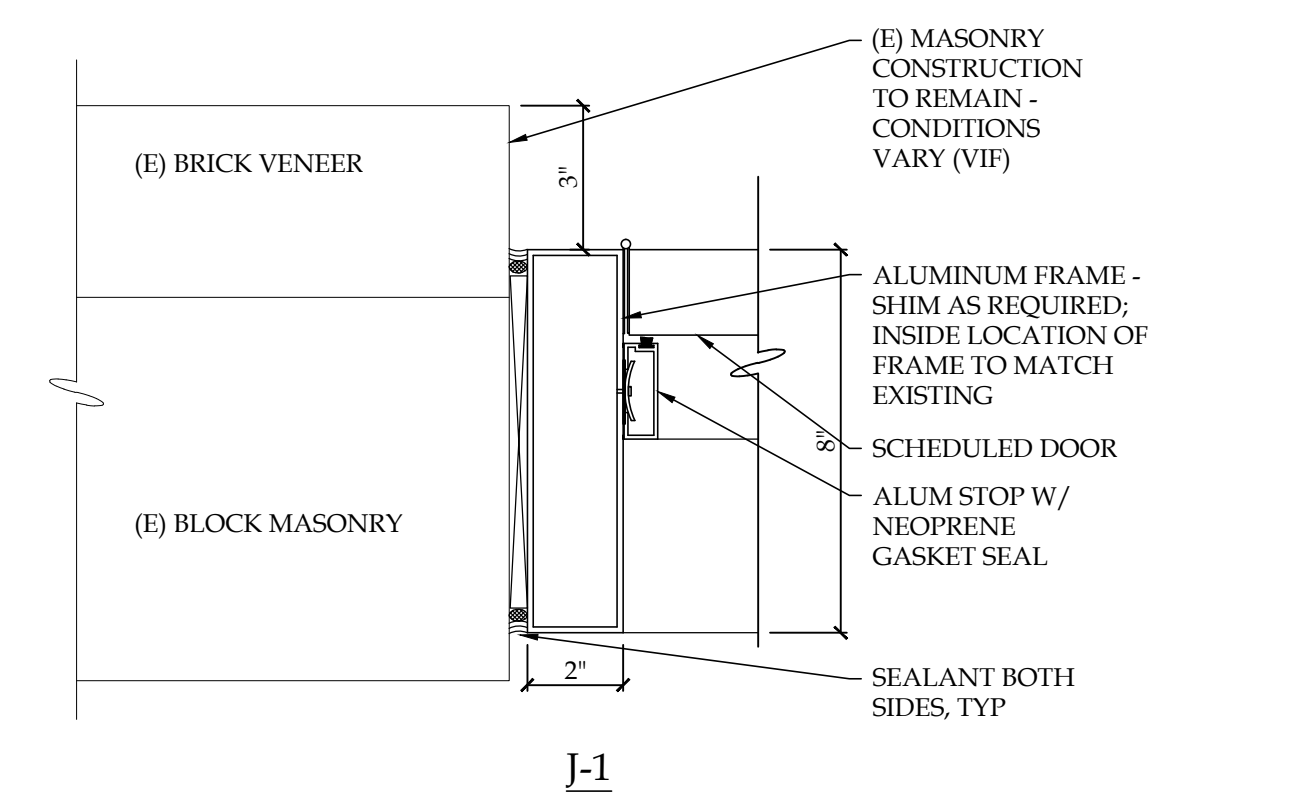
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GENERAL NOTES:









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- COORDINATE ALL SERVICE AND UTILITY INTERRUPTIONS WITH THE OWNER TO AVOID INTERRUPTING THE OWNER'S OPERATIONS.



8 HEAD DETAIL H-1
3/4" = 1'-0"

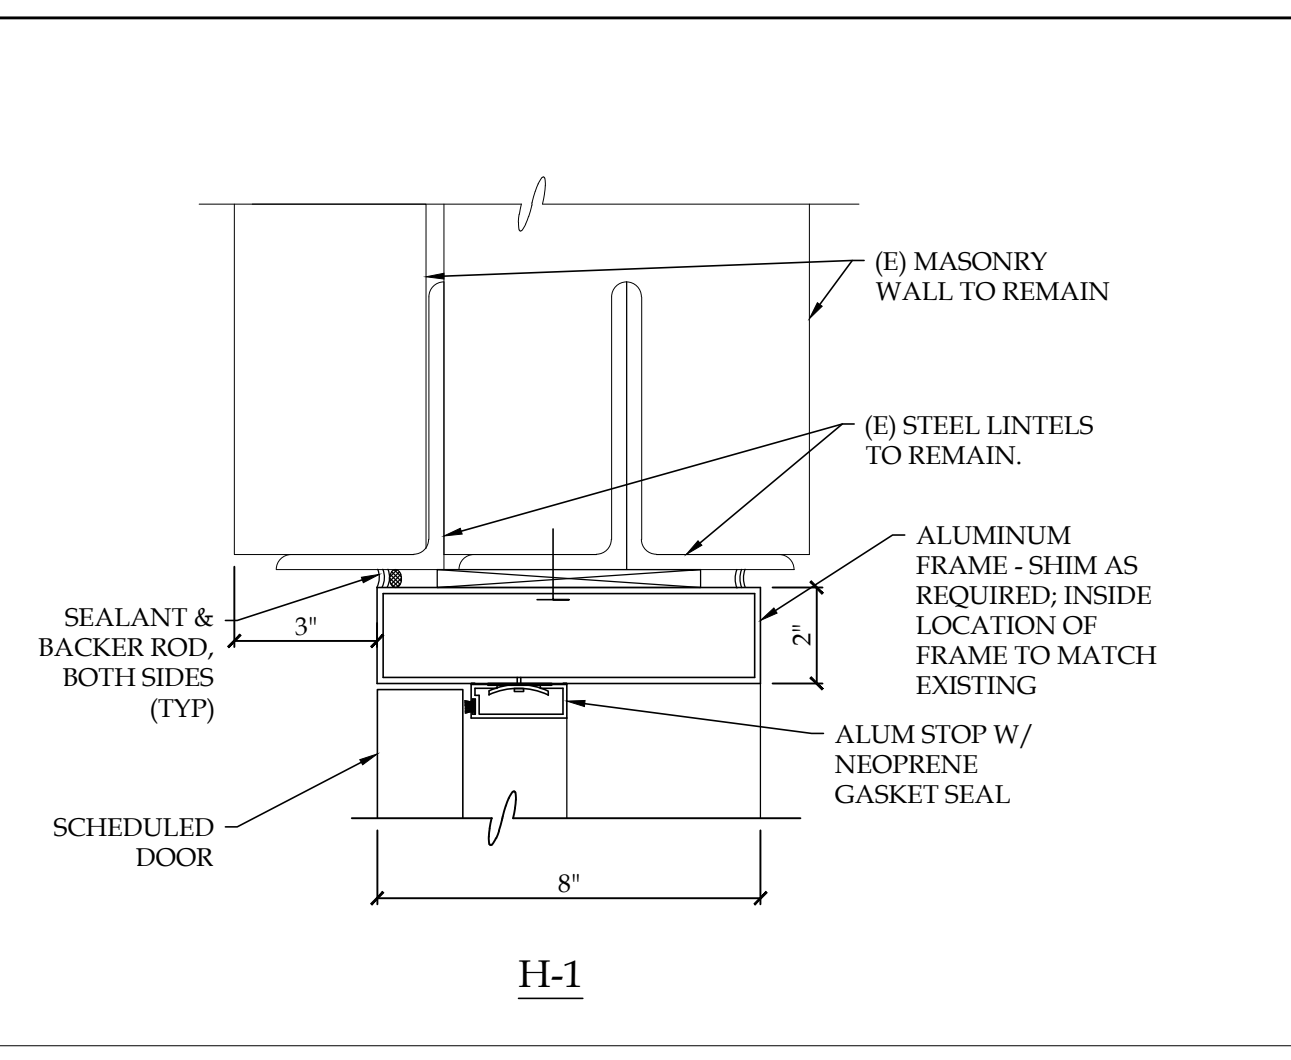

5 JAMB DETAIL J-1
3/4" = 1'-0"

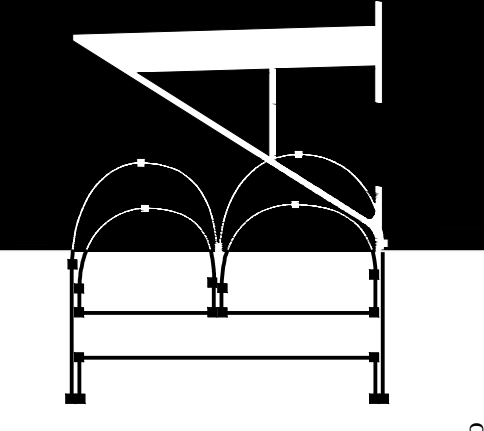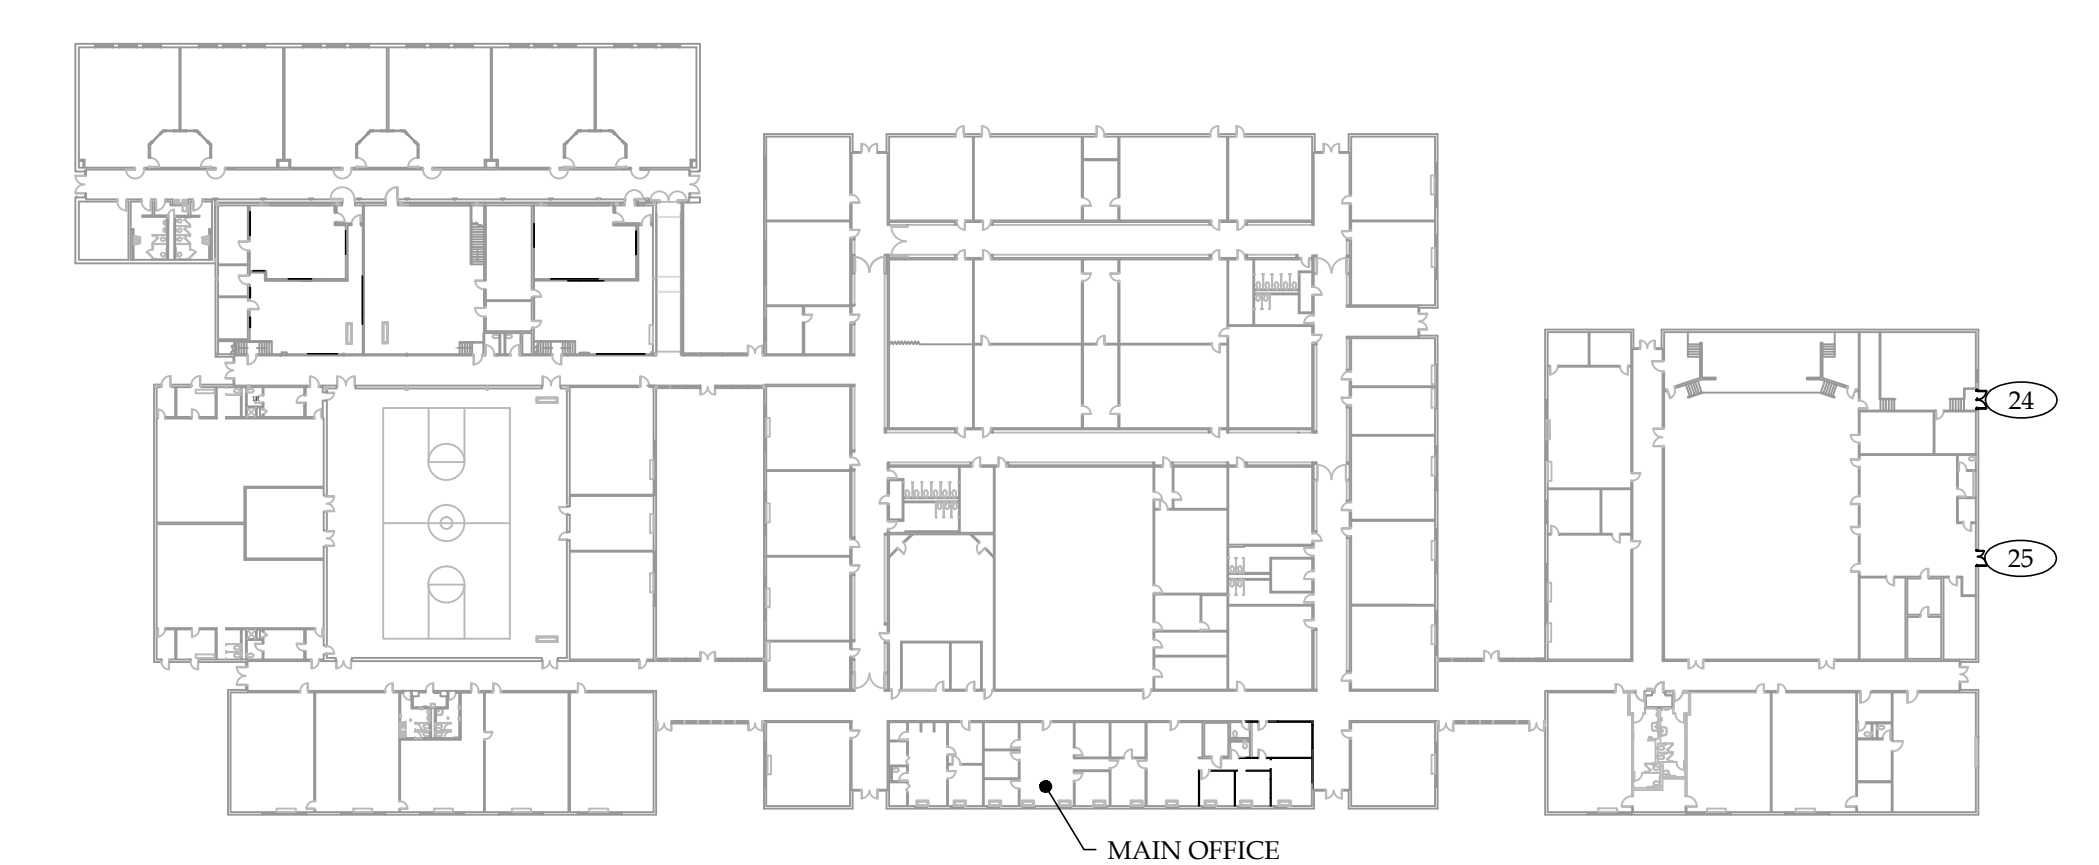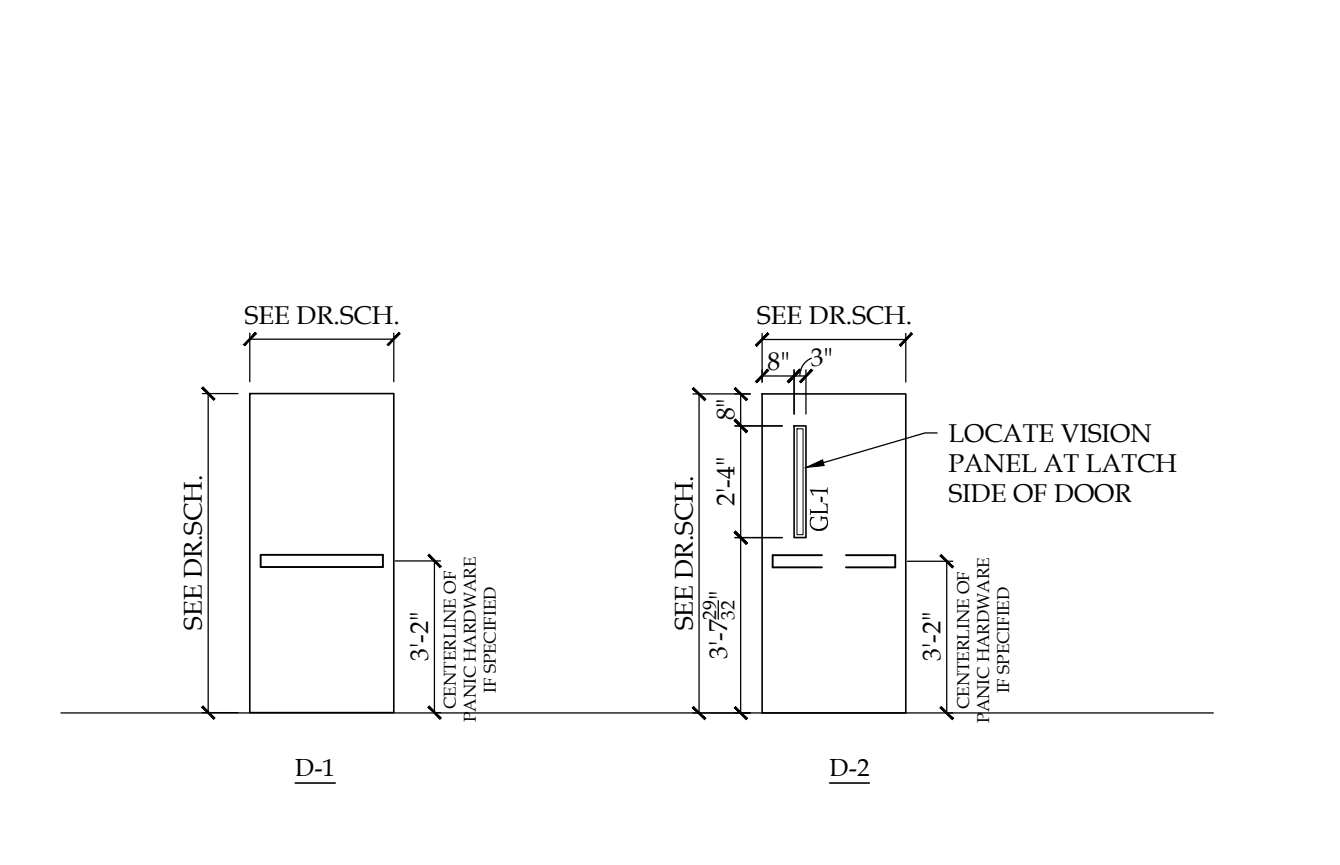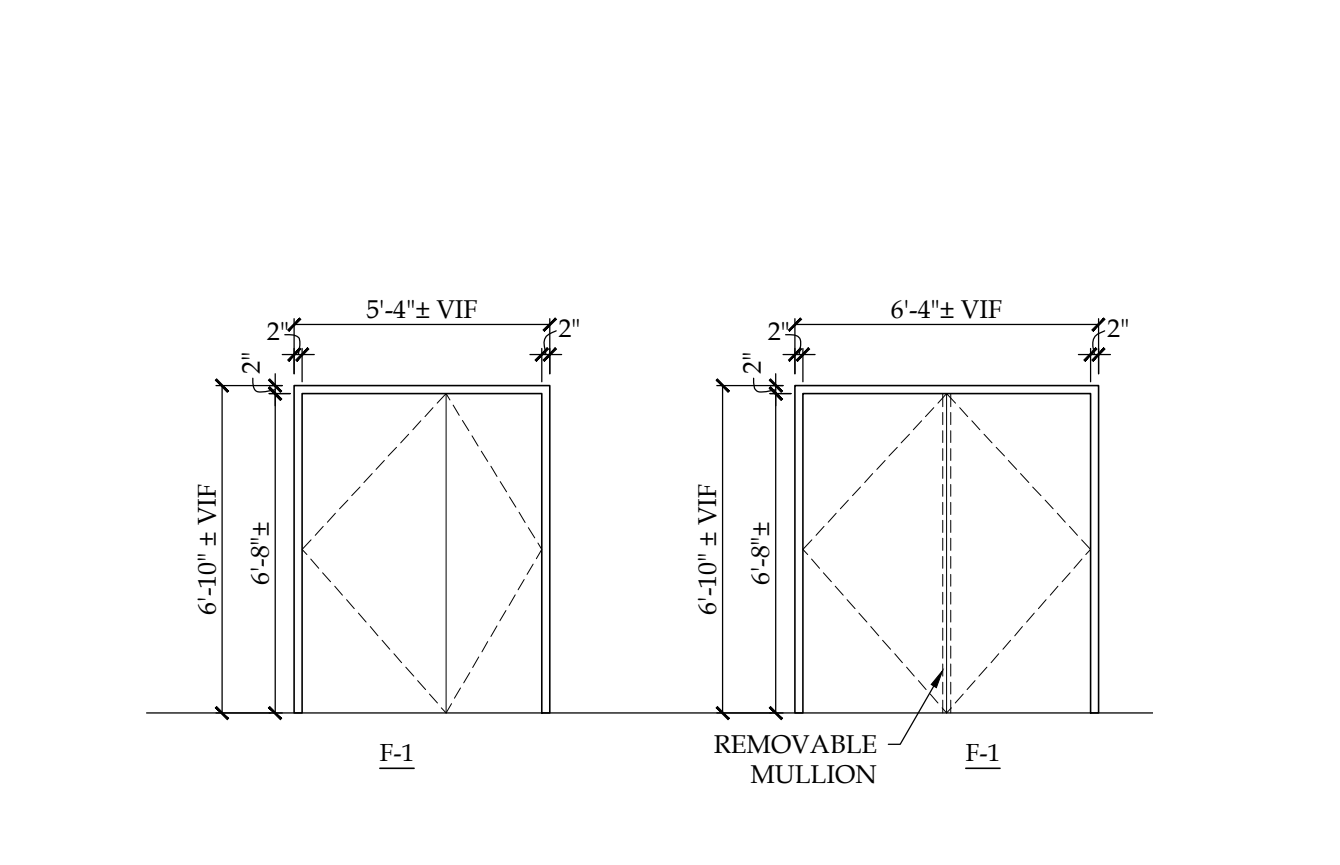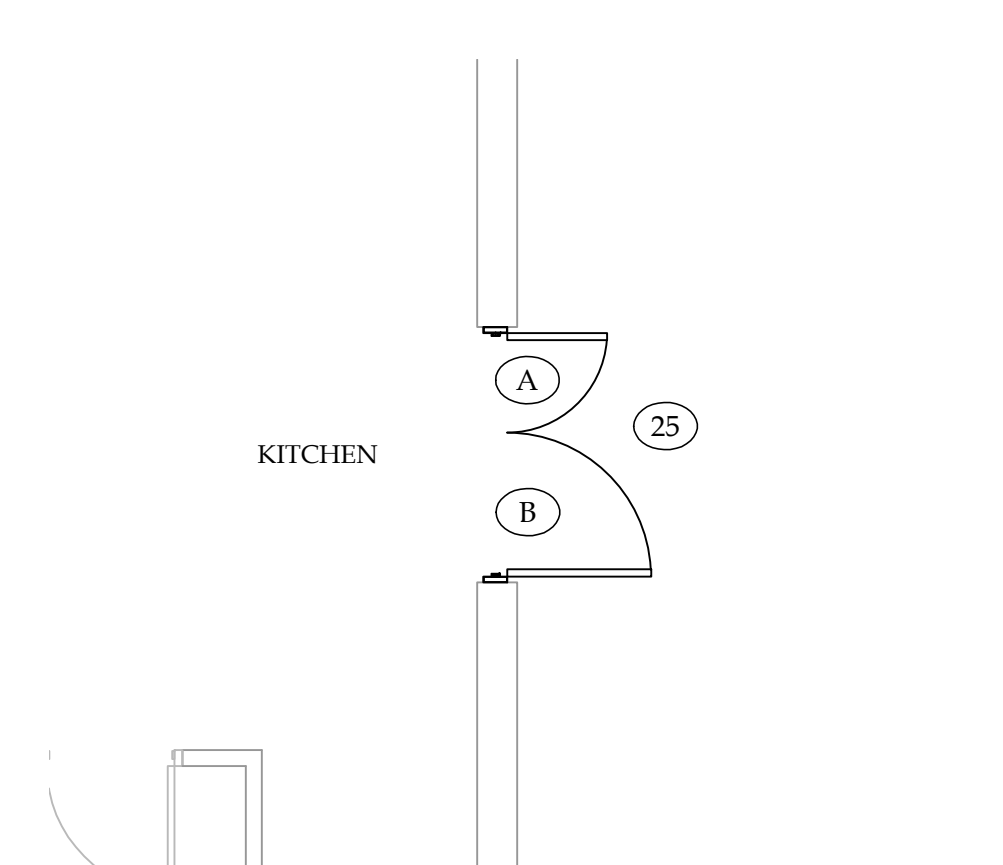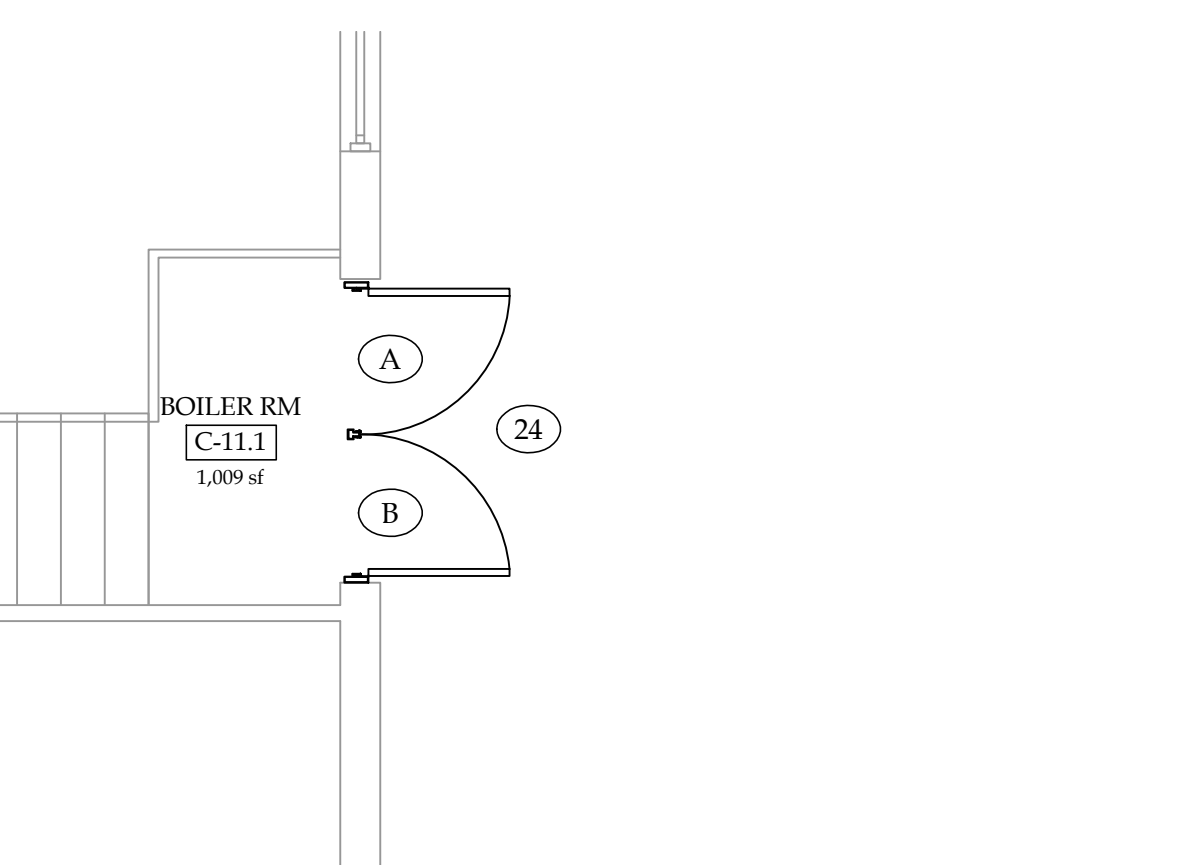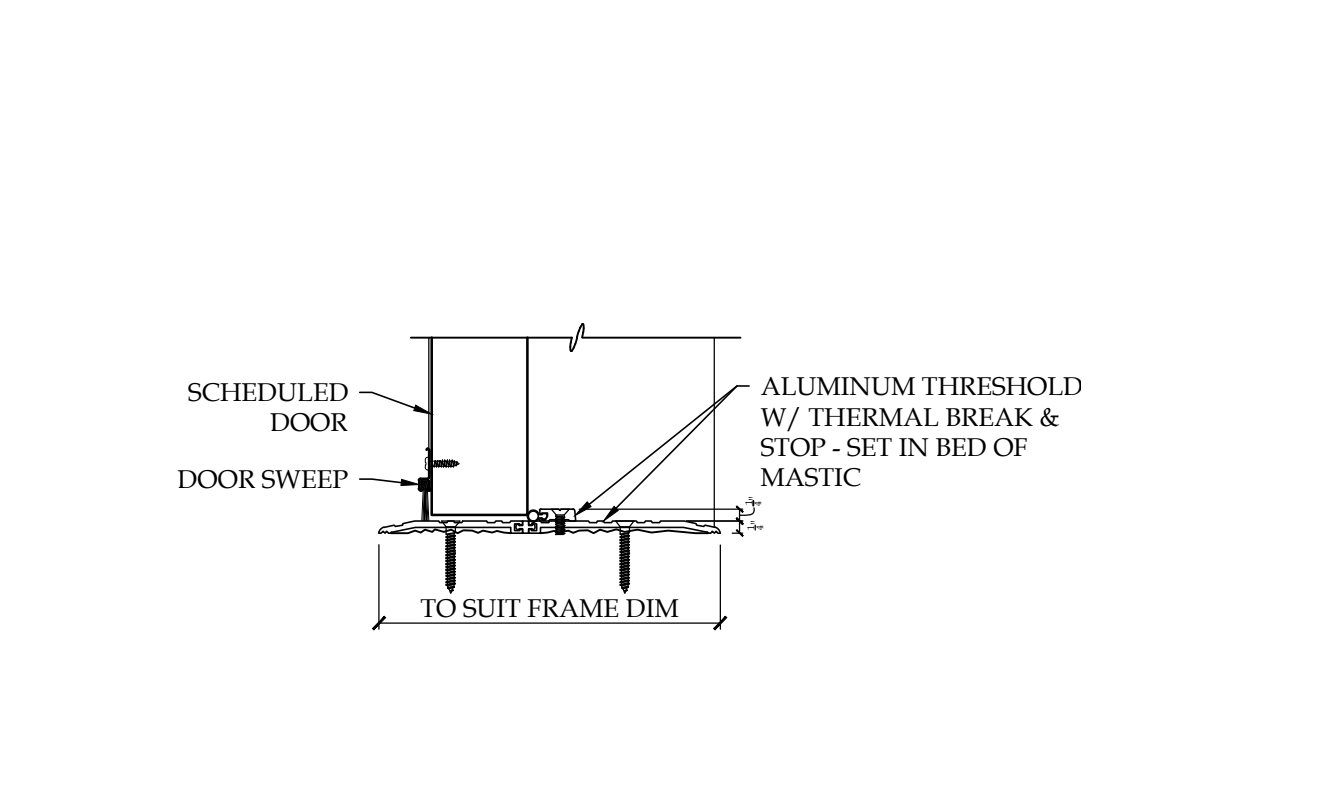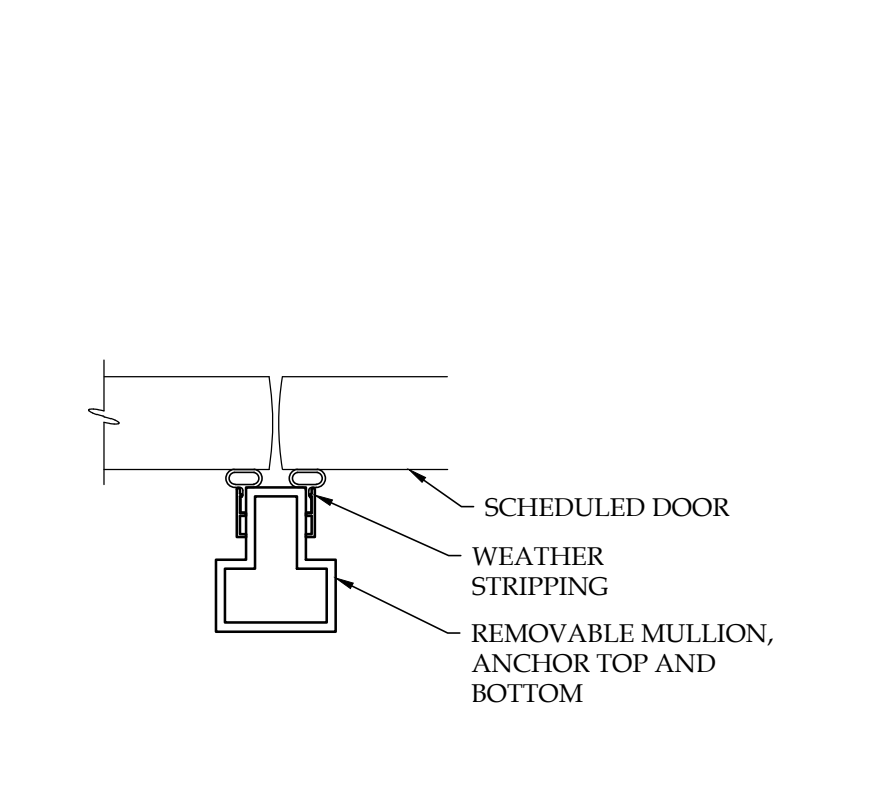

BECICA ASSOCIATES LLC
Architecture/Engineering
500 South Kings Highway
Cherry Hill, New Jersey 08034
P: 856.795.1180
F: 856.354.6367
W: www.becica.com

Signature/Date
STEVEN A. BECICA, R.A., N.J. License No. 12A101137600
NJ Certificate of Professional Architecture - 22A00027010 / Engineering - #616826260

Exterior Door Replacement & Related Work at the Beck Middle School
950 Cropwell Road, Cherry Hill, New Jersey 08003
Lot 5, Block 513.51
Cherry Hill Board of Education
PO Box 5015, 45 Randolph Terrace, Cherry Hill, New Jersey 08034

Contractor shall check and verify all conditions and dimensions at the site before proceeding with this work.

Revisions		
#	Date	Description

Set Issue:
Issued for Bidding
Issue Date: April 5, 2019
Drawing Title:
**Plans, Details
Notes & Schedules**
Drawn by: _____ Checked by: _____
Project Number:
DB
19CHS-14028
DOE State Plan Number #:
Drawing Number:
A-1.1

DOOR SCHEDULE															
DOOR NUMBER	DOOR						FRAME					MISCELLANEOUS			REMARKS
	SIZE		DOOR TYPE	# OF LEAVES	DOOR MAT'L	DOOR THICK'N	FRAME TYPE	FRAME MATERIAL	MULLION	JAMB	HEAD	THRESHOLD	H.W.SET	GLASS	
	WIDTH	HEIGHT													
7	3'-0"	6'-6"	D-1	2	FRP	1-3/4"	F-1	ALUM	REMOVABLE	J-1	H-1	T-1	6	GL-1	

- (E) STEEL LINTELS ABOVE OPENING TO BE SCRAPED, CLEANED, PRIMED & PAINTED
- DOOR & FRAME TO RECEIVE ELECTRICAL POWER TRANSFER FOR FUTURE CARD ACCESS - SEE HARDWARE SCHEDULE. CONTRACTOR TO TERMINATE CONTROL WIRING AND COIL ABOVE CEILING FOR FUTURE CONNECTION TO OWNER PROVIDED POWER SUPPLY.
- PROVIDE HEAD & JAMB ANGLE TRIM AT FRAME EXTERIOR TO MATCH NEW FRAME.

GLAZING SCHEDULE

GL-1: 1" INSULATED, LAMINATED, TINTED (EVERGREEN), SAFETY GLAZING

LEGEND

ALUM ALUMINUM
(E) EXISTING TO REMAIN
(ER) EXISTING RELOCATED
FRP FIBERGLASS REINFORCED POLYESTER
(R) REMOVE EXISTING
(RE) RELOCATE EXISTING
V.I.F. VERIFY IN FIELD

GENERAL DOOR / FRAME NOTES:

- DEMOLISH (E) FRAME & DOOR SYSTEMS IN THEIR ENTIRETY AT ALL LOCATIONS TO RECEIVE NEW DOOR AND FRAMES AS INDICATED; PREPARE ADJACENT FINISHES TO ACCOMMODATE NEW ALUMINUM FRAME & DOORS COLORS TO BE SELECTED BY ARCHITECT
- REPAIR (E) FINISHES TO MATCH (E) ADJACENT AS REQ'D TO ACCOMMODATE NEW WORK.
- FASTENER SELECTION AND PATTERN SHALL COMPLY WITH DESIGN LOADS.

CODE ANALYSIS

APPLICABLE CODES

BUILDING SUBCODE EDITION INTERNATIONAL BUILDING CODE / 2015, NEW JERSEY ICC / ANSI A117.1 - 2009 INTERNATIONAL FIRE CODE / 2015

ELECTRICAL SUBCODE NATIONAL ELECTRICAL CODE / 2015
REHABILITATION SUBCODE NJUCC, SUBCHAPTER 6

BUILDING ANALYSIS
(FROM IBC 2015 - NEW JERSEY EDITION)


THE FLOOR PLAN AREA AND HEIGHT OF THE SCHOOL BUILDING HAS NOT CHANGED UNDER THIS PROJECT, THEREFORE NO ANALYSIS OF THE EXISTING BUILDING HAS BEEN PROVIDED.

EGRESS ANALYSIS
(FROM NEW JERSEY REHABILITATION SUBCODE 523-6)


THE OCCUPANT LOAD OF THE SCHOOL HAS NOT CHANGED UNDER THIS PROJECT, THEREFORE AN EGRESS ANALYSIS HAS NOT BEEN PROVIDED.

GENERAL NOTES:


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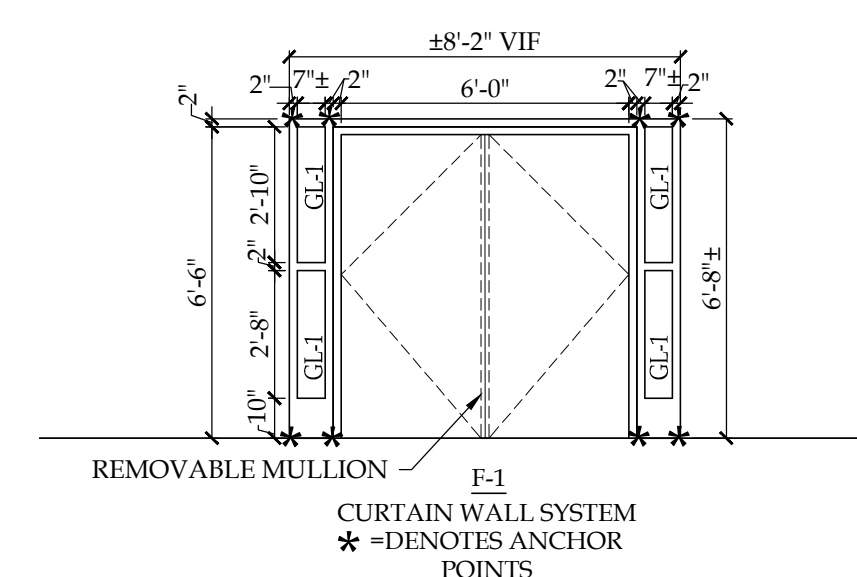
7 PARTIAL FLOOR PLAN @ DOOR #012
1/4" = 1'-0"

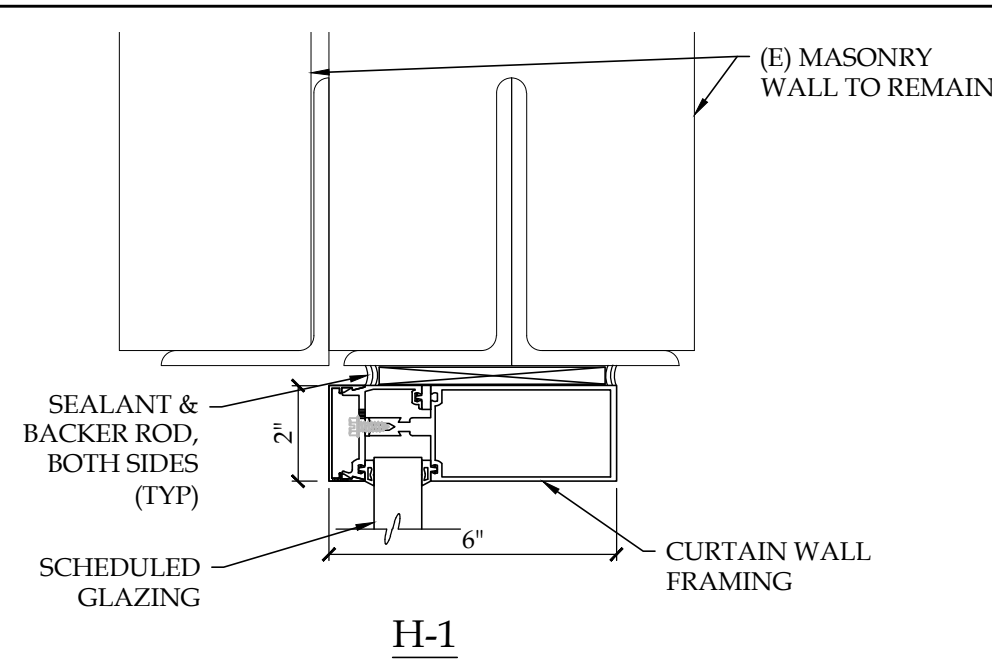


6 PARTIAL FLOOR PLAN @ DOOR #012
1/4" = 1'-0"

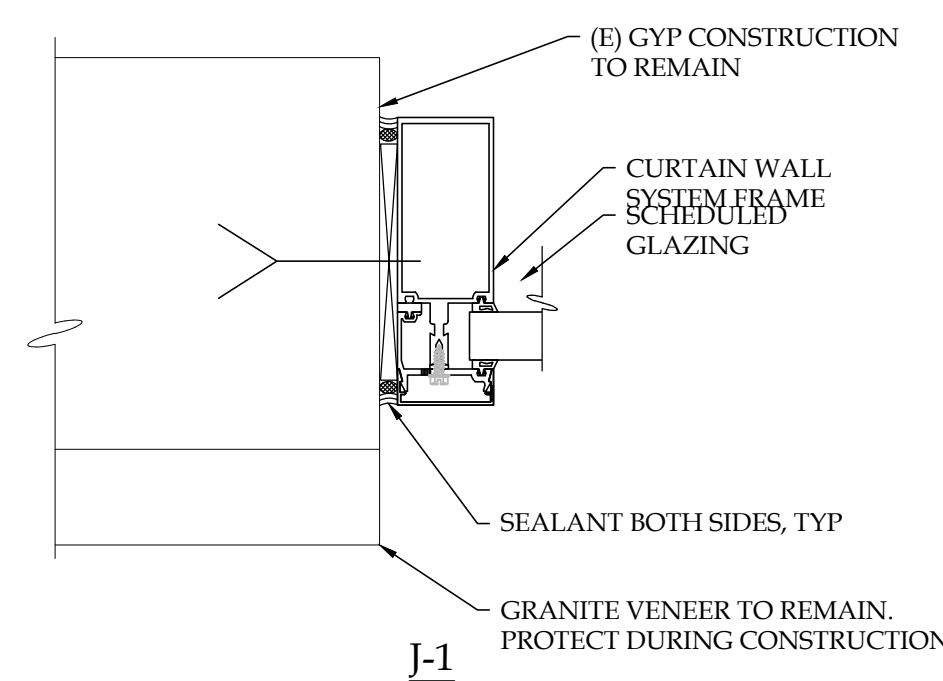


1 PARTIAL FLOOR PLAN @ DOOR #7
1/4" = 1'-0"

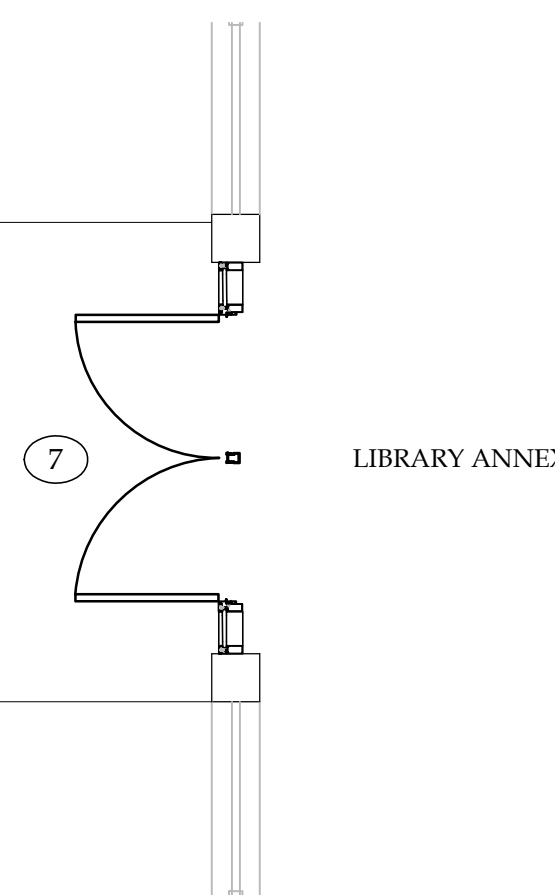


2 DOOR FRAME TYPES
1/4" = 1'-0"

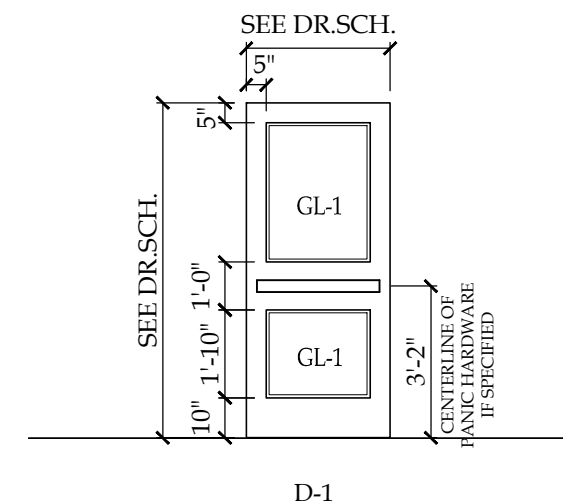


3 DOOR TYPES
1/4" = 1'-0"

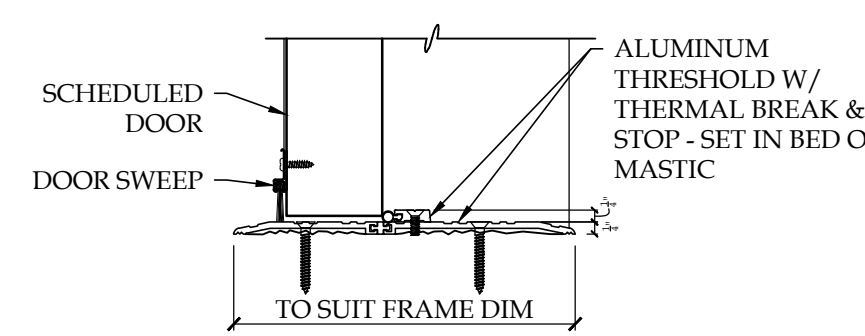


4 THRESHOLD DETAIL T-1
1/4" = 1'-0"

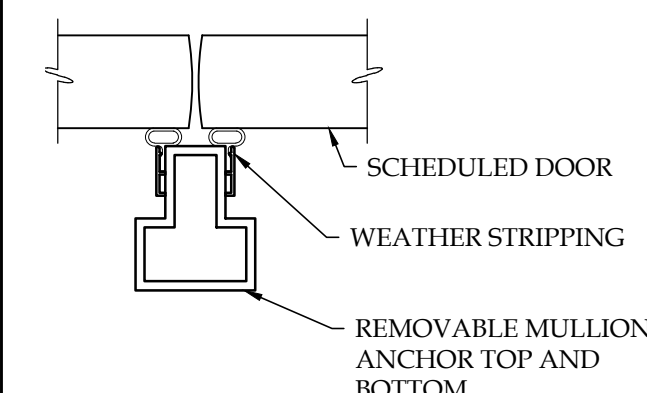

5 REMOVABLE MULLION DETAIL
1/4" = 1'-0"

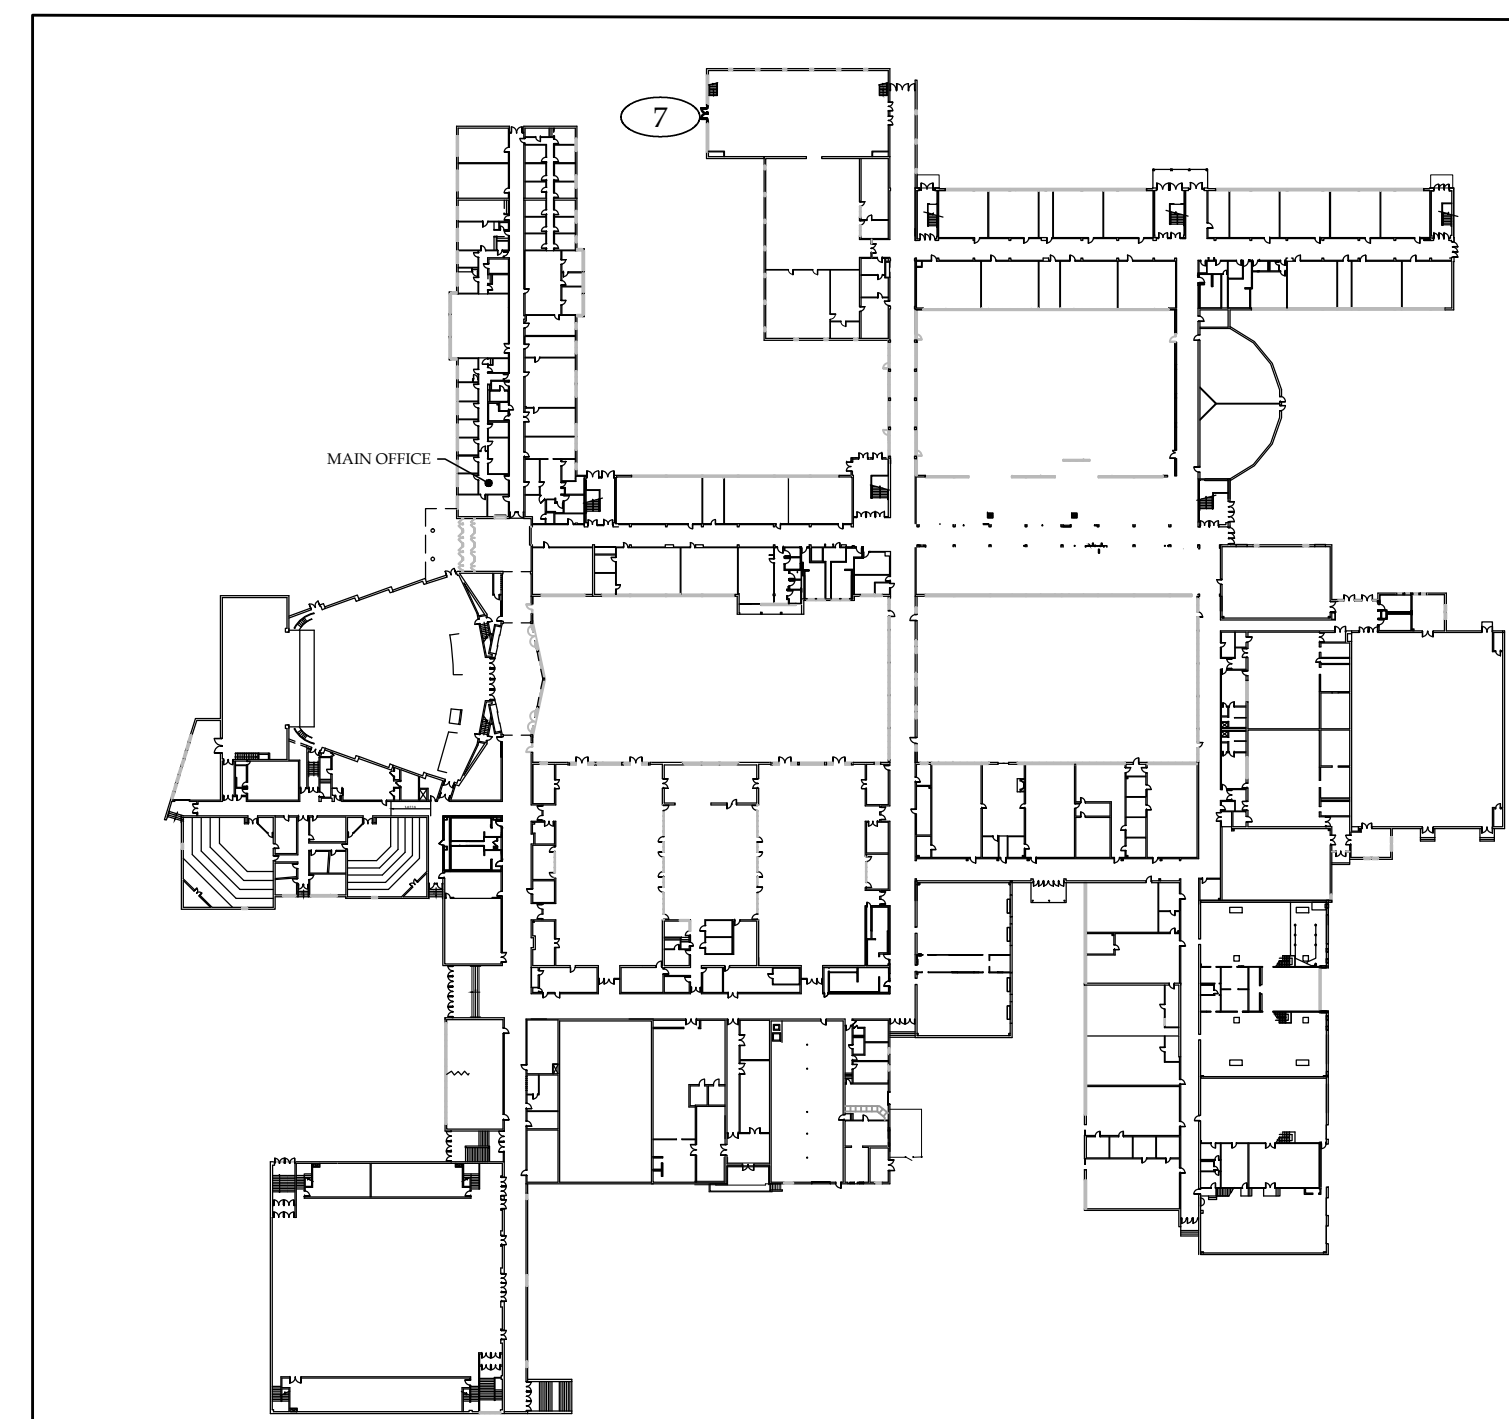

KEY PLAN

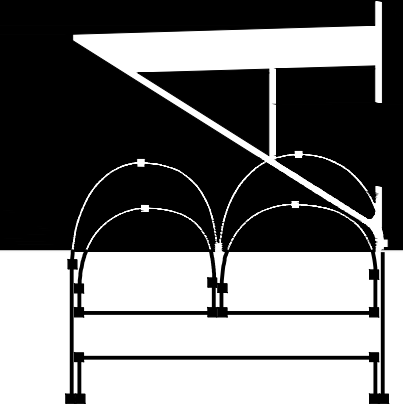

BECICA ASSOCIATES LLC
Architecture/Engineering
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Cherry Hill, New Jersey 08034
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Exterior Door Replacement & Related Work at the
Cherry Hill High School East
1750 Kresson Rd., Cherry Hill, N.J. 08034
Lot: 1 Block: 524.181
Cherry Hill Board Of Education
PO Box 5015, 45 Randolph Terrace, Cherry Hill, New Jersey 08034

Contractor shall check and verify all conditions and dimensions at the site before proceeding with this work.	
#	Date
	Description

Set Issue:

Issued for Bidding

Issue Date: April 5, 2019

Drawing Title:
**Plans, Details
Notes & Schedules**

Drawn by: _____ Checked by: _____

Project Number:
19CHS-17075
DOE State Plan Number #:

Drawing Number:
A-1.1

DOOR NUMBER	DOOR						FRAME					MISCELLANEOUS			REMARKS	
	SIZE		DOOR TYPE	# OF LEAVES	DOOR MAT'L	DOOR THICK'N	FRAME TYPE	FRAME MATERIAL	MULLION	JAMB	HEAD	THRESHOLD	H.W SET	GLASS		
	WIDTH	HEIGHT														
7A 7B	(E)	(E)	(E)	(E)	(E)	(E)	(E)	(E)	(E)	(E)	(E)	(E)	1	(E)	(E) DOORS & FRAMES TO REMAIN, PROVIDE HARDWARE ONLY. ANNOTATION #5	
DI-7A DI-7B	(E)	(E)	(E)	(E)	(E)	(E)	(E)	(E)	(E)	(E)	(E)	(E)	2	(E)		
14	3'-0"	7'-2"	D-1	2	FRP	0'-1 3/4"	(E)	(E)	(E)	(E)	(E)	(E)	3	GL-2		ANNOTATION #1, 2, 3, 4 & 5
26A 26B	USE (E)	USE (E)	USE (E)	2	(E)	(E)	F-2	ALUM		J-1	H-1	T-1	3	(E)		REPLACE (E) FRAMES, (E) DOORS TO REMAIN, PROVIDE NEW HARDWARE. ANNOTATION #5
34A 34B	USE (E)	USE (E)	USE (E)	2	(E)	(E)	F-2	ALUM		J-1	H-1	T-1	3	(E)		
35	USE (E)	USE (E)	USE (E)	2	(E)	(E)	F-2	ALUM		J-1	H-1	T-1	3	(E)		
49	3'-1"	7'-2"	D-1	2	FRP	0'-1 3/4"	F-1	ALUM	REMOVABLE	J-1	H-1	T-1	6	GL-2		

DOOR SCHEDULE ANNOTATIONS:

- REPLACE DOORS & HARDWARE ONLY, (E) FRAMES TO REMAIN
- REMOVE EXISTING CONCRETE SILL, PATCH & GROUT SMOOTH
- REPLACE 8 S/F OF (E) PORCELAIN CERAMIC TILE. TILE PATTERN TO MATCH (E). COLOR AS SELECTED BY ARCHITECT
- PLUG (E) OPEN HOLES IN FRAMES WITH SCREWS OR PROVIDE COVER PLATE, FINISH TO MATCH FRAME
- PATCH (E) HOLES IN REUSED DOORS & FRAMES WITH COUNTERSUNK SCREWS, PLUG & COVER TO MATCH DOOR / FRAME COLOR. PROVIDE COVER PLATE OVER LARGER AREAS COLOR AND FINISH TO MATCH DOOR.

CODE ANALYSIS

APPLICABLE CODES

BUILDING SUBCODE EDITION INTERNATIONAL BUILDING CODE / 2015
NEW JERSEY
ICC / ANSI A117.1 - 2009
INTERNATIONAL FIRE CODE / 2015

ELECTRICAL SUBCODE NATIONAL ELECTRICAL CODE / 2015

REHABILITATION SUBCODE NJUCC, SUBCHAPTER 6

BUILDING ANALYSIS

(FROM IBC 2015 - NEW JERSEY EDITION)

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EGRESS ANALYSIS

(FROM NEW JERSEY REHABILITATION SUBCODE 5.23-6)

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DOOR SCHEDULE NOTES:

- (E) STEEL LINTELS ABOVE OPENING TO BE SCRAPED, CLEANED, PRIMED & PAINTED
- DOOR & FRAME TO RECEIVE ELECTRICAL POWER TRANSFER FOR FUTURE CARD ACCESS - SEE HARDWARE SCHEDULE. CONTRACTOR TO TERMINATE CONTROL WIRING AND COIL ABOVE CEILING FOR FUTURE CONNECTION TO OWNER PROVIDED POWER SUPPLY.
- PROVIDE HEAD & JAMB ANGLE TRIM AT FRAME EXTERIOR TO MATCH NEW FRAME.

GENERAL DOOR / FRAME NOTES:


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GLAZING SCHEDULE


GL-1: 1" INSULATED, LAMINATED, TINTED (ARTIC BLUE), SAFETY GLAZING

LEGEND


ALUM ALUMINUM
(E) EXISTING TO REMAIN
(ER) EXISTING RELOCATED
FRP FIBERGLASS REINFORCED POLYESTER
(R) REMOVE EXISTING
(RE) RELOCATE EXISTING
V.I.F. VERIFY IN FIELD

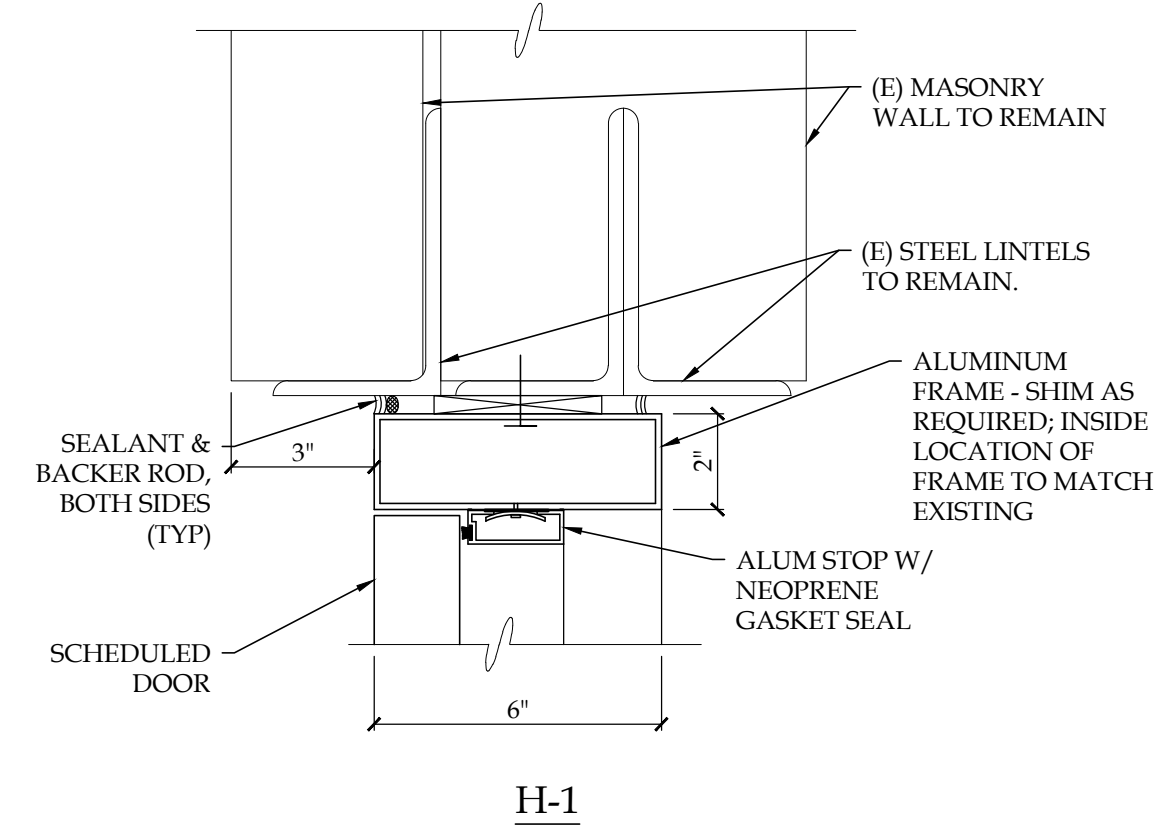


11 HEAD DETAIL H-1
3'-1 1/2"

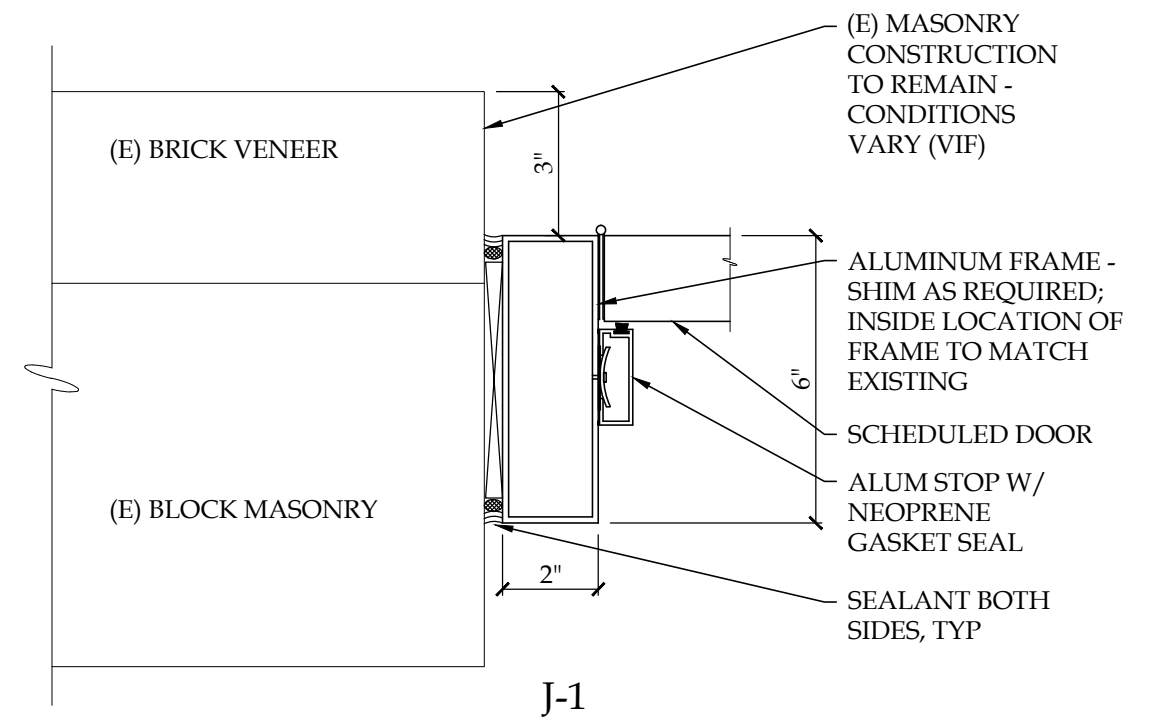


10 JAMB DETAIL J-1
3'-1 1/2"

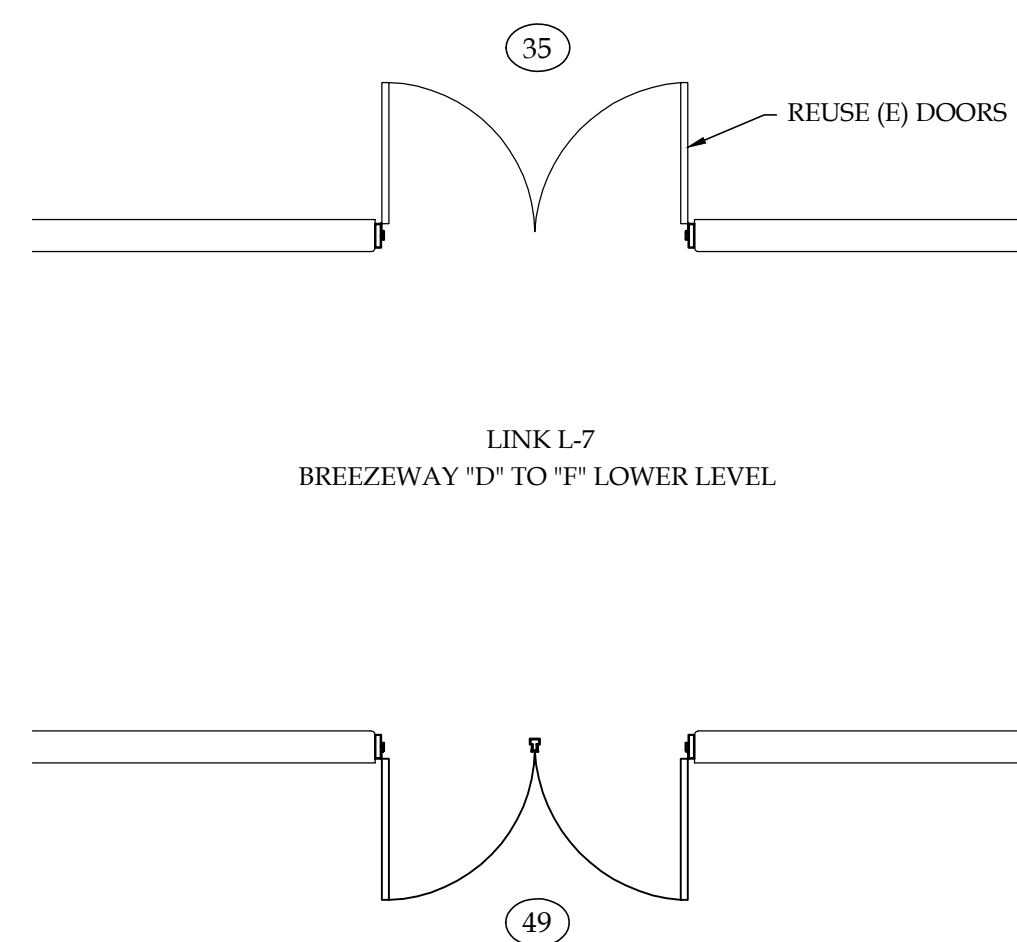


4 PARTIAL FLOOR PLAN @ DOORS #35 & 49
1/4" = 1'-0"

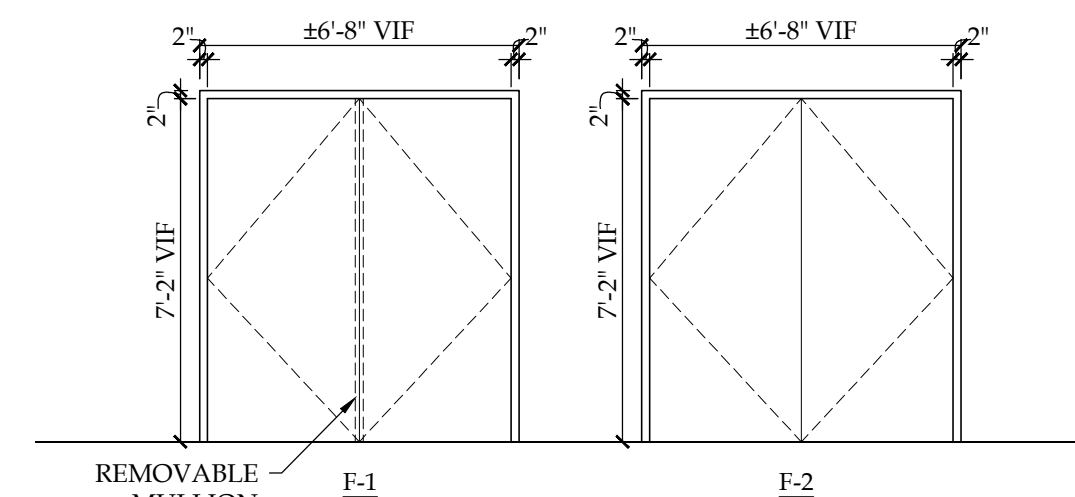


5 DOOR FRAME TYPES
1/4" = 1'-0"

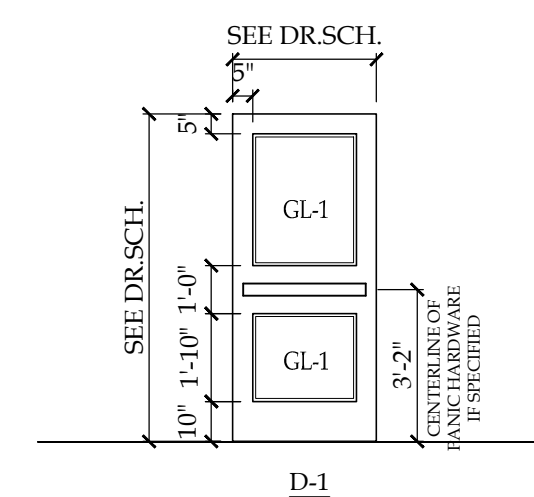


6 DOOR TYPES
1/4" = 1'-0"

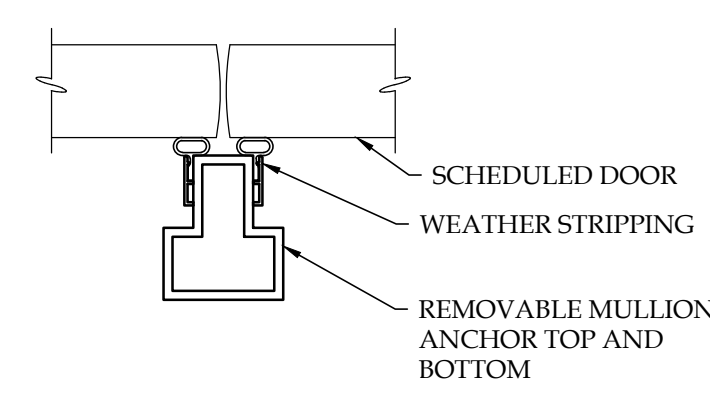


7 REMOVABLE MULLION DETAIL
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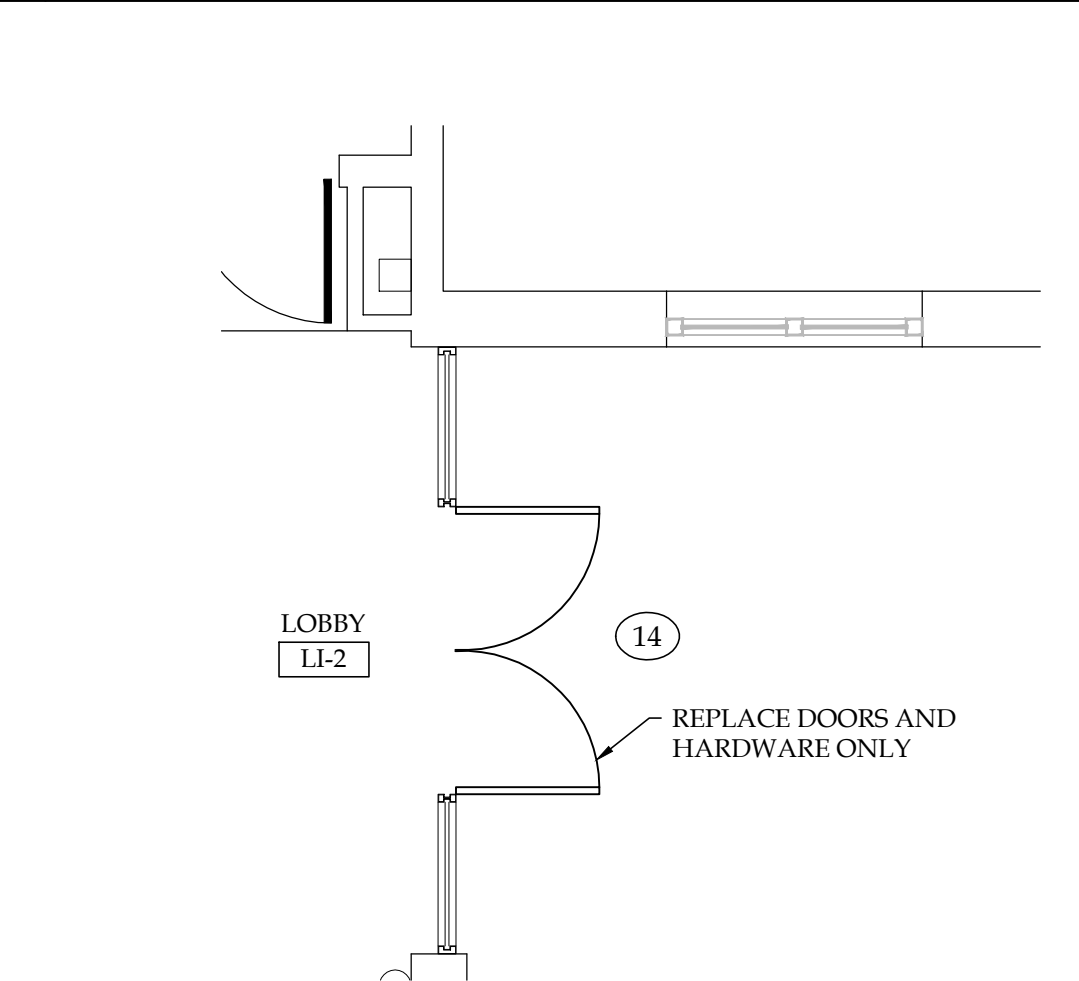
8 THRESHOLD DETAIL T-1
3/4" = 1'-0"

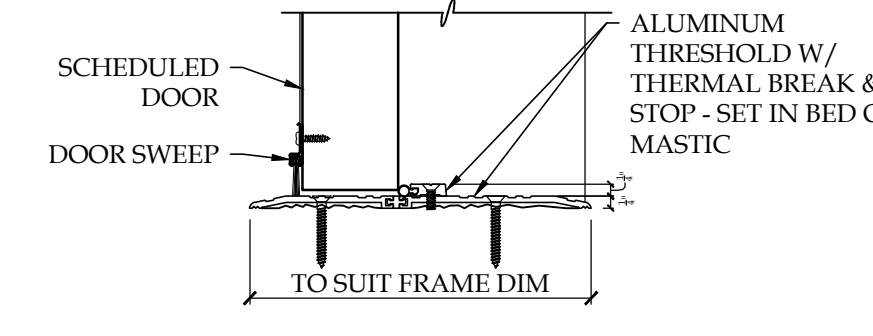


9 CONCRETE SILL DETAIL
3/4" = 1'-0"

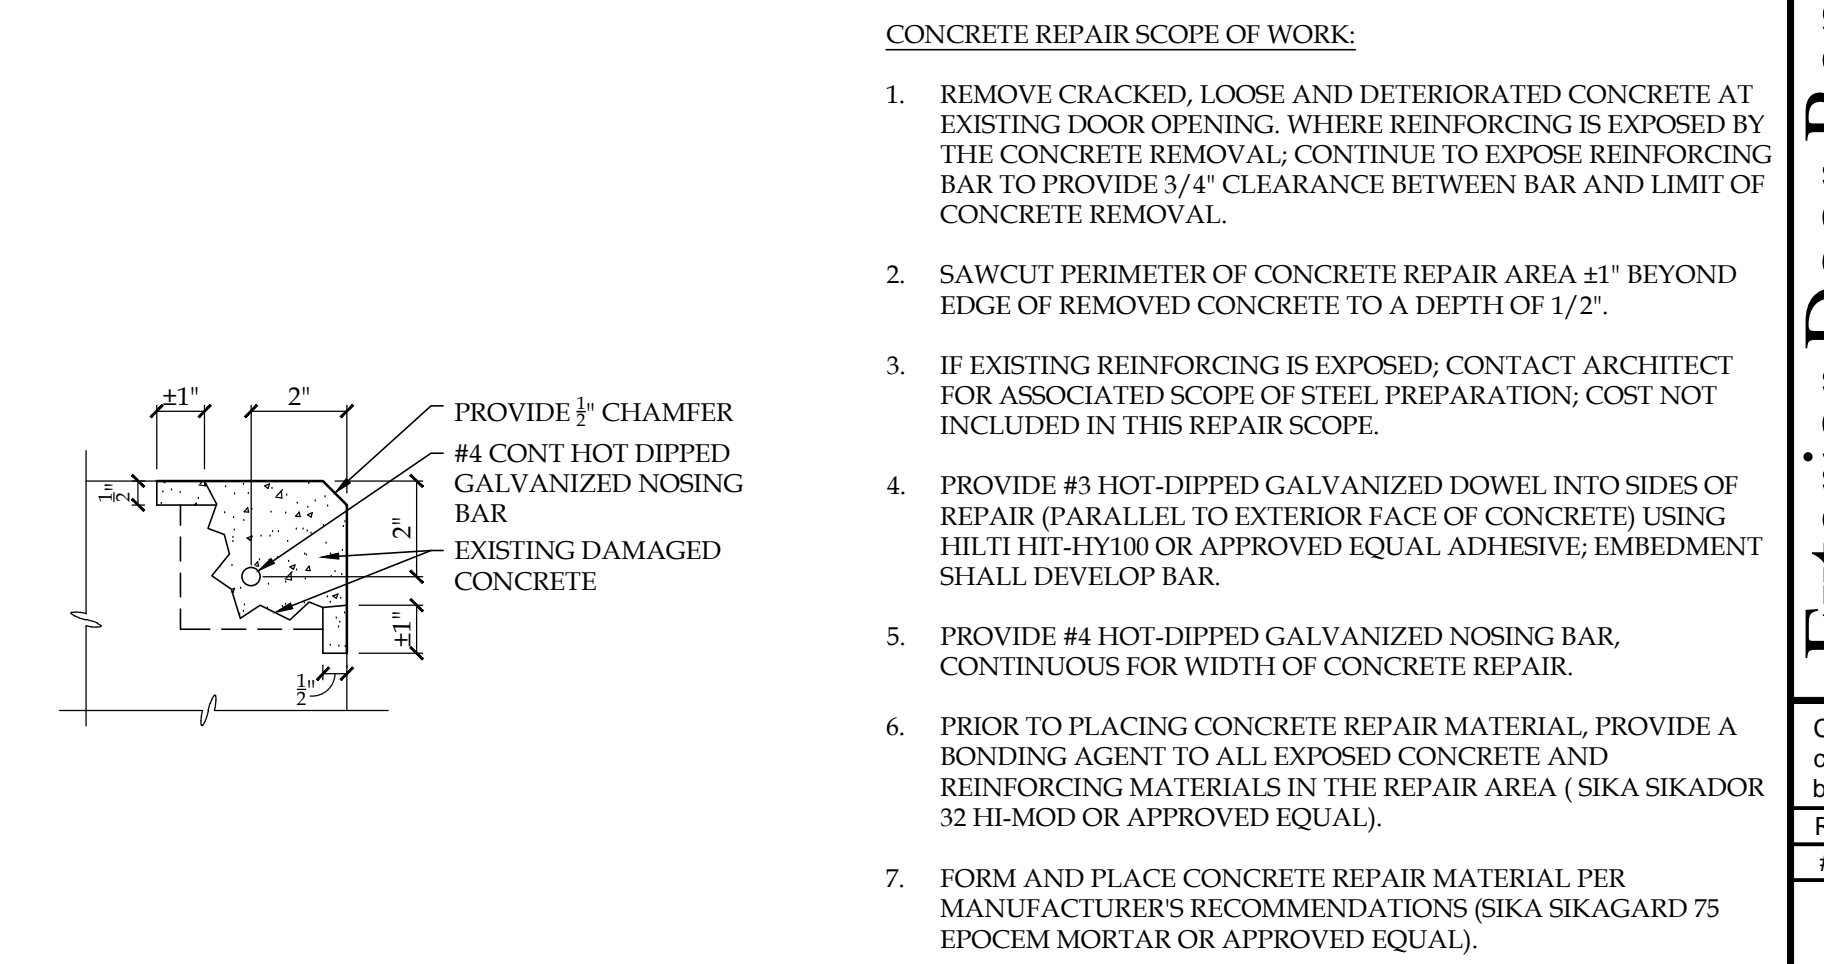


1 PARTIAL FLOOR PLAN @ DOOR #7
1/4" = 1'-0"

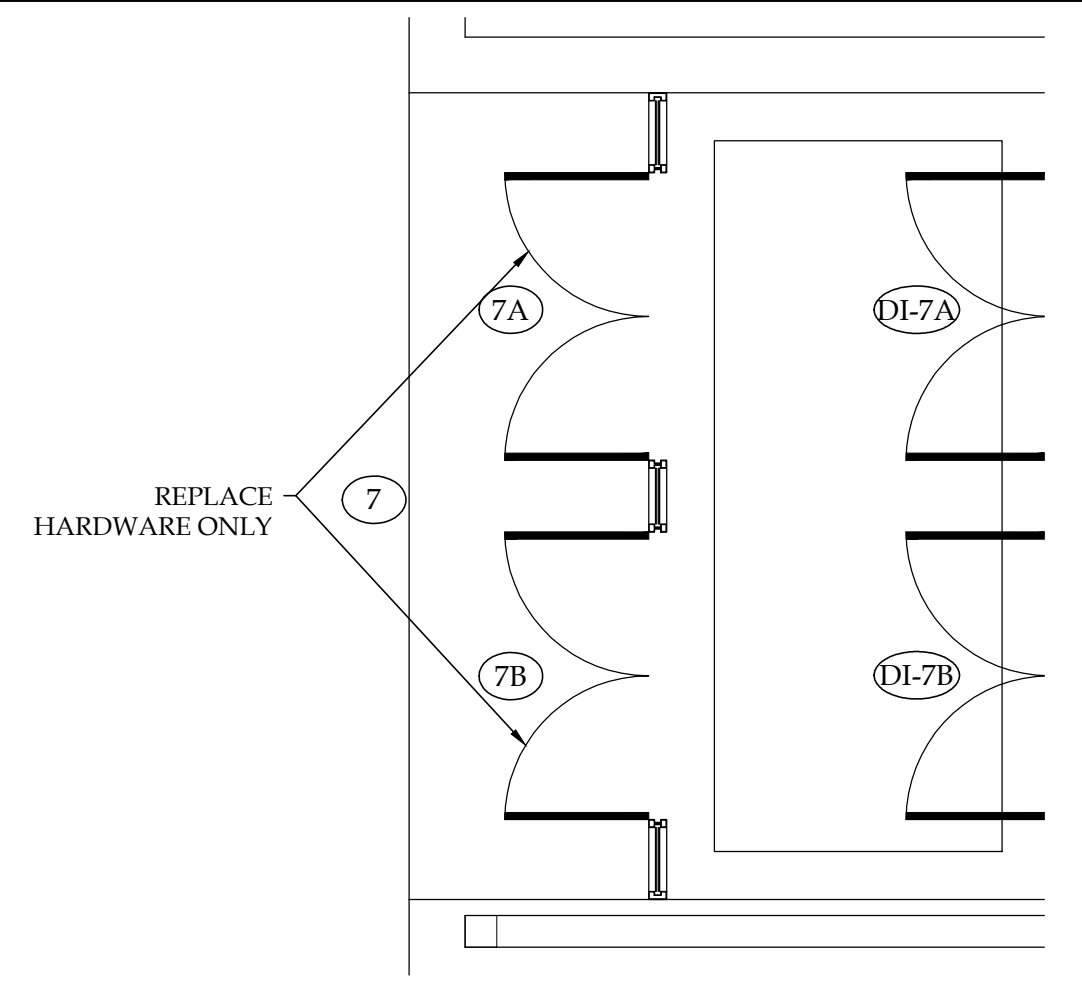


2 PARTIAL FLOOR PLAN @ DOOR #14
1/4" = 1'-0"

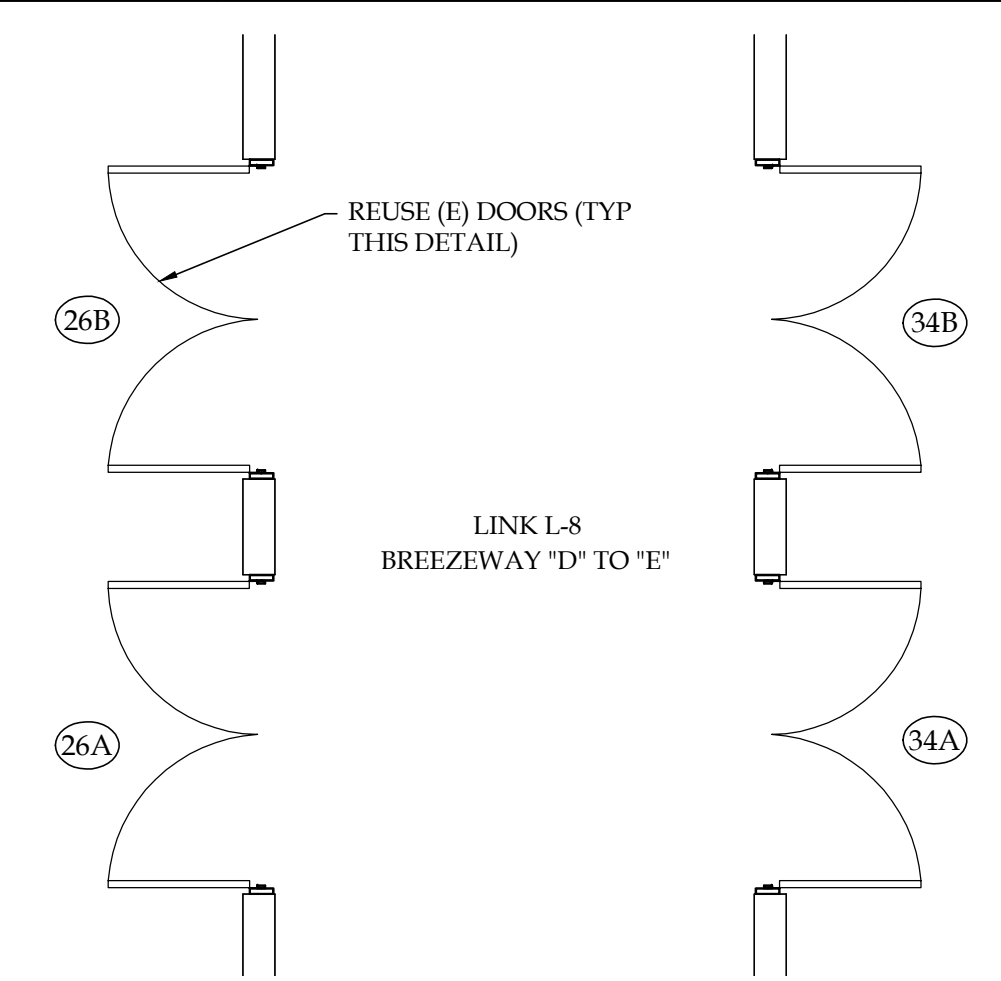

3 PARTIAL FLOOR PLAN @ DOORS #26 & 34
1/4" = 1'-0"

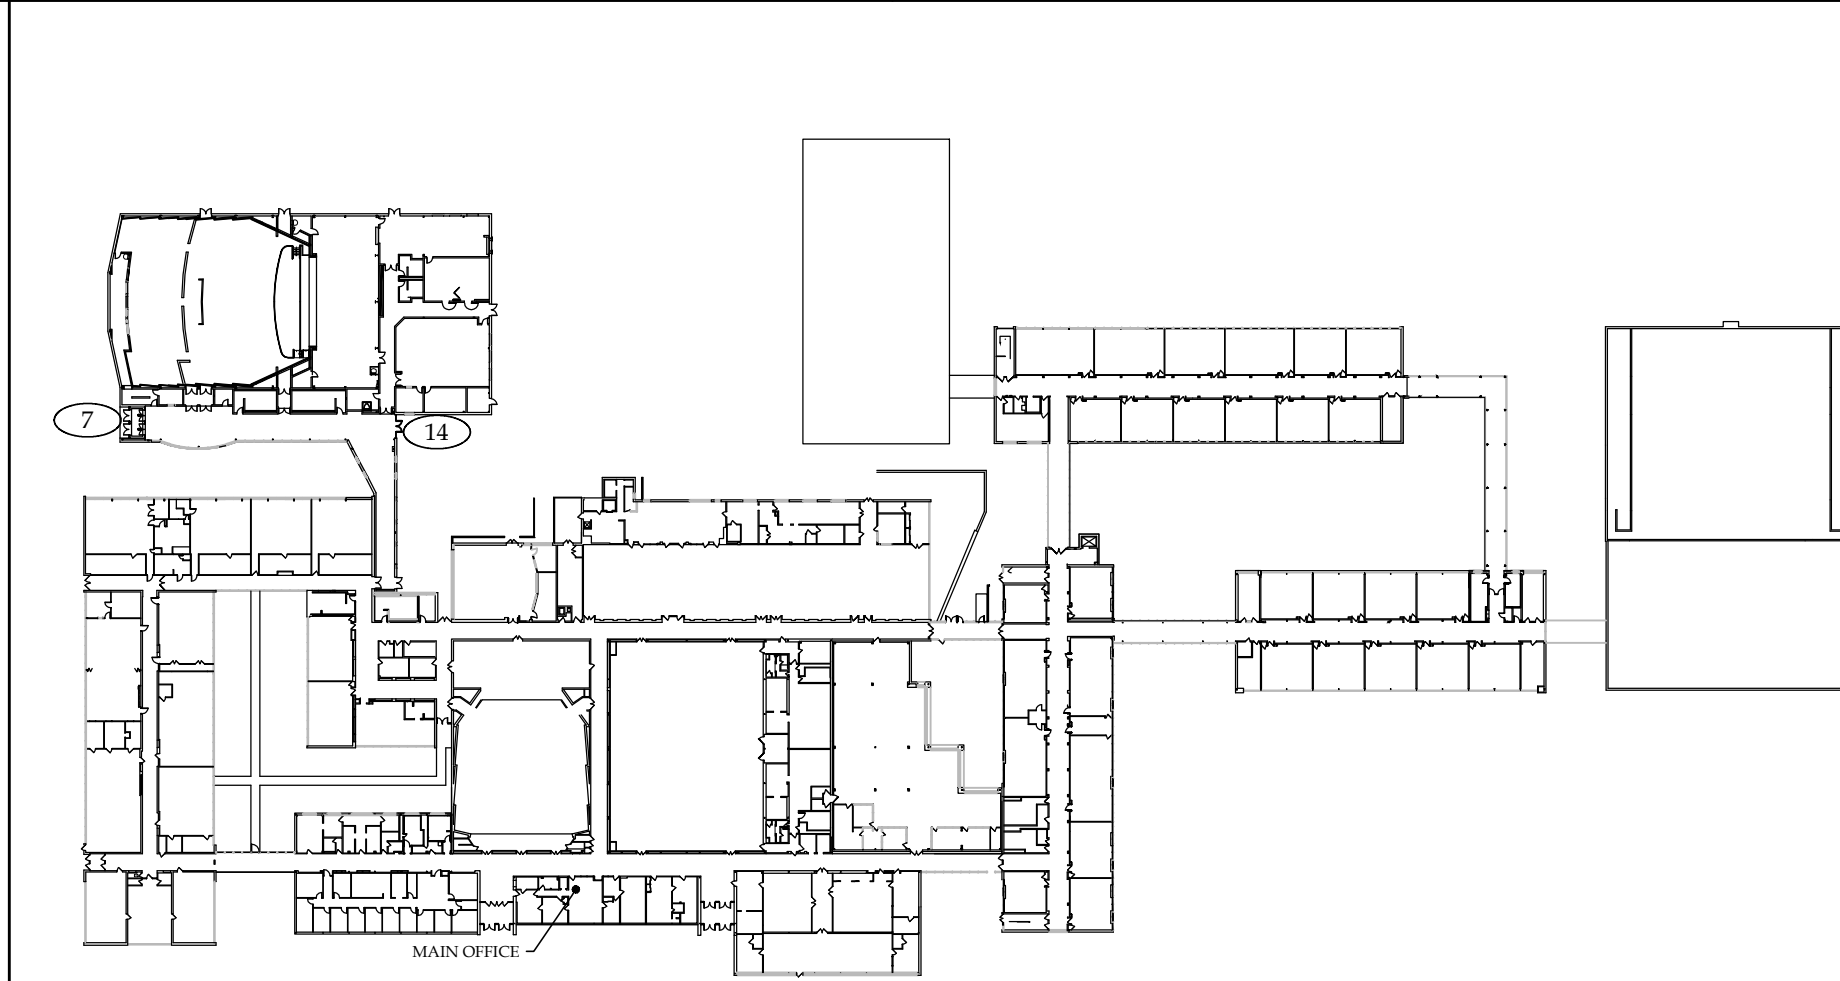

KEY PLAN - FIRST FLOOR LEVEL

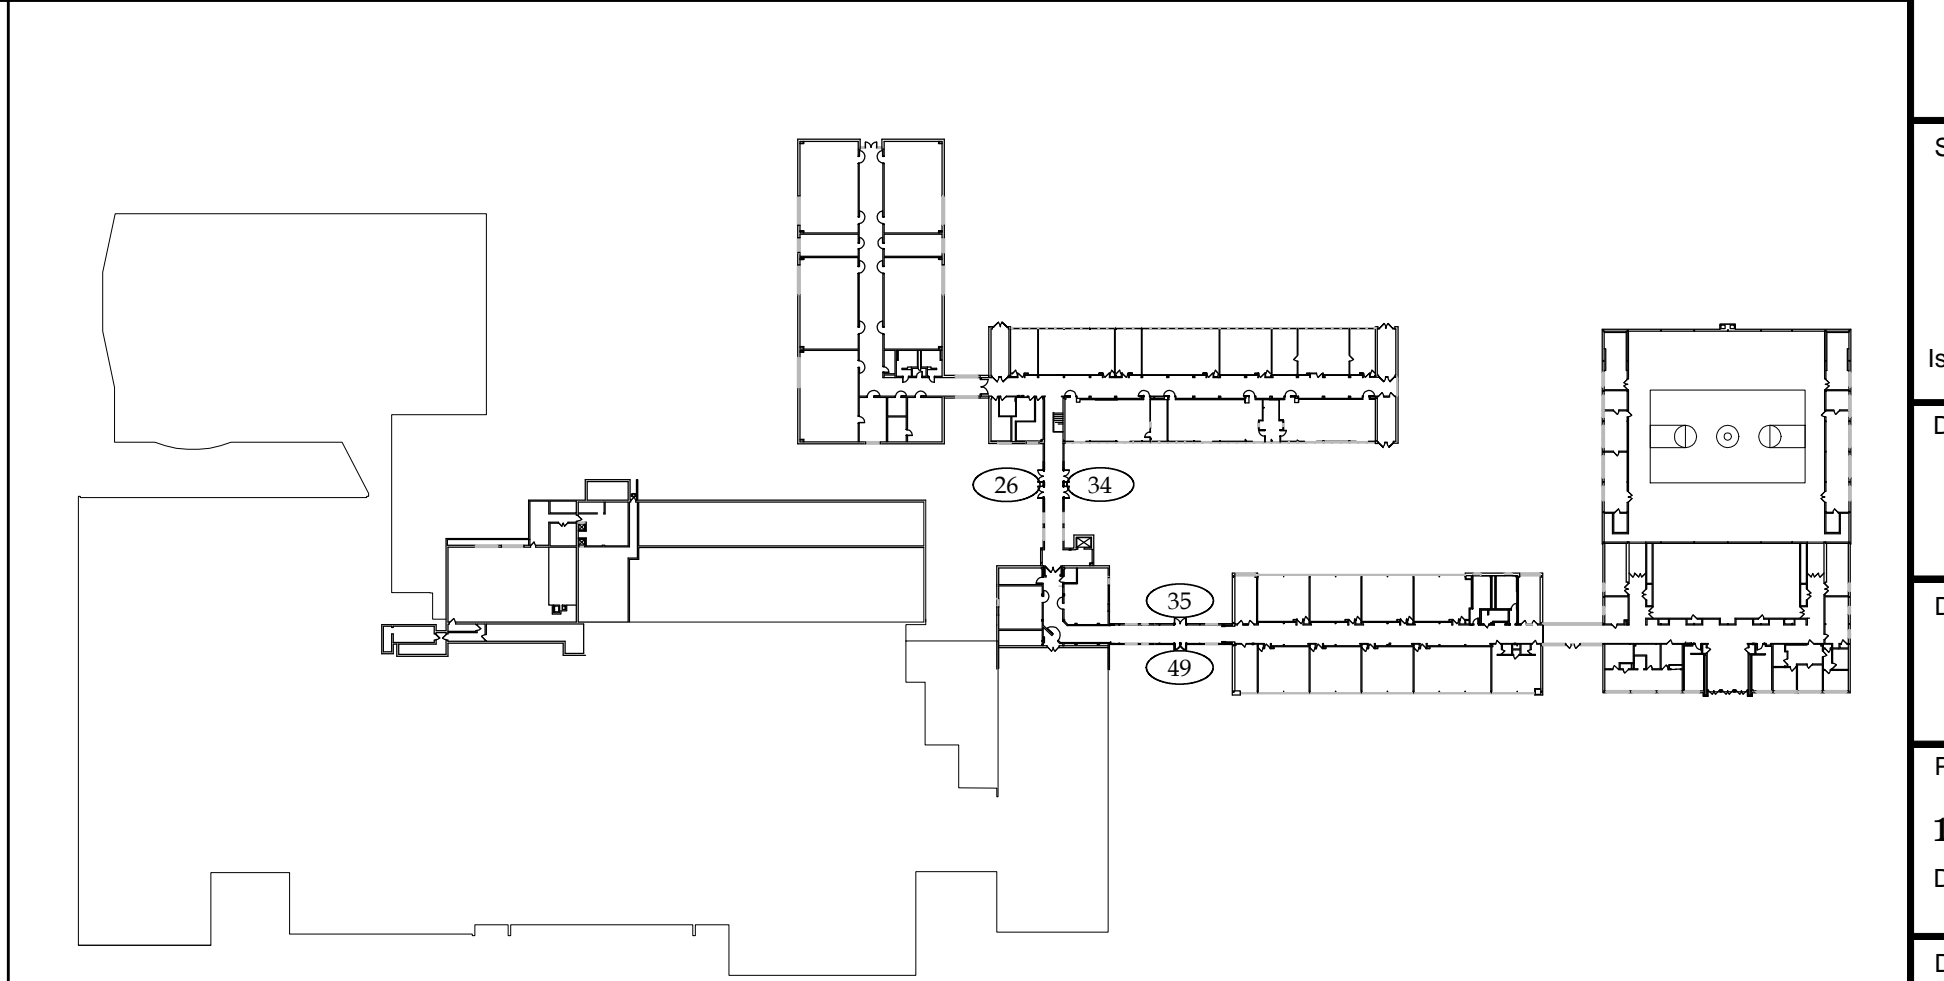

KEY PLAN - GROUND LEVEL

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Architecture/Engineering
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P: 856.795.1180
F: 856.354.6367
W: www.becica.com

Signature/Date
STEVEN A. BECICA, R.A., N.J. 21A010137600

Exterior Door Replacement & Related Work at the
Cherry Hill High School West
2101 Chapel Ave., Cherry Hill, N.J. 08002
Lot: 5 Block: 60/80
Cherry Hill Board of Education
PO Box 5015, 45 Randolph Terrace, Cherry Hill, New Jersey 08034

Contractor shall check and verify all conditions and dimensions at the site before proceeding with this work.

#	Date	Description

Set Issue:
Issued for Bidding
Issue Date: April 5, 2019
Drawing Title:
**Plans, Details
Notes & Schedules**
Drawn by: _____ Checked by: _____
DB
Project Number:
19CHS-18055
DOE State Plan Number #:
Drawing Number:
A-1.1