



# DELAWARE RIVER AND BAY AUTHORITY CAPE MAY - LEWES FERRY

CAPE MAY KITCHEN
CAPE MAY TERMINAL
NEW JERSEY

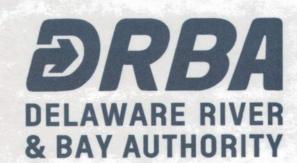

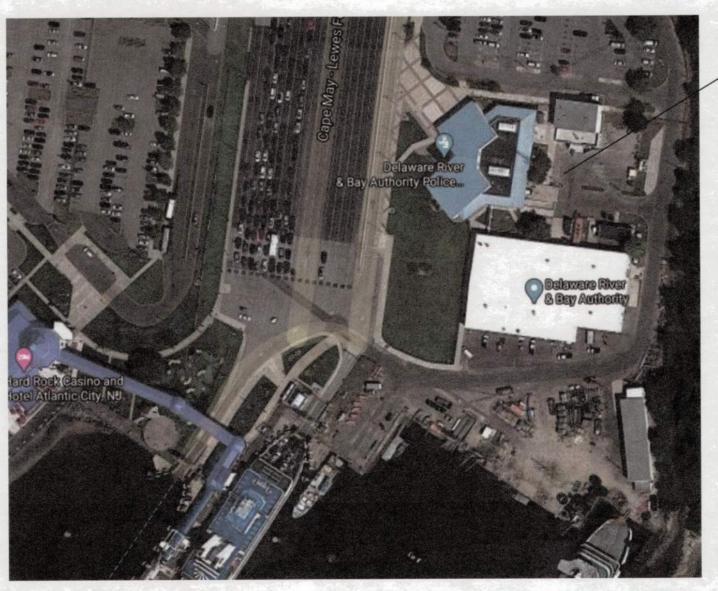


1 SITE LOCATION PLAN
G-000 SCALE: NTS



DRBA CAPE MAY-LEWES

FERRY TERMINAL

KITCHEN

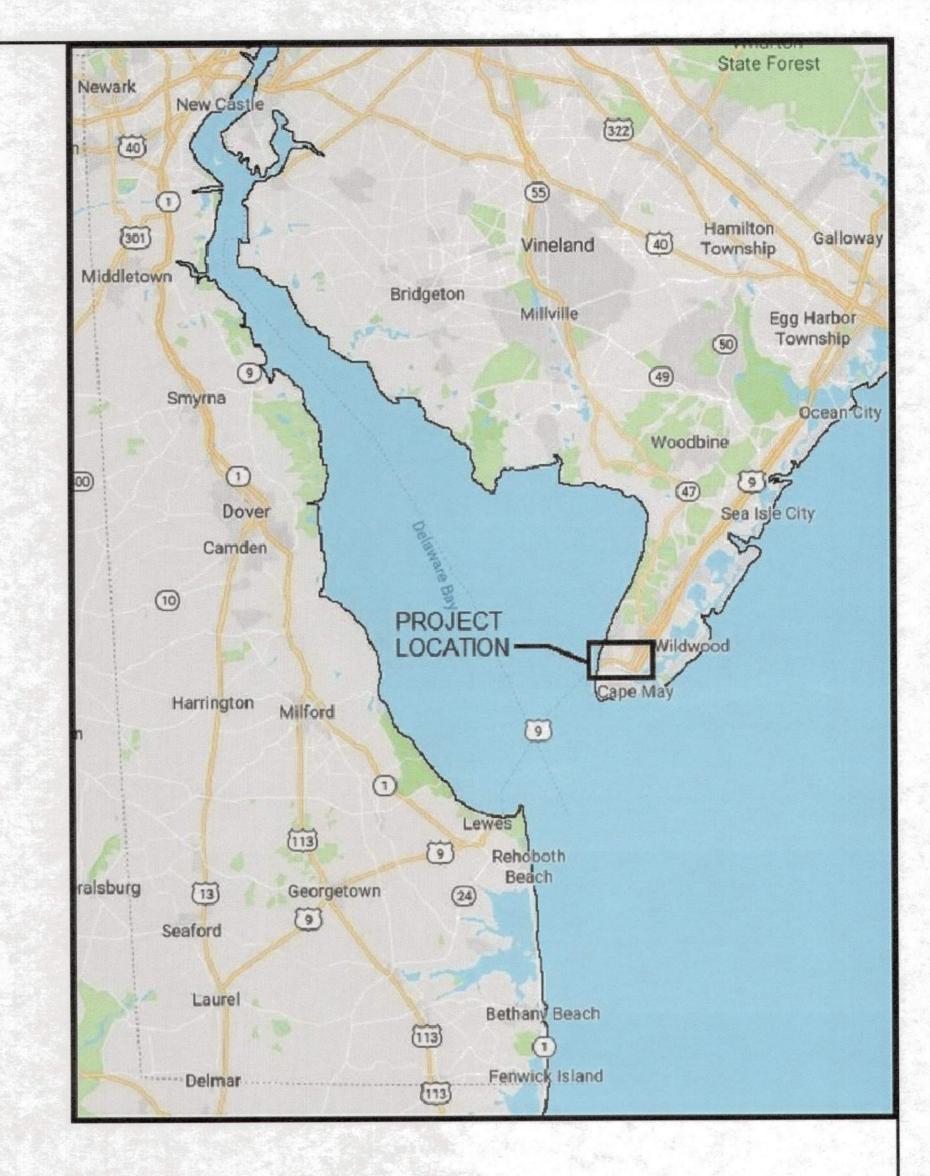

# INDEX OF SHEETS

- 1 C100 COVER SHEET
- 2 C101 EXISTING CONDITIONS AND DEMOLITION PLAN
- 3 C102 CONSTRUCTION PLAN
- 4 C103 CONSTRUCTION DETAILS
- 5 C104 KITCHEN CONTAINER PLAN
- 6 E100 ELECTRICAL COVER SHEET
- 7 E101 ELECTRICAL SITE PLAN AND DETAILS

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DATE

APPROVED BY

ISSUED FOR BIDDING DATE

REVISION


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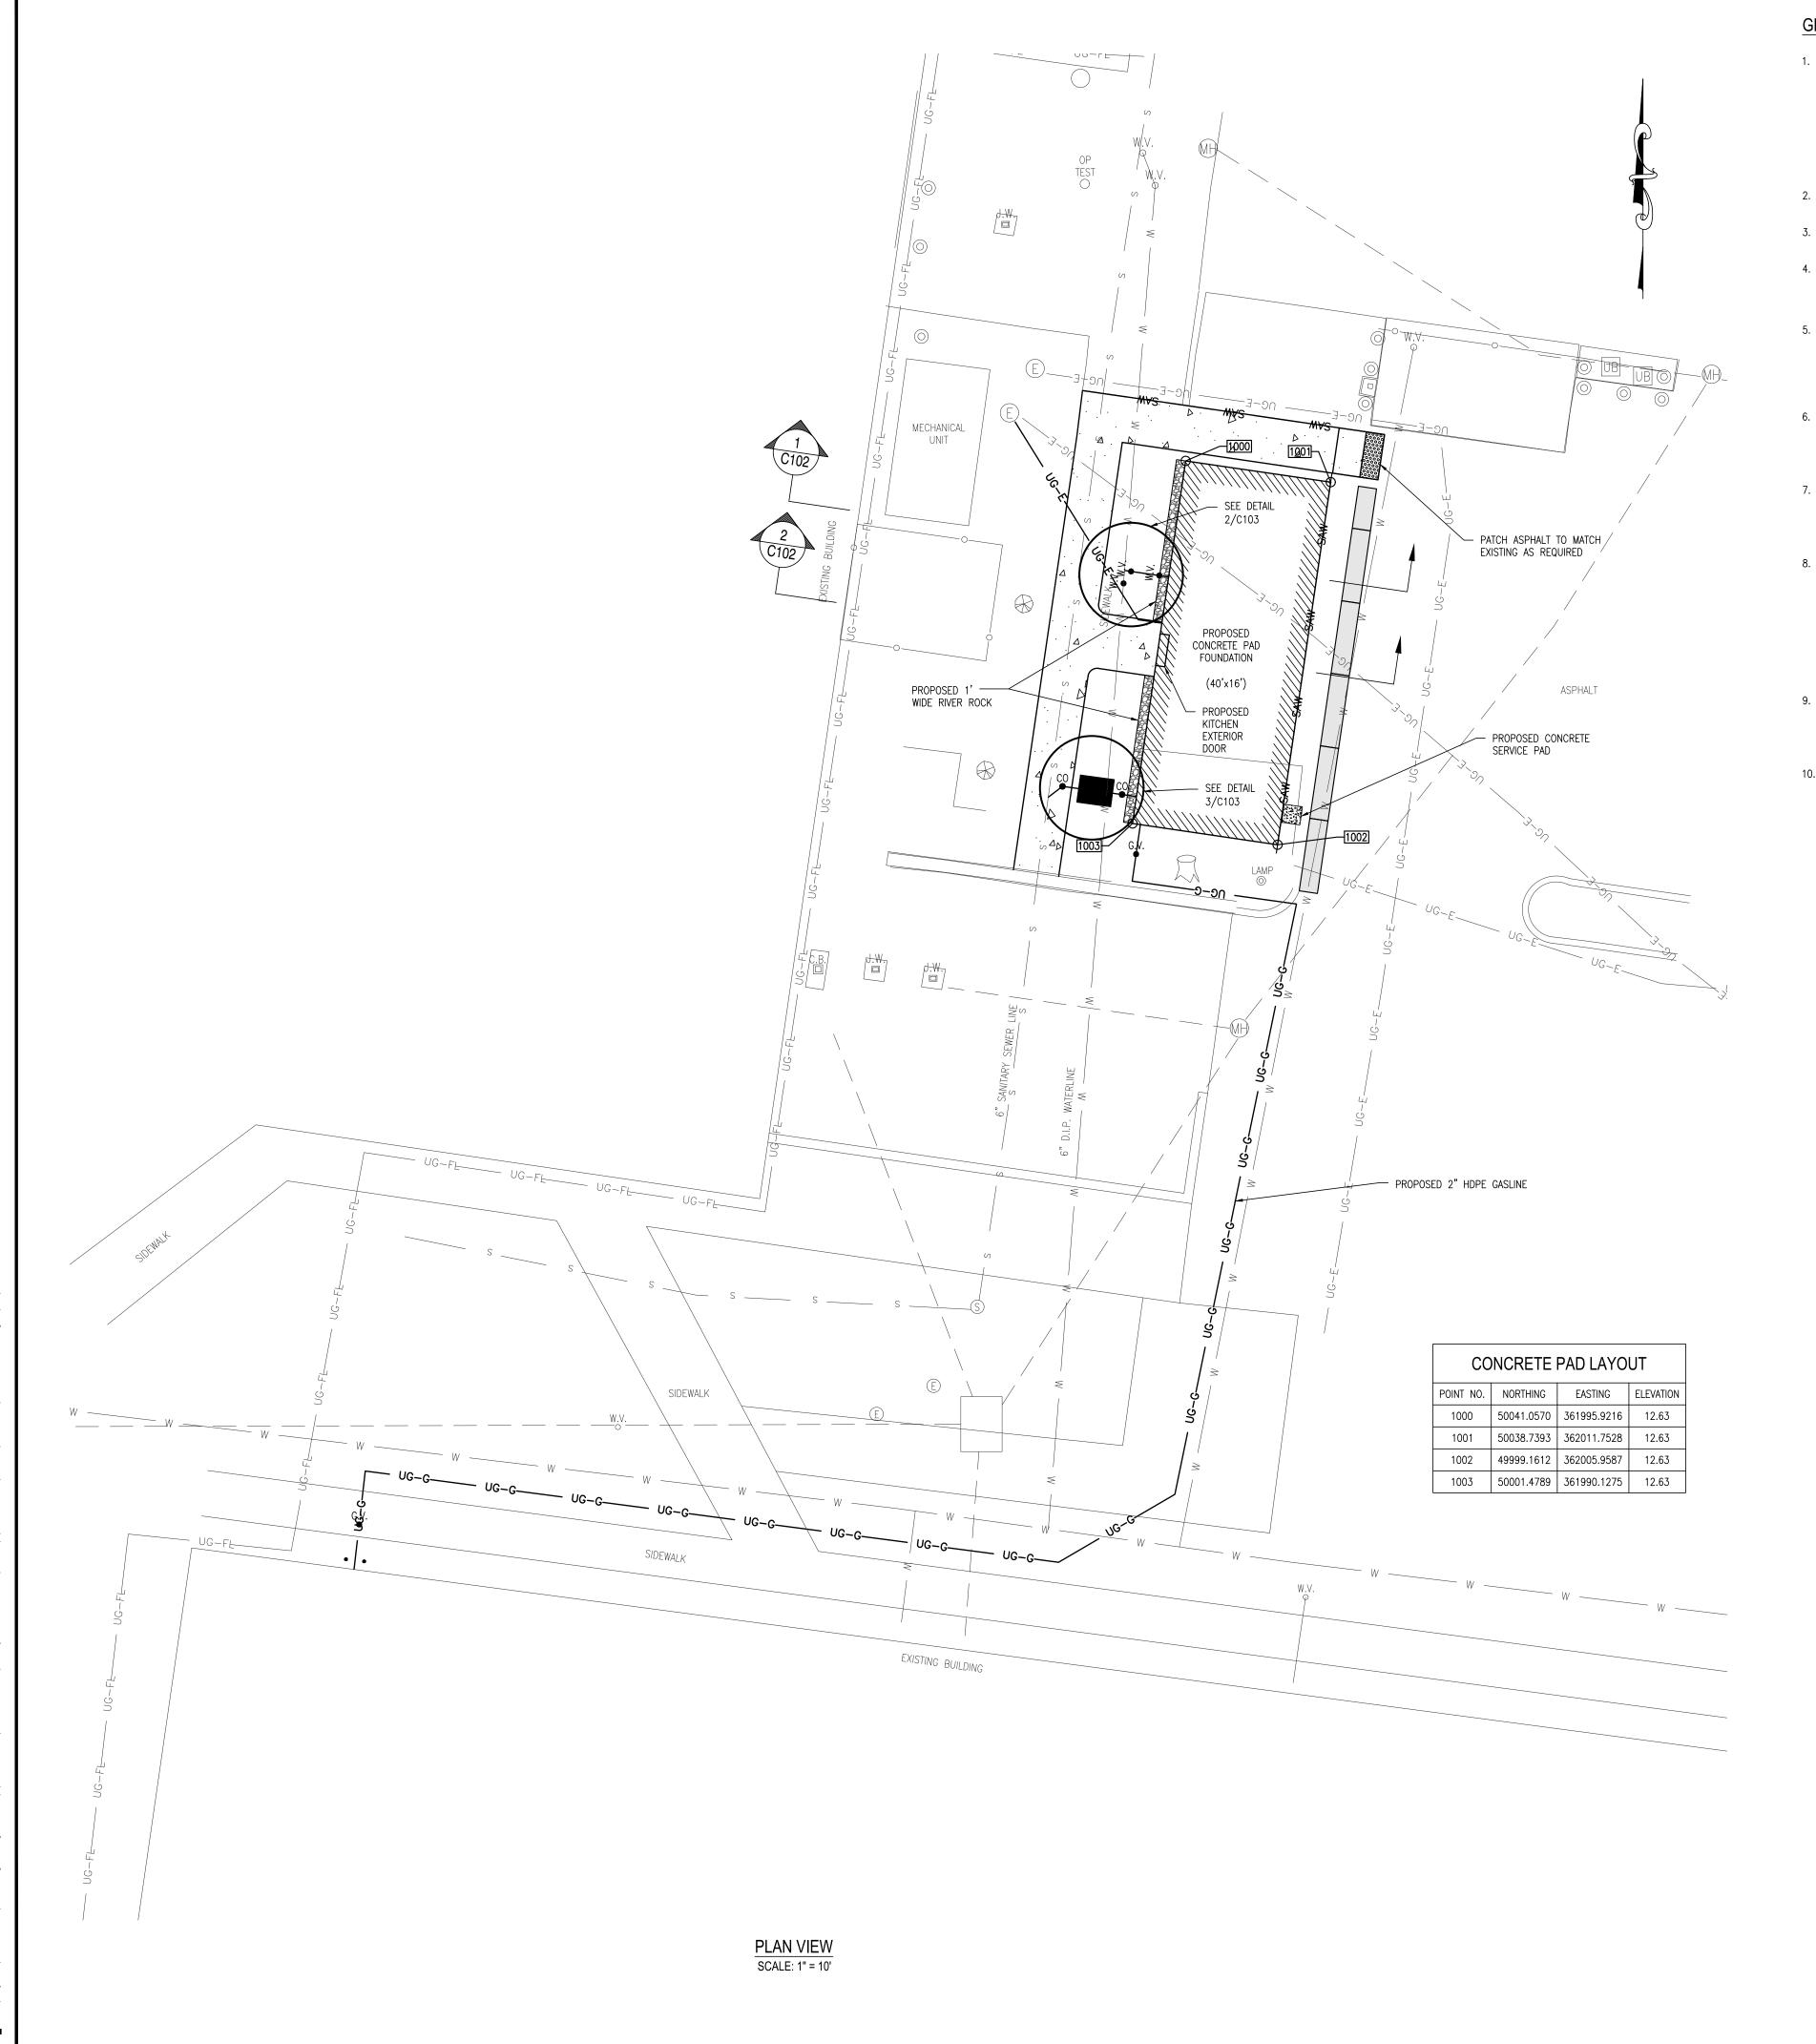
COVER SHEET

C100

DATE: OCTOBER 2020 SCALE: AS NOTED SHEET NO. 1

RECOMMENDED



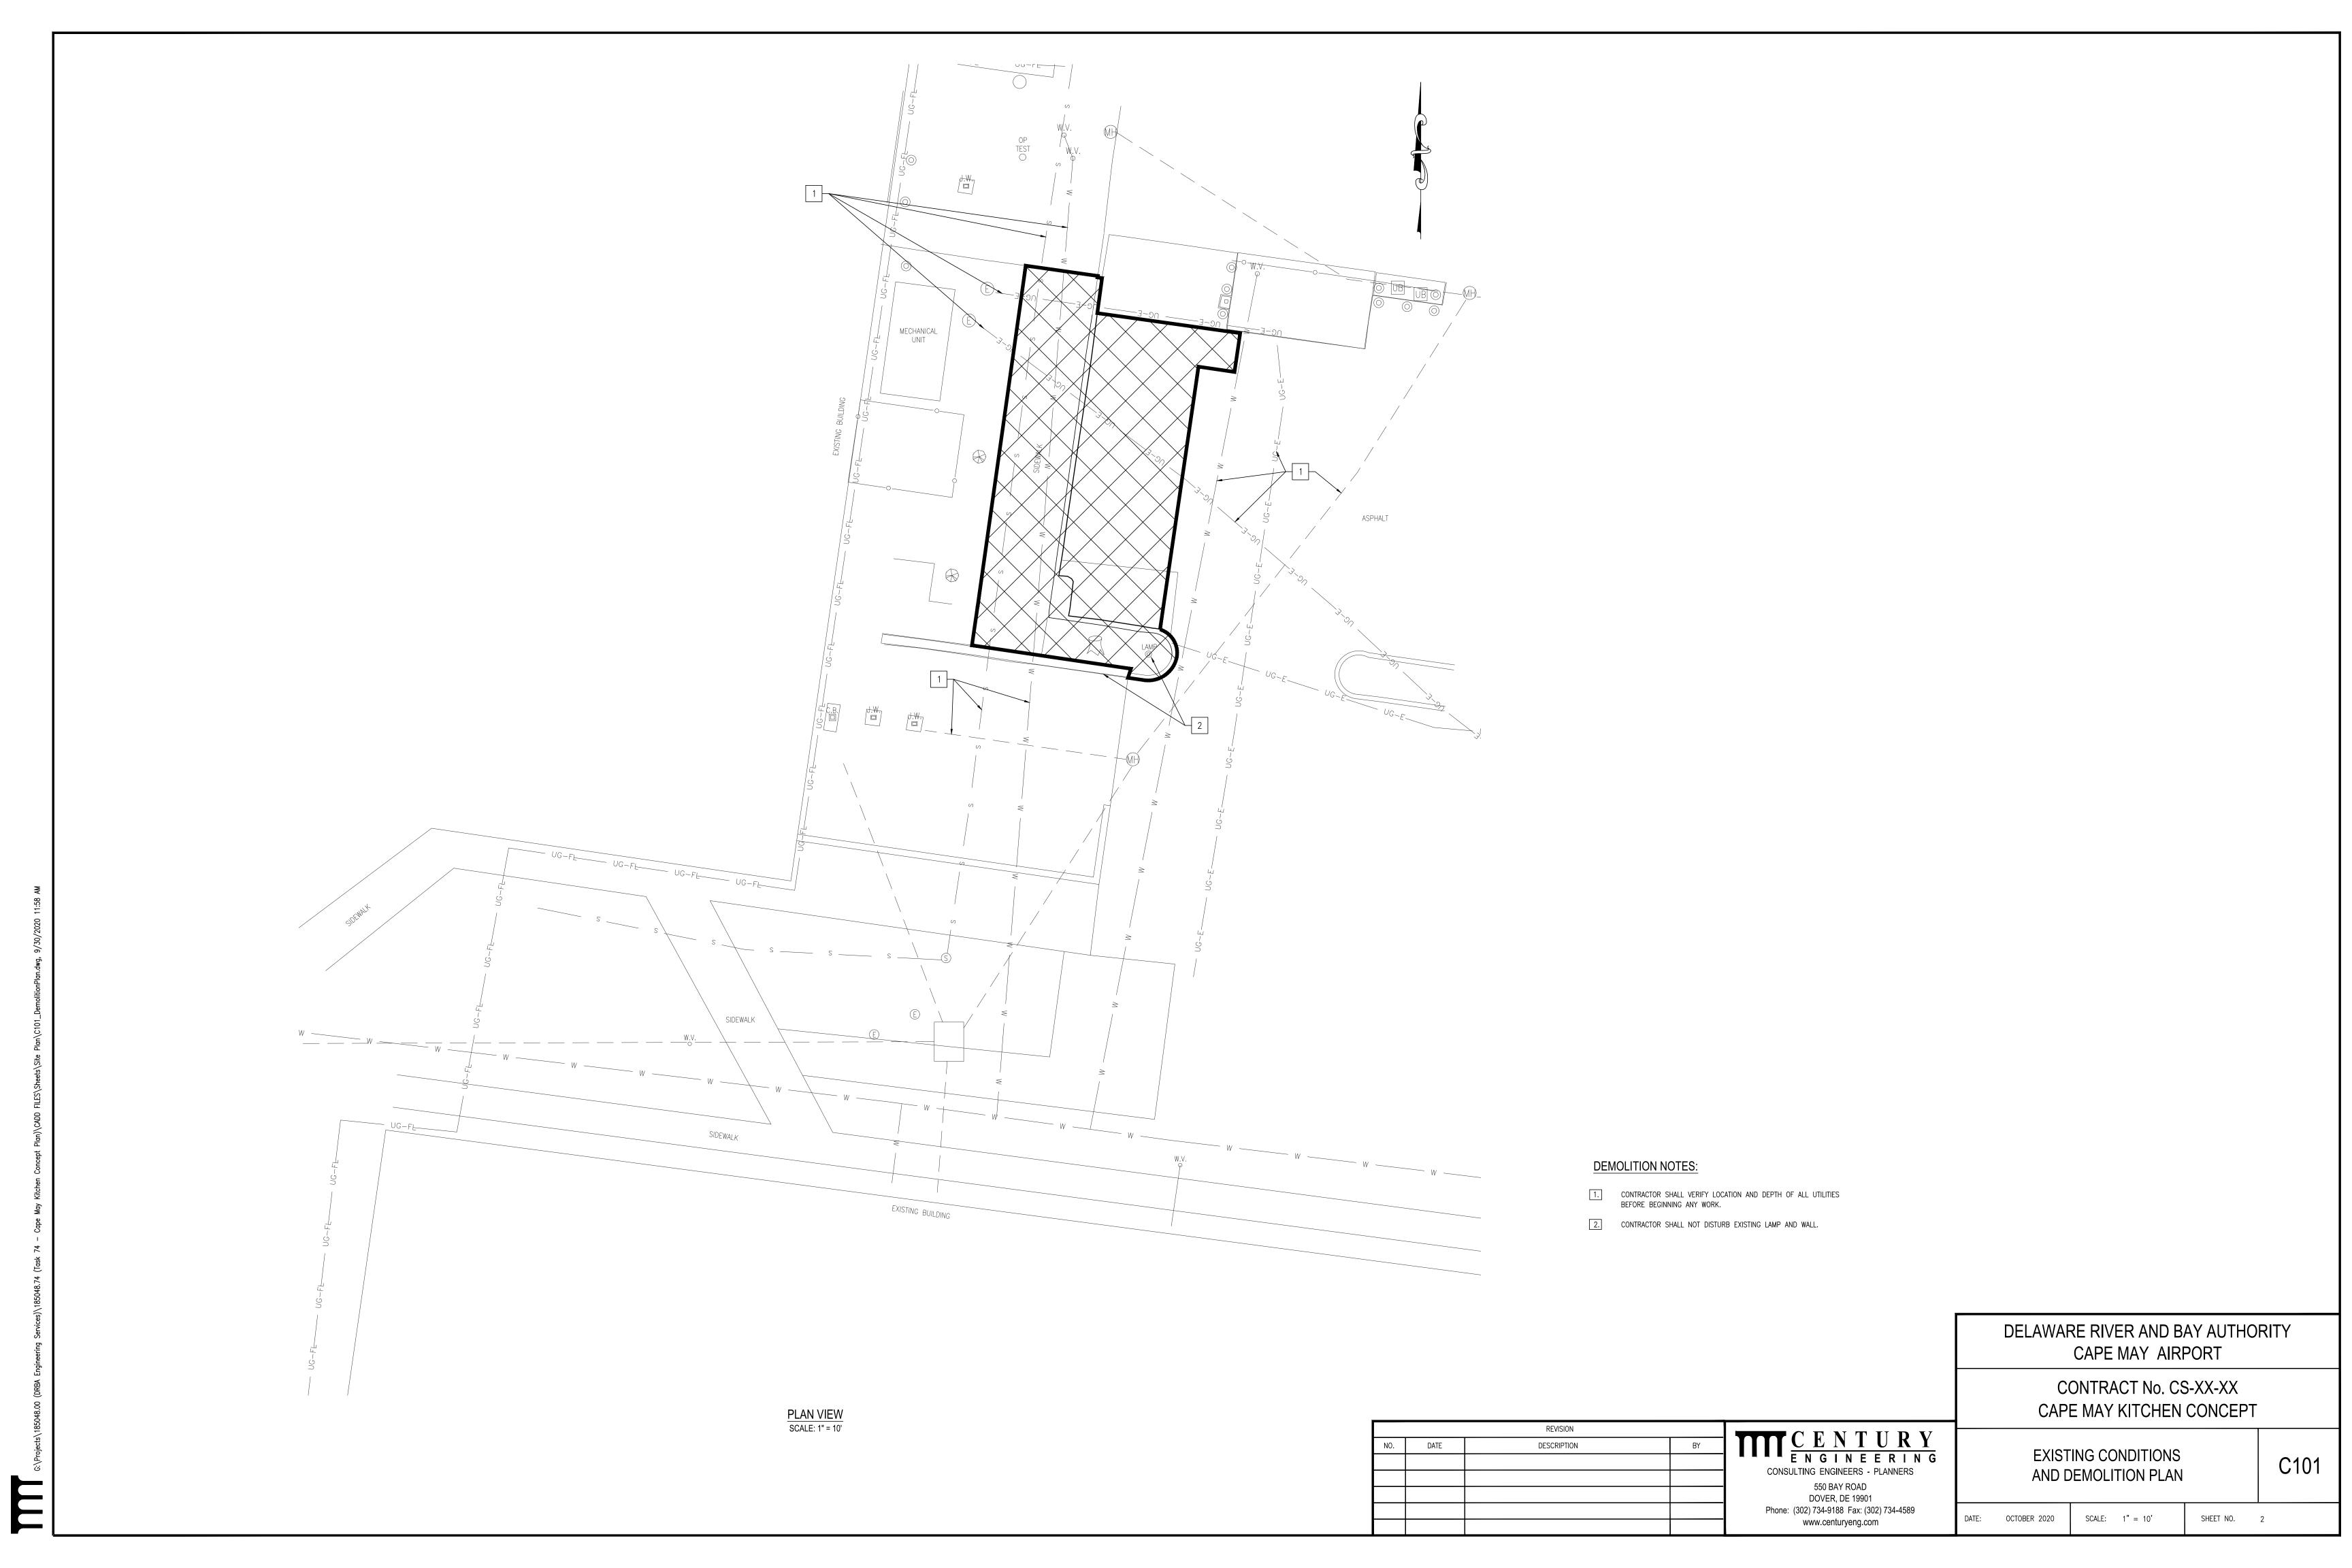

#### **GENERAL NOTES**

- INFORMATION ON THE DRAWINGS PERTAINING TO EXISTING CONDITIONS HAS BEEN OBTAINED FROM FIELD OBSERVATIONS AND MAY NOT INDICATE ACTUAL EXISTING CONDITIONS IN DETAIL OR DIMENSION. THE CONTRACTOR IS RESPONSIBLE FOR DETERMINING THE ACTUAL EXISTING CONDITIONS PRIOR TO PERFORMANCE OF ANY WORK. SHOULD CONDITIONS BE DISCOVERED THAT PREVENT EXECUTION OF ANY OF THE WORK AS INDICATED, THE CONTRACTOR MUST IMMEDIATELY NOTIFY THE ENGINEER AND DRBA PROJECT MANAGER IN WRITING AND AWAIT DIRECTION BEFORE PROCEEDING WITH THE WORK.
- 2. ALL WORK SHALL BE PERFORMED IN ACCORDANCE WITH THE DRBA, FEDERAL, STATE AND LOCAL REQUIREMENTS.

TO FACILITATE DRBA COORDINATION.

- 3. FIELD VERIFY ALL EXISTING UTILITY CONDITIONS AND LOCATIONS
- PRIOR TO COMMENCEMENT OF WORK. 4. CONTRACTOR SHALL COORDINATE ALL UTILITY SHUTDOWNS WITH DRBA PROJECT MANAGER AND FACILITY MAINTENANCE

PERSONNEL. A MINIMUM OF ONE WEEK NOTICE IS REQUIRED

- 5. THE CONTRACTOR IS RESPONSIBLE FOR ALL SITE SAFETY DURING THIS PROJECT. ALL CONSTRUCTION, INCLUDING EXCAVATION, MUST BE COMPLETED IN ACCORDANCE WITH THE RULE AND REGULATIONS OF THE OCCUPATIONAL SAFETY AND HEALTH ACT, CFR 1926.652(B)(2), AND ALL FEDERAL, STATE AND LOCAL REQUIREMENTS.
- 6. THE CONTRACTOR SHALL VERIFY AND COORDINATE ALL UTILITY AND COMMUNICATION FACILITY CONNECTION LOCATIONS WITH THE PROPOSED KITCHEN FACILITY PLAN. THE LOCATION OF THE UTILITY CONNECTIONS TO THE KITCHEN FACILITY MAY BE DIFFERENT THAN SHOWN ON THIS PLAN.
- 7. THE CONTRACTOR SHALL RESTORE ALL AREAS AFFECTED BY THE CONSTRUCTION SHOWN HEREON AS REQUIRED BY THE PROJECT DOCUMENTS, TO A CONDITION COMPARABLE TO THAT EXISTING PRIOR TO CONSTRUCTION, AND TO THE SATISFACTION OF DRBA.
- 8. BEFORE EXCAVATION IS STARTED, THE CONTRACTOR SHALL CONTACT MISS UTILITY 1-800-282-8555 TO VERIFY THE LOCATION OF ALL UNDERGROUND UTILITIES TWO (2) CONSECUTIVE WORKING DAYS PRIOR TO ANY EXCAVATION. ALL EXISTING UTILITIES SHALL BE PROTECTED AND TEMPORARILY SUPPORTED OR RELOCATED AS NECESSARY TO COMPLETE THE WORK IN ACCORDANCE WITH THE PERTINENT DRBA/UTILITY REQUIREMENTS. ANY UTILITIES DAMAGED BY THE CONTRACTOR SHALL BE PROMPTLY AND FULLY RESTORED TO THE SATISFACTION OF DRBA.
- 9. THE CONTRACTOR IS SOLELY RESPONSIBLE TO OBTAINING OFF-SITE SPOIL AREAS FOR LEGAL DISPOSAL OF EXCESS MATERIAL NOT ACCEPTED DRBA OR UNSUITABLE MATERIALS AS NECESSARY IN ACCORDANCE WITH ALL FEDERAL, STATE AND LOCAL REQUIREMENTS.
- 10. SITE MATERIAL LAY DOWN PLAN MUST BE PROVIDED TO DRBA PROJECT MANAGER FOR APPROVAL.

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#### MAINTENANCE OF TRAFFIC NOTES

- 1. TRAFFIC CONTROL PLAN WITHIN THE PARKING AREA/CONSTRUCTION SITE IS TO BE PROVIDED TO DRBA PROJECT MANAGER FOR APPROVAL.
- 2. PARKING FOR THE DRBA POLICE STAFF MUST BE AVAILABLE AT ALL TIMES.

### GENERAL CONSTRUCTION NOTES:

CONTRACTOR SHALL VERIFY LOCATION AND DEPTH OF ALL UTILITIES BEFORE BEGINNING ANY WORK.

2. CONTRACTOR SHALL NOT DISTURB EXISTING LAMP AND WALL.

#### GENERAL NOTES: SITE WORK AND UTILITIES

- 1. TRACER WIRE SHALL BE PROVIDED ON ALL UNDERGROUND UTILITIES. SIZE AND COLOR SHALL BE PER UTILITY AUTHORITY DESIGNATION STANDARDS.
- 2. THE CONTRACTOR SHALL BE RESPONSIBLE FOR INSTALLATION OF ALL CONDUIT SHOWN.
- 3. CONTRACTOR SHALL COORDINATE WORK WITH AND BETWEEN ALL TRADES.

#### UTILITY NOTES: WATER

- 1. CONNECTION TO THE EXISTING WATER LINE USING A WET LINE TAP. POWER SEAL TAPPING SLEEVE AND VALVE.
- 2. ALL MATERIALS IN CONTACT WITH POTABLE WATER SHALL COMPLY WITH NSF/ANSI STANDARDS 60 AND 61.
- 3. ALL DOMESTIC WATER SERVICE PIPES SHALL BE 2" SDR9.
- 4. 3' MINIMUM PIPE COVER.


#### UTILITY NOTES: SANITARY SEWER


- 1. CONNECTION TO THE EXISTING SANITARY SEWER USING LATERAL SADDLE CONNECTION. FERNCO TSW-4 FLEXIBLE TAP SADDLE
- 2. 3' MINIMUM PIPE COVER.


#### UTILITY NOTES: NATURAL GAS

- 1. NATURAL GAS CONNECTION SHALL BE MADE USING STEEL PIPE WITH INTEGRAL VALVE.
- 2. DISTRIBUTION LINE TO KITCHEN FACILITY MAY TRANSITION TO
- 3. COORDINATE THIS CONNECTION WITH NATURAL GAS SUPPLIER TO COMPLY WITH ALL MATERIAL TESTING DETAILS/REQUIREMENTS.

# UTILITY NOTES: ELECTRICAL

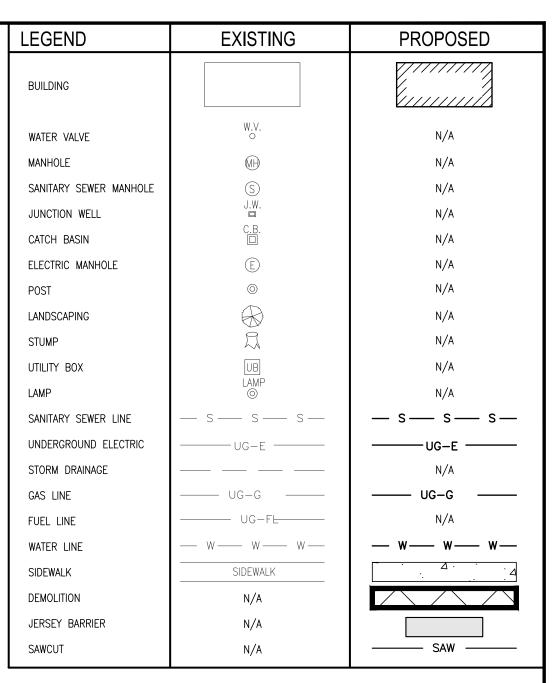

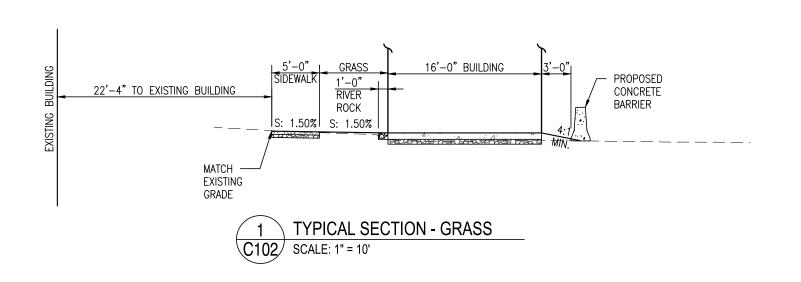

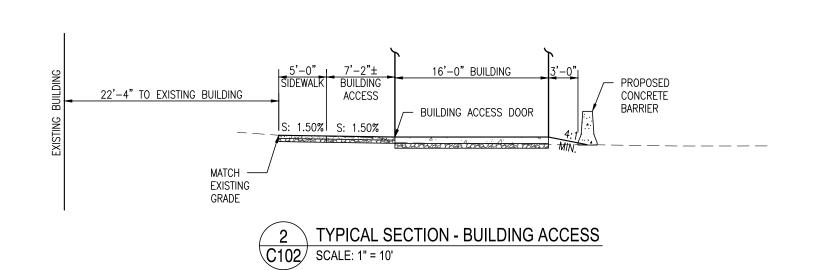

DELAWARE RIVER AND BAY AUTHORITY CAPE MAY AIRPORT

> CONTRACT No. CS-XX-XX CAPE MAY KITCHEN CONCEPT

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	CONS	STRUCTION PLAN		C1
DATE:	OCTOBER 2020	SCALE: 1" = 10'	SHEET NO.	3

NO. DATE DESCRIPTION


2. ALL EARTH SUBGRADE SHALL BE PROOF ROLLED. ANY SOFT AREAS SHALL BE UNDERCUT AND BACKFILLED WITH SELECT CONCRETE

GENERAL CONCRETE PAD NOTES

1. ALL CONCRETE WORK SHALL BE IN ACCORDANCE WITH ACI 301 - "SPECIFICATIONS FOR STRUCTURAL CONCRETE".


1. ALL EXPOSED CONCRETE PAD EDGES SHALL HAVE A 1"

- 2. CONCRETE DESIGN MIXES/STRENGTHS SHALL HAVE A MINIMUM COMPRESSIVE STRENGTH OF F'c = 3,500 PSI, UNLESS STATED OTHERWISE. ALL CONCRETE SHALL CONTAIN A WATER-REDUCING ADMIXTURE. CALCIUM CHLORIDE IS PROHIBITED.
- WELDED WIRE FABRIC SHALL BE SMOOTH OR DEFORMED AND CONFORM TO ASTM A1064 AND BE A MINIMUM WWF6X6-W1.4XW1.4. ALL WELDED WIRE FABRIC SHALL BE SPLICED SO THAT THE OVERLAP OF THE OUTERMOST CROSS WIRES OF EACH ADJOINING SHEET IS NOT LESS THAN THE SPACING OF THE CROSS WIRES PLUS TWO INCHES.
- 4. WELDED WIRE FABRIC SHALL BE INSTALLED AT A DEPTH OF 2/3 THE THICKNESS OF THE CONCRETE SECTION.
- 5. NO CONCRETE SHALL BE PLACED IN WATER OR ON FROZEN SUBGRADE.
- 6. THE REQUIRED AIR CONTENT FOR ALL CONCRETE SHALL BE 3%
- 7. SPACING OF SIDEWALK EXPANSION JOINTS SHALL BE 15'. SIDEWALK SHALL HAVE TOOL JOINTS EVERY 5'.

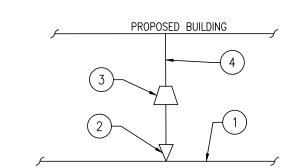


- (1) 6" DUCTILE IRON PIPE
- 2 2" SERVICE TAP
- 3 CURB STOP
- 4) 2" DOMESTIC SERVICE TO KITCHEN



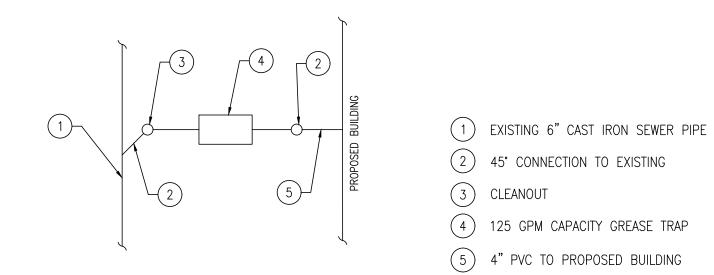

3 SANITARY SEWER CONNECTION LAYOUT C103 SCALE: NOT TO SCALE

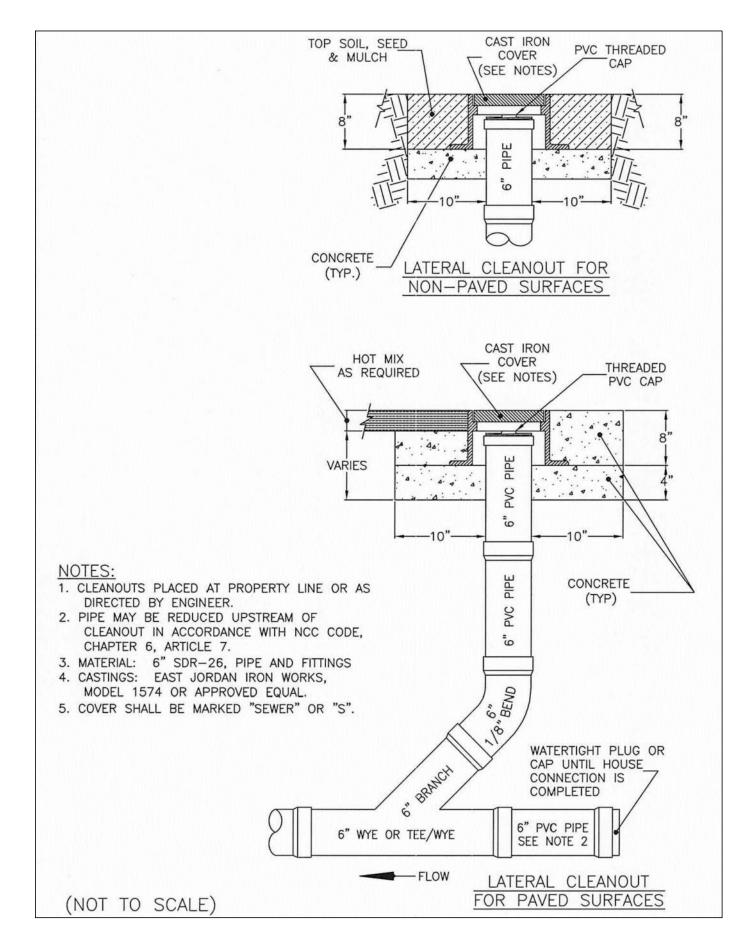

- WIRE MESH REINFORCING

— 8" CONCRETE

— UNDISTURBED EARTH OR BORROW TYPE F


COMPACTED TO 95% OF MODIFIED PROCTOR

PLACED IN MAXIMUM 8" LIFTS AND

1 CONCRETE PAD SECTION

C103 SCALE: NOT TO SCALE



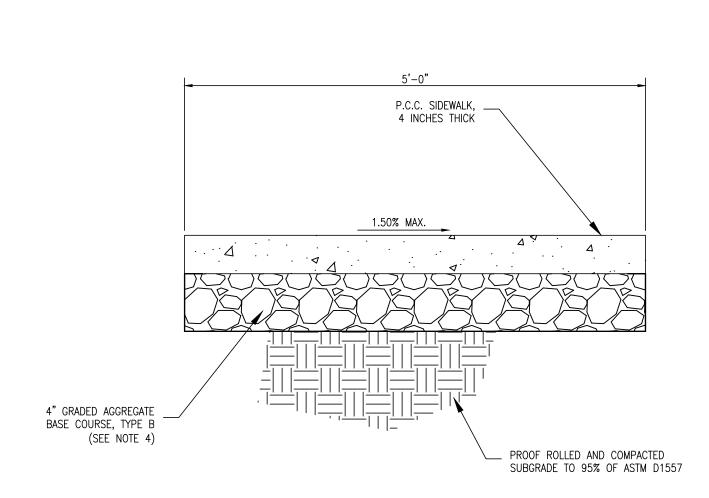

- MARK IN 5' SQUARES, USE CORK EXPANSION JOINTS AT INTERVALS NOT GREATER THAN 15'.
- 2. CONCRETE SIDEWALKS SHALL BE CONSTRUCTED AS PER DELDOT SPECIFICATIONS.
- 3. CROSS SLOPE OF SIDEWALK SHALL BE 1% MIN., 1.5% MAX. LONGITUDINAL SLOPE AS SHOWN ON PLANS.

`\ SIDEWALK DETAIL C103 SCALE: NOT TO SCALE

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CAPE MAY AIRPORT CONTRACT No. CS-XX-XX CAPE MAY KITCHEN CONCEPT

SCALE: AS NOTED

DATE: OCTOBER 2020

DELAWARE RIVER AND BAY AUTHORITY

CONSTRUCTION DETAILS

SHEET NO. 4

## **GENERAL NOTES - ELECTRICAL WORK**

- DRAWINGS SHALL NOT BE SCALED.
- 2. THE ELECTRICAL CONTRACTOR SHALL COORDINATE HIS WORK WITH THAT OF ALL OTHER TRADES. ALL OTHER DRAWINGS AND SPECIFICATIONS SHALL BE CONSULTED AND COORDINATED WITH PRIOR TO ROUGH-IN.
- 3. WHEREVER POSSIBLE, THE CONTRACTOR SHALL OBTAIN ACTUAL ROUGH-IN DRAWINGS FOR THE ACTUAL ITEM OF EQUIPMENT TO BE INSTALLED PRIOR TO ROUGH-IN. THIS SHALL APPLY TO ALL EQUIPMENT, WHETHER IT IS TO BE INSTALLED BY THE CONTRACTOR OR BY THE OWNER.
- 4. ANY AND ALL CUTTING AND PATCHING OF SURFACES SHALL BE PROVIDED BY THE CONTRACTOR.
- 5. WHERE NEW LOADS ARE ADDED AND EXISTING LOADS REMOVED, PROVIDE UPDATED TYPED CIRCUIT DIRECTORIES FOR ALL PANELBOARDS TO INDICATE TYPE OF LOAD SERVED AND AREA SERVED (E.G. RECEPTACLES-OFFICE 201).
- 6. ELECTRICAL PENETRATIONS FOR BOXES, DEVICES, EQUIPMENT, WIRING AND RACEWAYS IN FIRE-RESISTANCE-RATED CONSTRUCTION SHALL COMPLY WITH ALL REQUIREMENTS OF THE INTERNATIONAL BUILDING CODE, "PENETRATIONS" SECTION. PROVIDE FIRE SEALANT FOR PENETRATIONS THROUGH FIRE RATED FLOORS AND WALLS TO MAINTAIN THE APPLICABLE FIRE RATING.

# ELECTRICAL ABBREVIATIONS (NOT ALL USED)

LOW VOLTAGE

MISCELLANEOUS

MAIN LUGS ONLY MOTOR STARTER

NOT TO SCALE

ON CENTER OVERHEAD

OTA OVER THE AIR

MAIN CIRCUIT BREAKER

NATIONAL ELECTRICAL CODE

MCB

MISC

MLO

NTS

OC

AMPERE(S) PHASE ADA AMERICAN DISABILITY ACT POLE ABOVE FINISHED FLOOR PANELBOARD RUNNING LOAD AMPERES AMPERES INTERRUPTING CAPACITY AMERICAN WIRE GAUGE ROOT MEAN SQUARE REMOVE EXISTING CONDUIT CIRCUIT BREAKER SHP SECURITY HEADEND PANEL CCT CKT S/N SPD CORRELATED COLOR TEMPERATURE SOLID NEUTRAL CIRCUIT SURGE PROTECTIVE DEVICE CLG CEILING SWBD SWITCHBOARD DWG SYM SYMMETRICAL DRAWING **EXISTING** TELECOMMUNICATION BACKBOARD TELE TYP FULL LOAD AMPERES TELEPHONE GROUND FAULT CIRCUIT INTERRUPTER TYPICAL G/GRD UNLESS NOTED OTHERWISE GROUND HORSEPOWER VOLTS HERTZ **VOLT-AMPERE** SHORT CIRCUIT INTERRUPTING CAPACITY (RMS WIRE, WATTS SYMMETRICAL AMPERES) WEATHERPROOF JUNCTION BOX WYE CONNECTED THOUSAND CIRCULAR MILLS SINGLE POLE KILOVOLTS DOUBLE POLE KILO-VOLT-AMPERES THREE POLE KILOWATTS **FOUR POLE** 

# **GENERAL SYMBOLS**

⟨#⟩ SPECIFIC NOTE

#

REVISION OUND

REVISION CLOUD

DELAWARE RIVER AND BAY AUTHORITY
CAPE MAY AIRPORT

CONTRACT No. CS-XX-XX
CAPE MAY KITCHEN CONCEPT

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ELECTRICAL COVER SHEET

E100

DATE: OCTOBER 2020 SCALE: NONE SHEET NO. 6

