
S	Sheet List Table
Sheet Number	Sheet Title
G-000	COVER SHEET
A-001	ARCHITECTURAL GENERAL NOTES, ABBREVIATION, AND SYMBOLS
A-002	TYPICAL MOUNTING HEIGHTS
AP101	PHASING PLAN
A-101	DEMOLITION PLAN
A-102	CONSTRUCTION FLOOR PLAN
A-401	FINISH PLAN, ENLARGED PLANS AND ELEVATIONS
A-501	SCHEDULES AND DETAILS
M-000	GENERAL NOTES SYMBOLS AND ABBREVIATIONS
M-100	HVAC DEMOLITION PLAN
M-101	ROOF HVAC DEMOLITION PLAN
M-110	HVAC PLAN
M-111	ROOF HVAC PLAN
M-501	HVAC DETAILS
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P-000	GENERAL NOTES SYMBOLS AND ABBREVIATIONS
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E-000	GENERAL NOTES SYMBOLS AND ABBREVIATIONS
E-100	ELECTRICAL DEMOLITION PLAN
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E-102	POWER AND LOW-VOLTAGE PLANS - OVERALL
E-103	POWER AND LOW-VOLTAGE PLANS - PHASE 1
E-104	POWER AND LOW-VOLTAGE PLAN - PHASE 2
E-105	SECURITY ACCESS PLAN

# DELAWARE RIVER AND BAY AUTHORITY CAPE MAY - LEWES FERRY

CONTRACT NO. CMLF-C19-06
CAPE MAY DISPATCH CENTER REHAB
CAPE MAY TERMINAL - POLICE AND
ADMINISTRATION BUILDING
NEW JERSEY

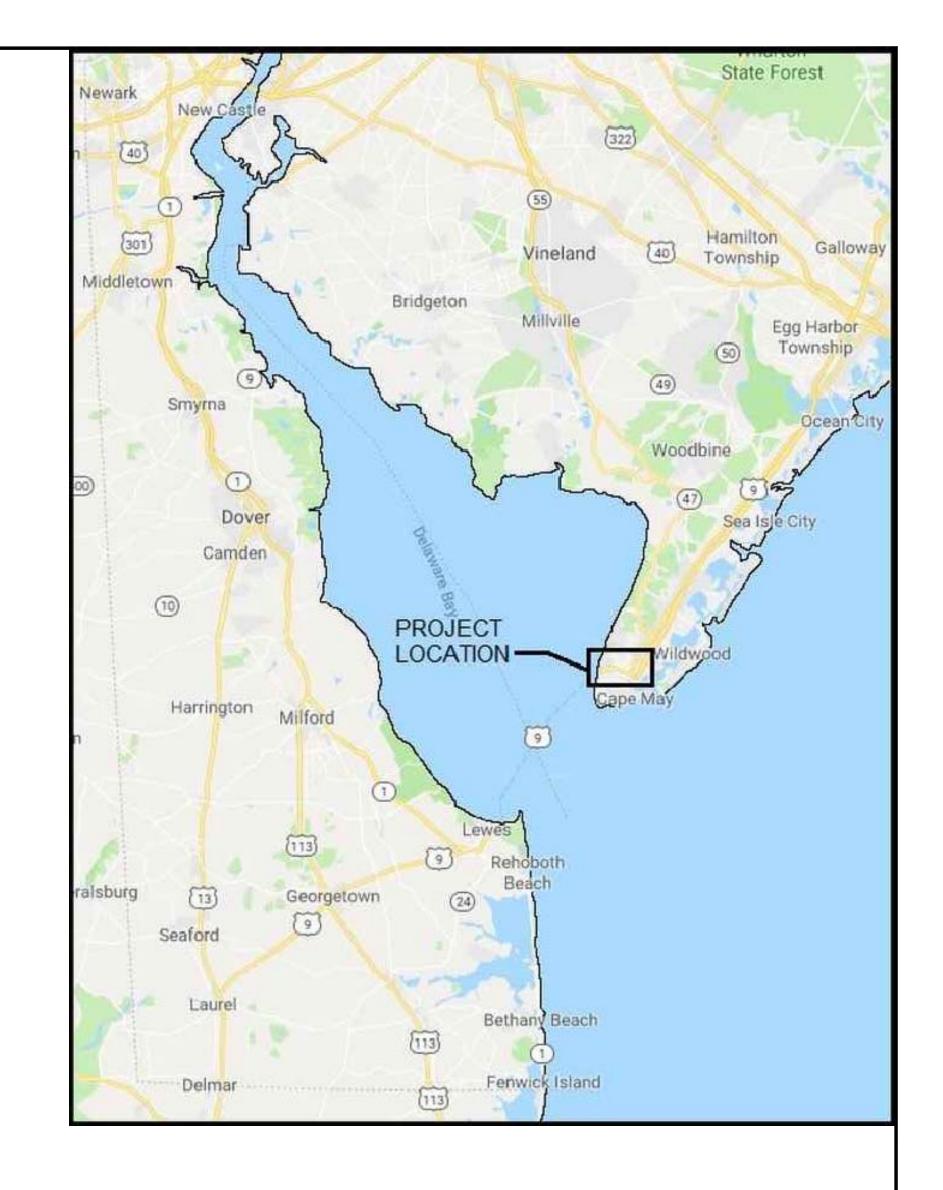









DRBA CAPE MAY-LEWES FERRY TERMINAL
 POLICE AND ADMINISTRATION BUILDING

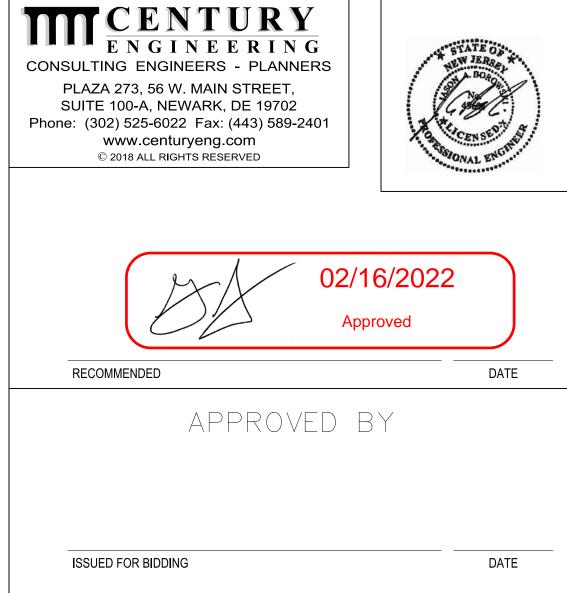


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THE DELAWARE OFFICE

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THE POOL STELL ST

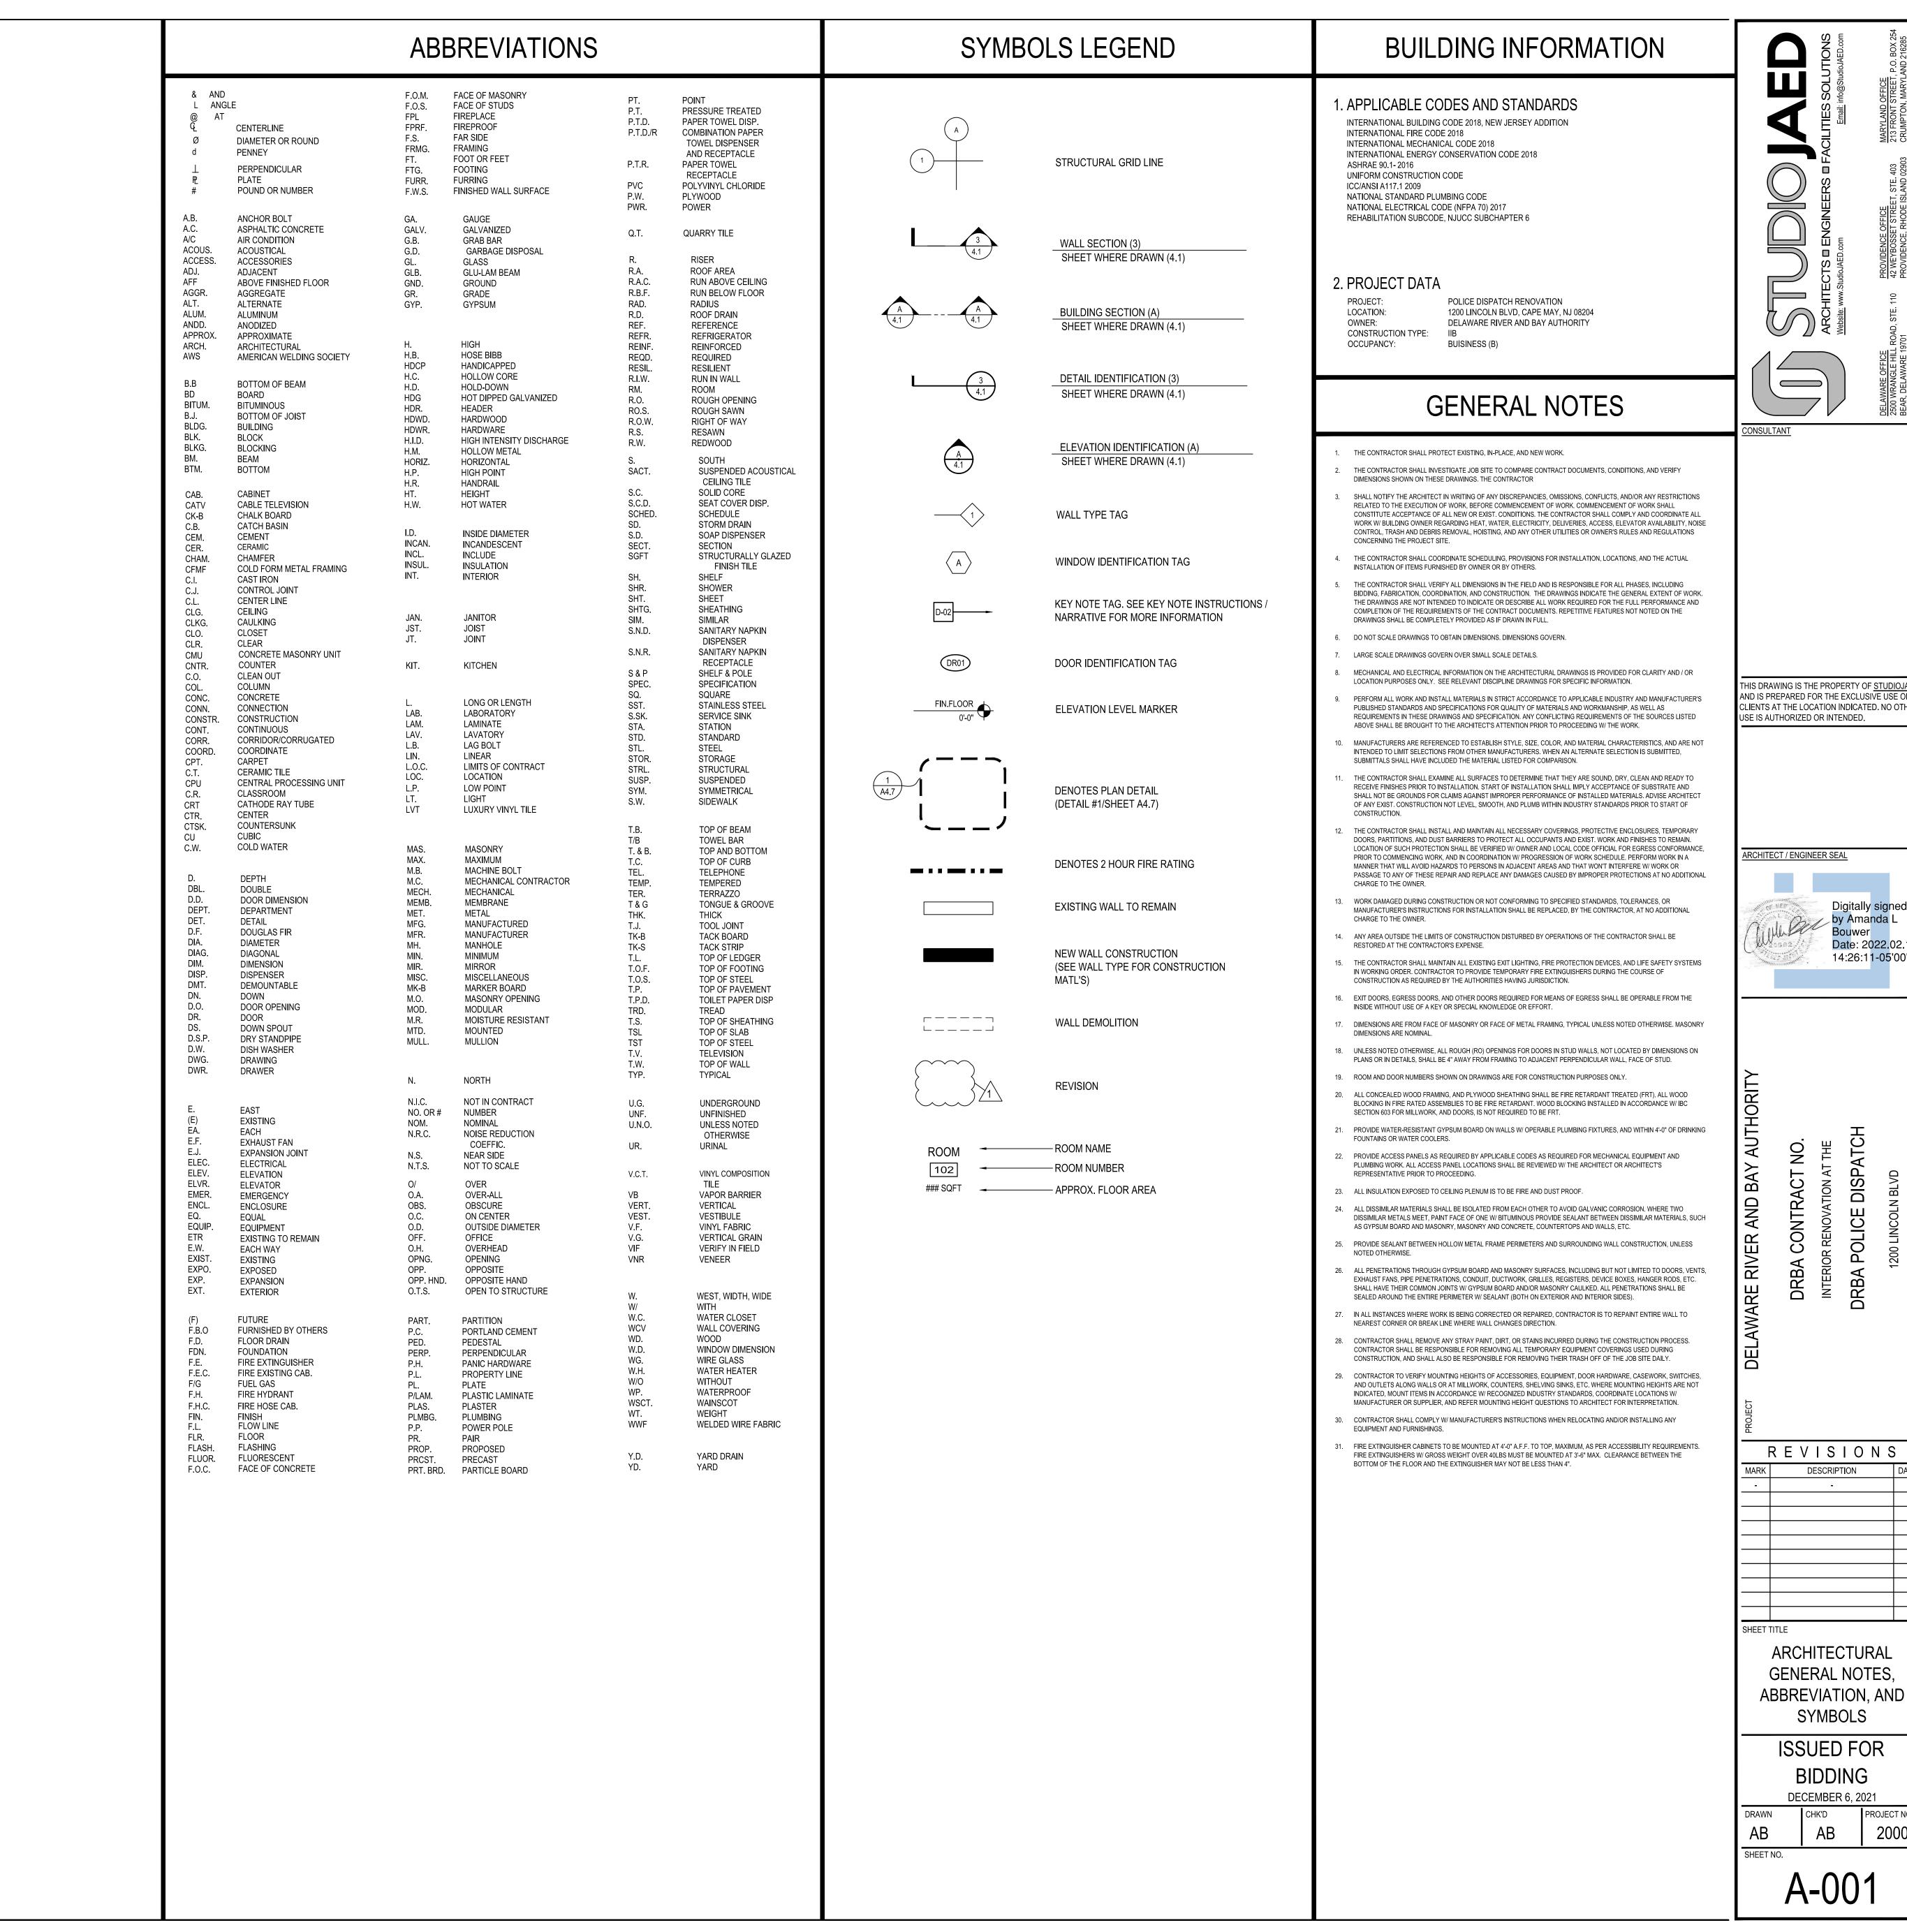Digitally signed to Amanda L Bouw Date: 2022.02.18 14:26:04-05'00'

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R RENOVATION AT THE
POLICE DISPATCH

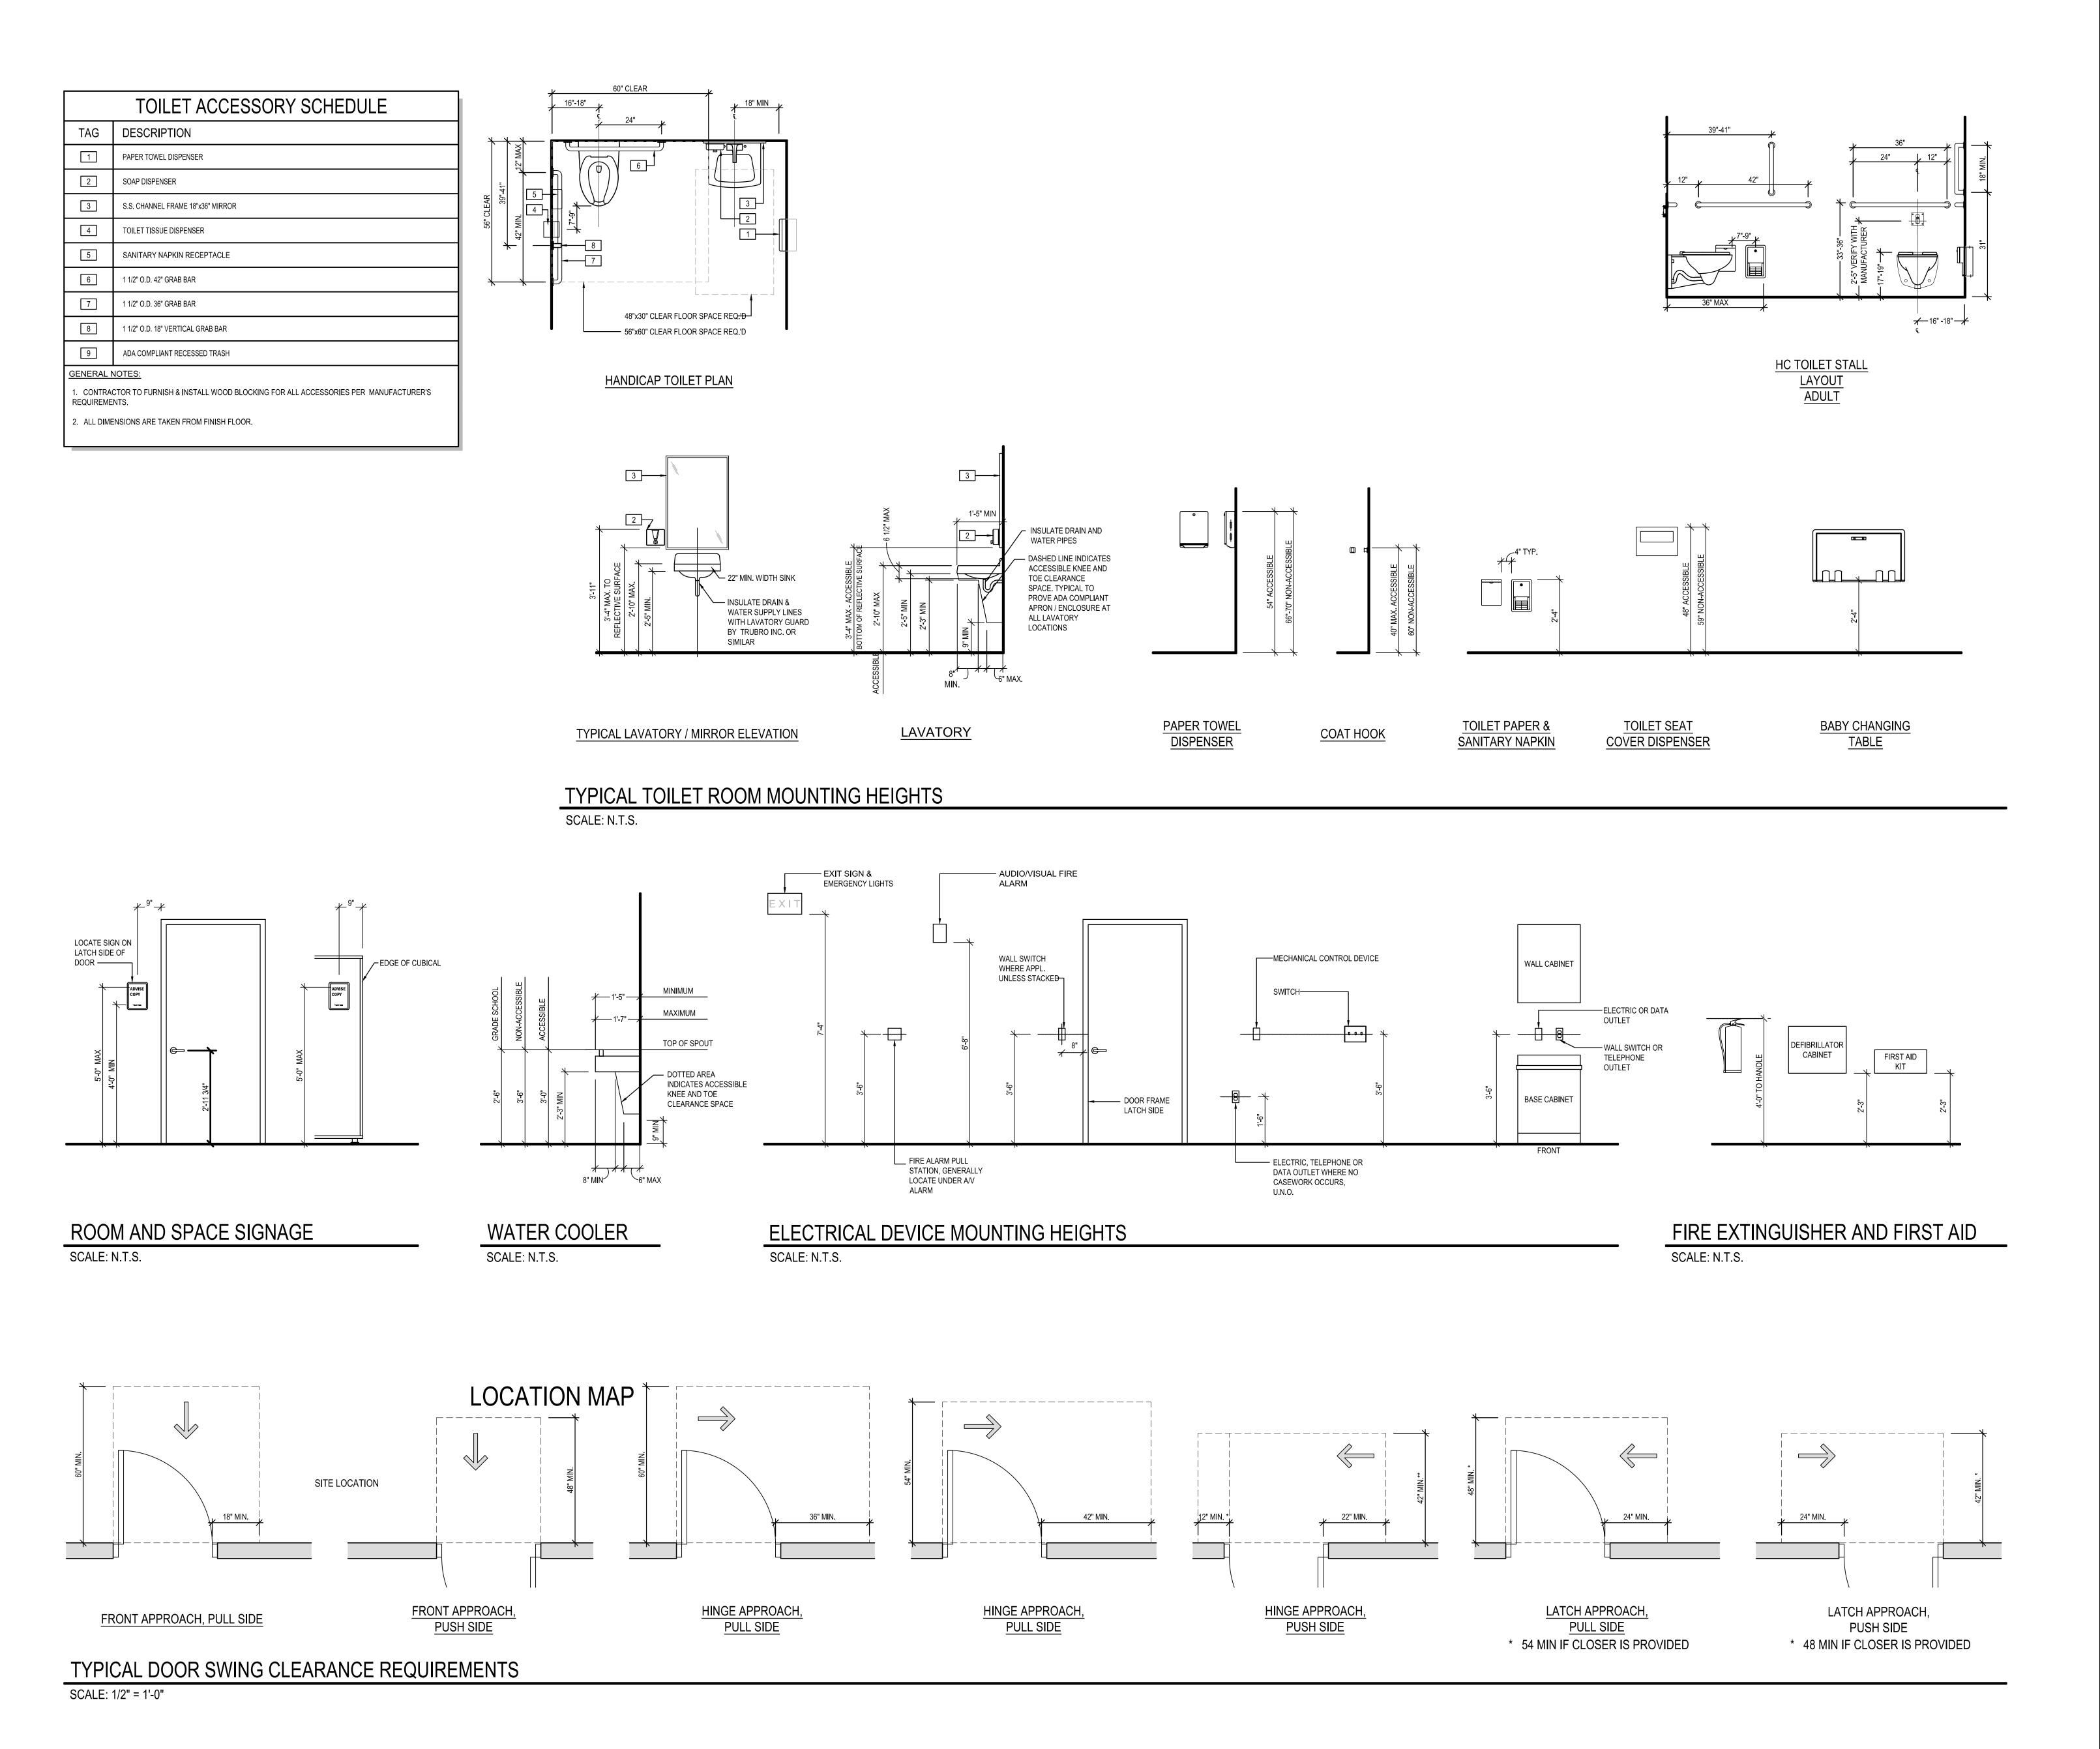DRBA CONTFINTERIOR RENOVA

DRBA POLICE


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TYPICAL MOUNTING HEIGHTS


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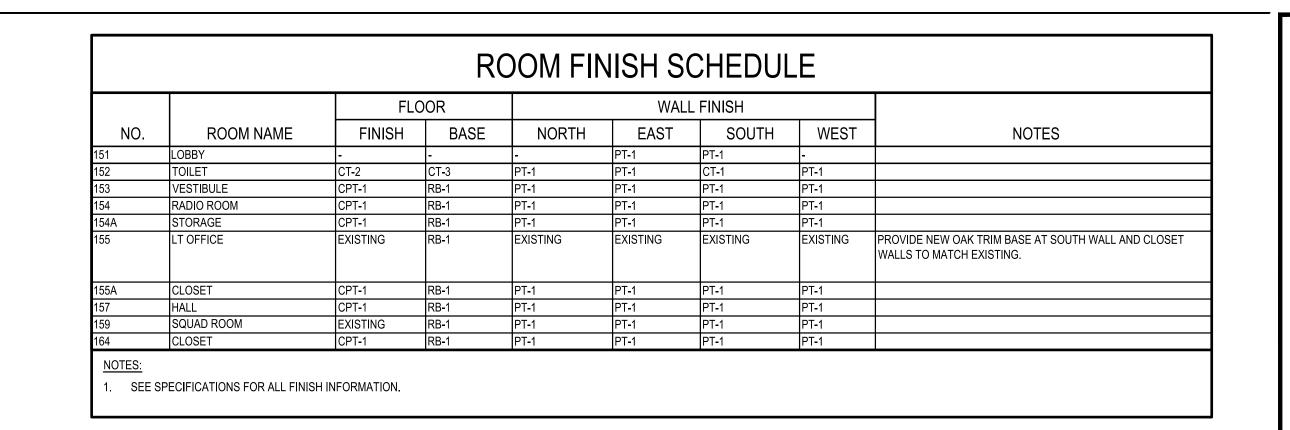
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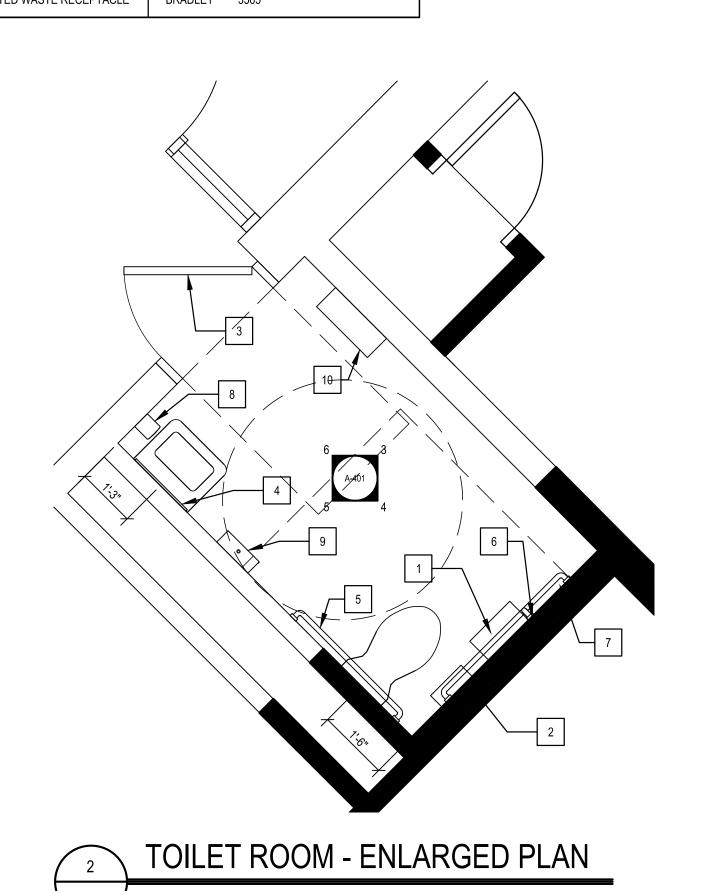
A-002







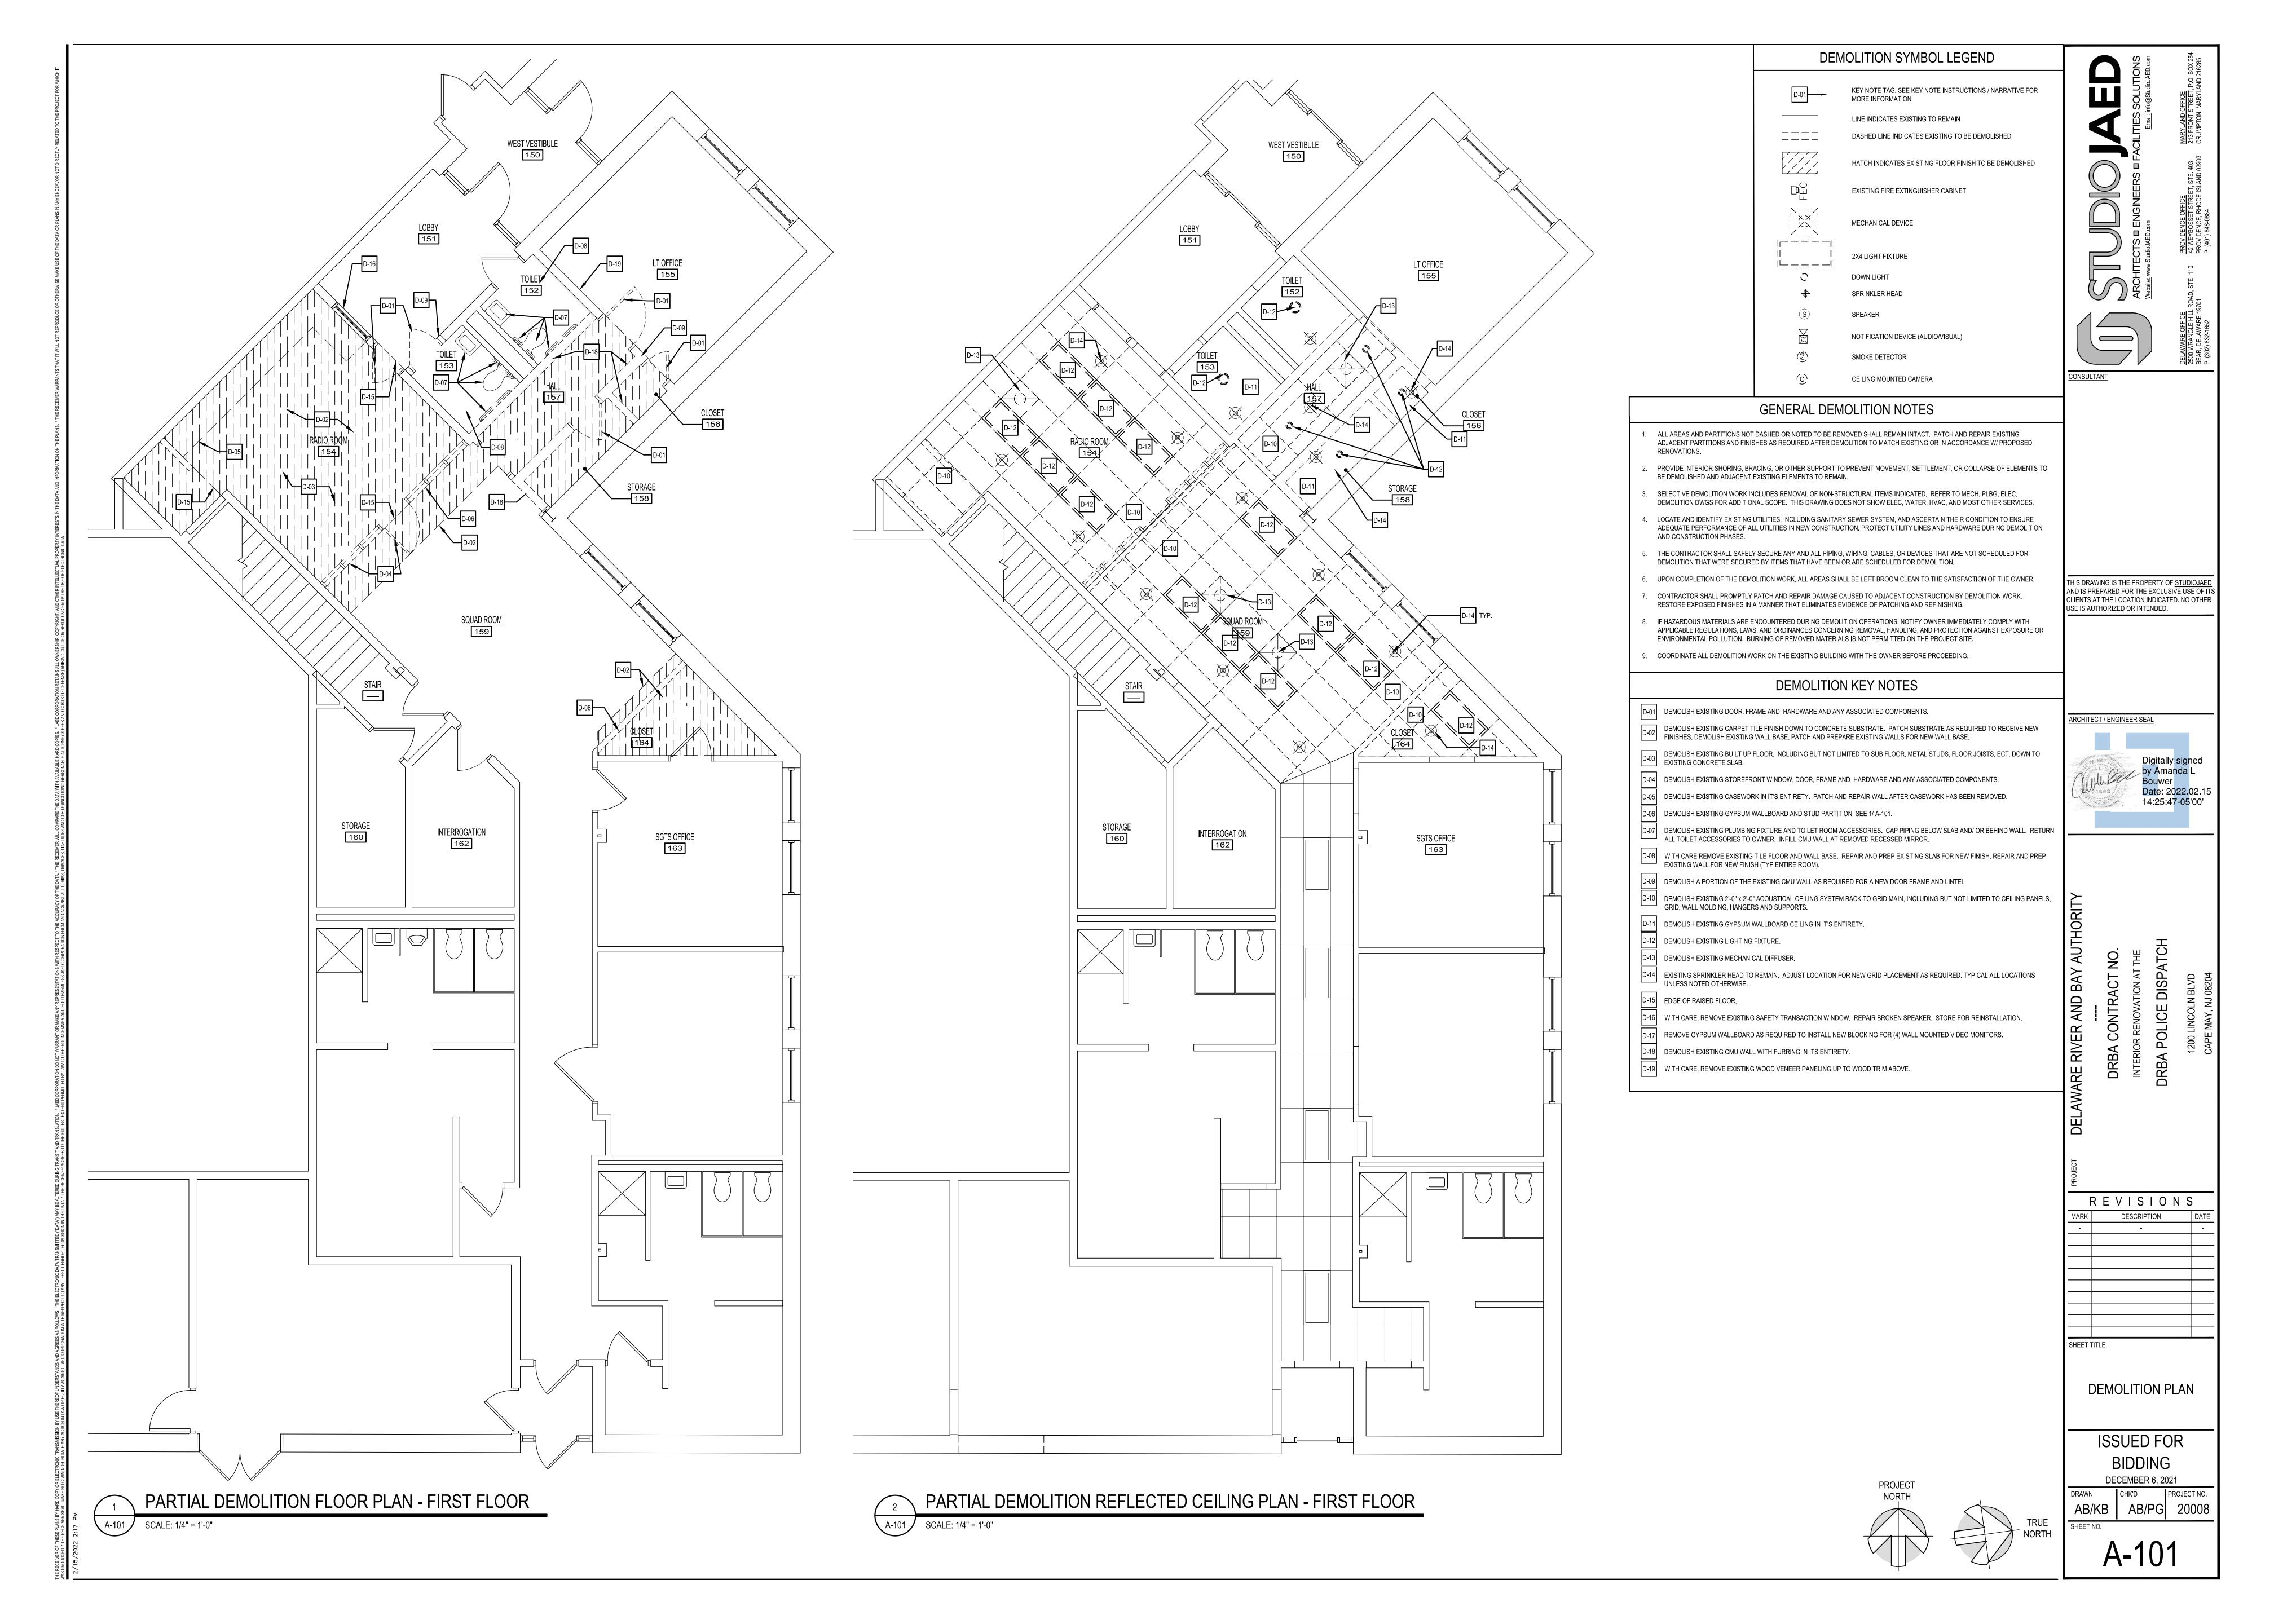

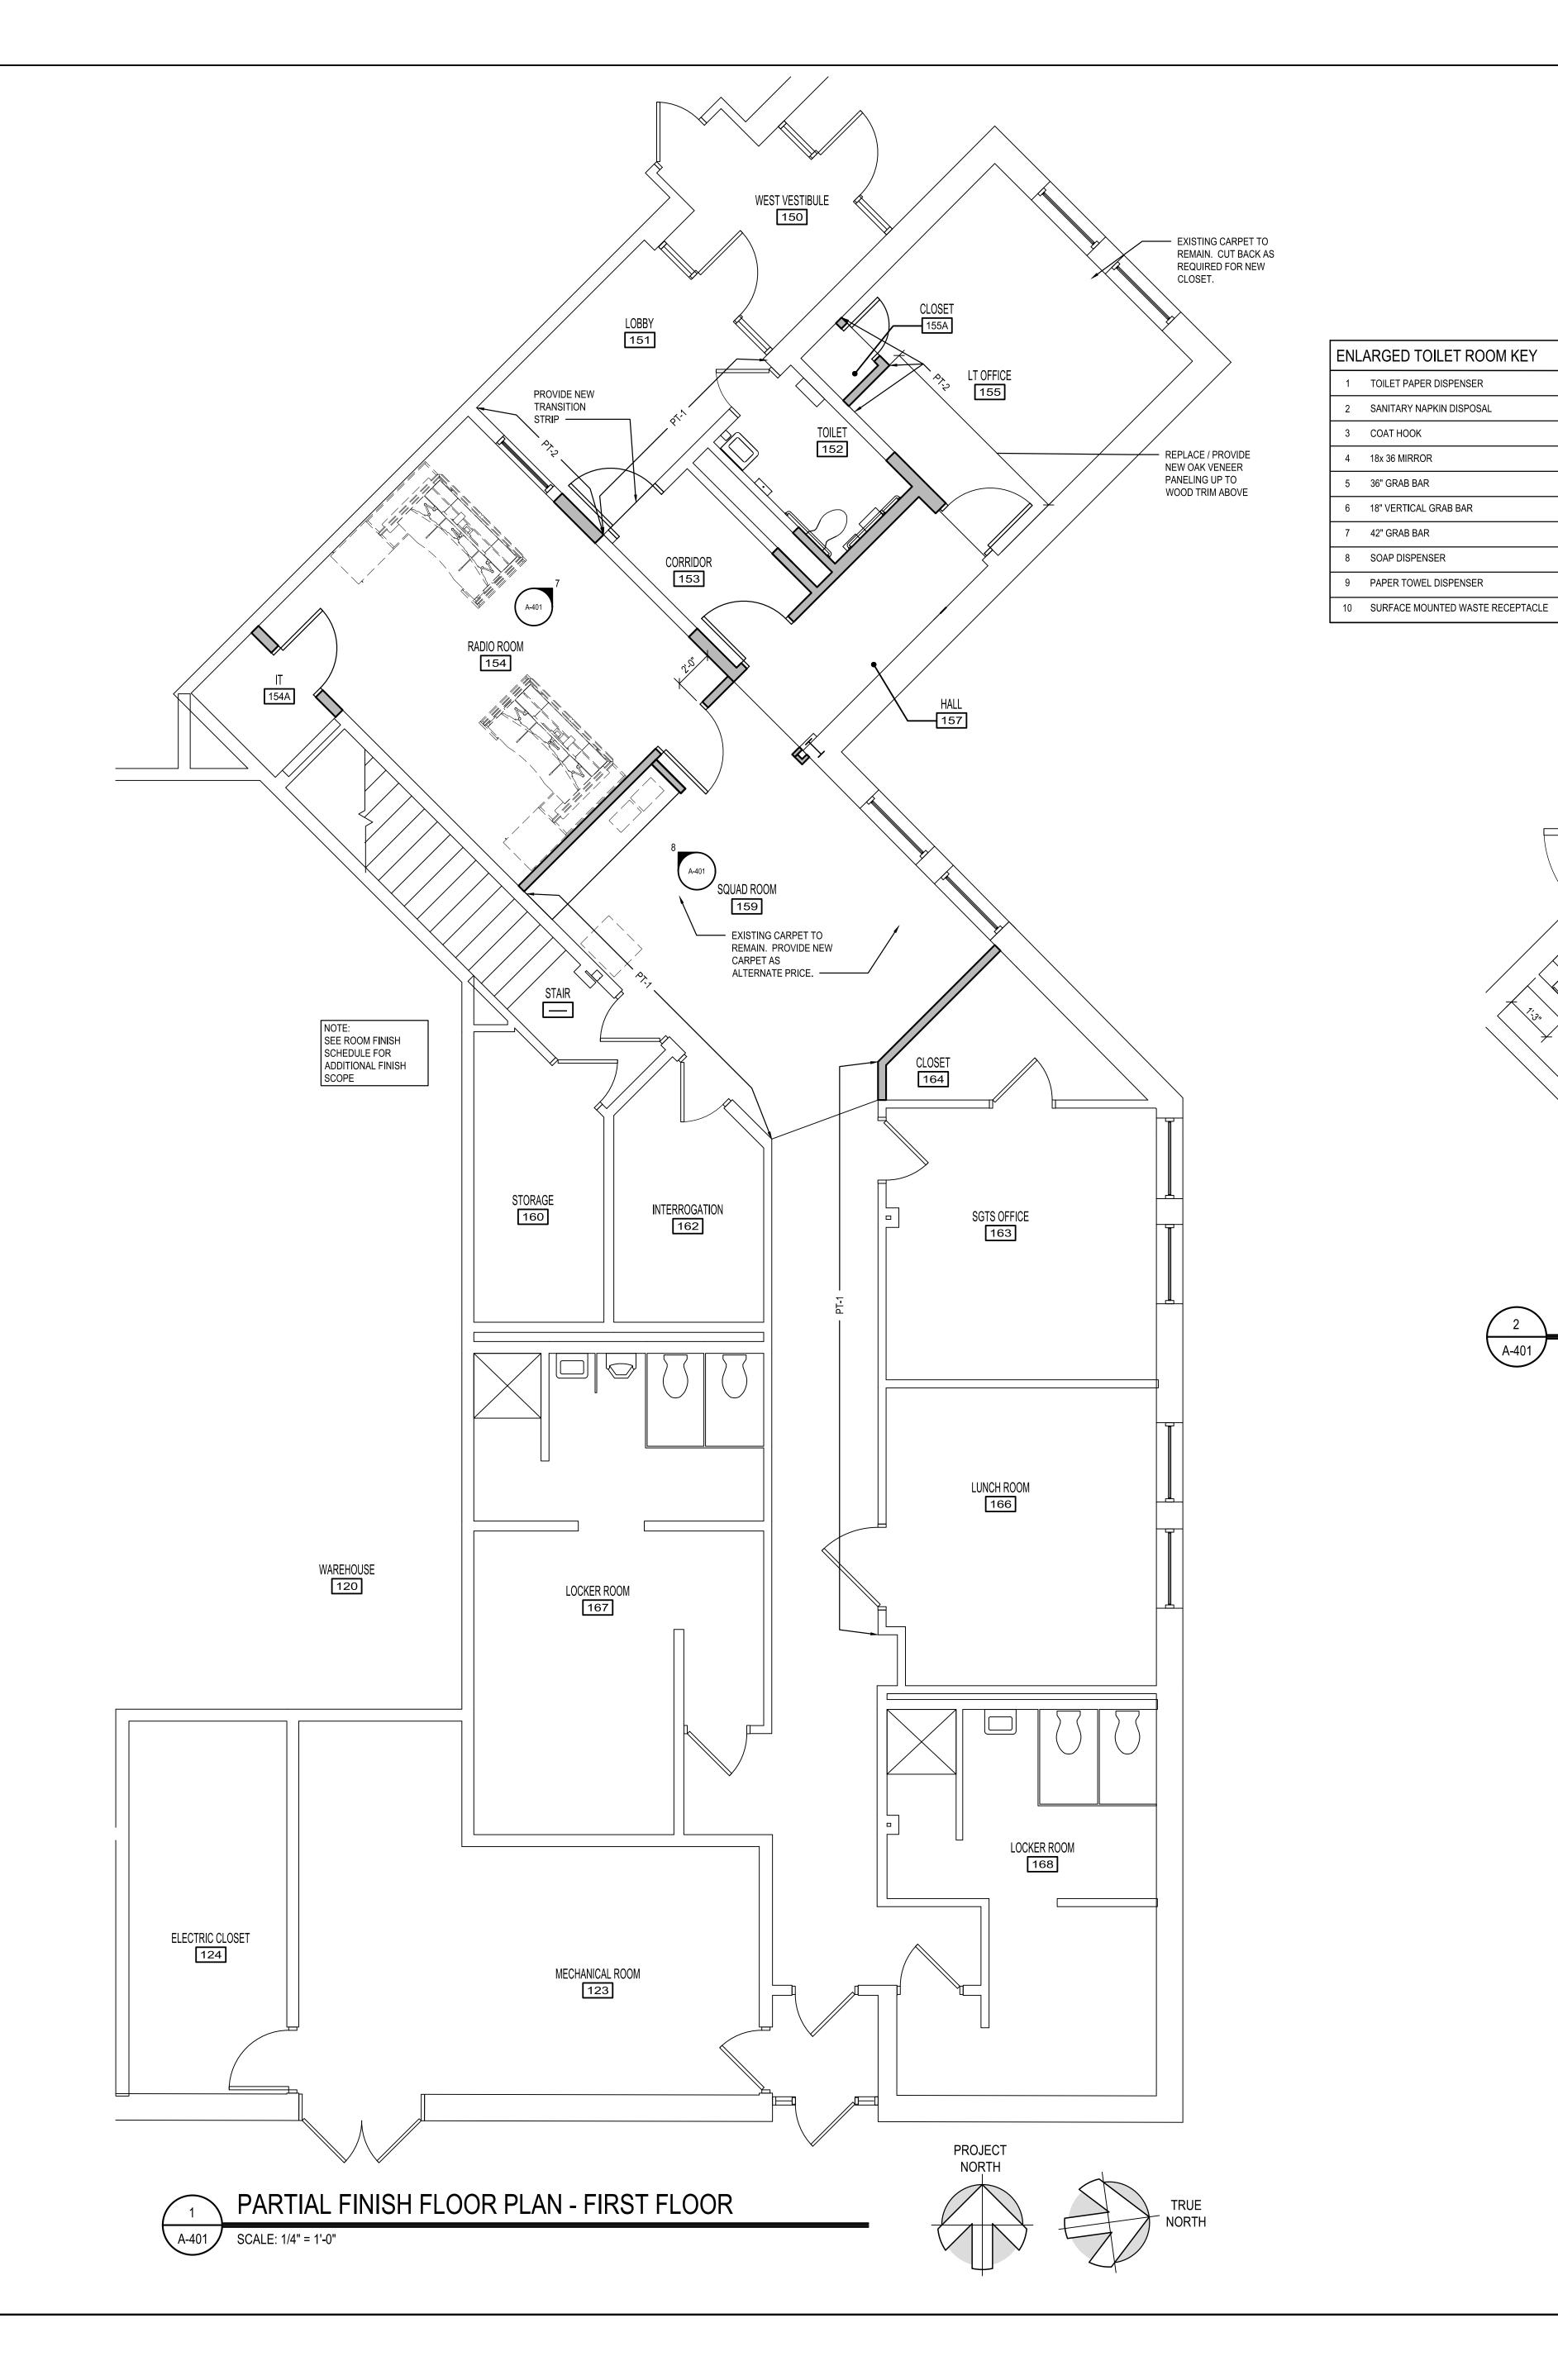

OWNER SUPPLIED CONTRACTOR INSTALLED

OWNER SUPPLIED CONTRACTOR INSTALLED

OWNER SUPPLIED CONTRACTOR INSTALLED

BRADLEY 4722-15


BRADLEY 931


BRADLEY 780

BRADLEY 812x36


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BRADLEY 812x42



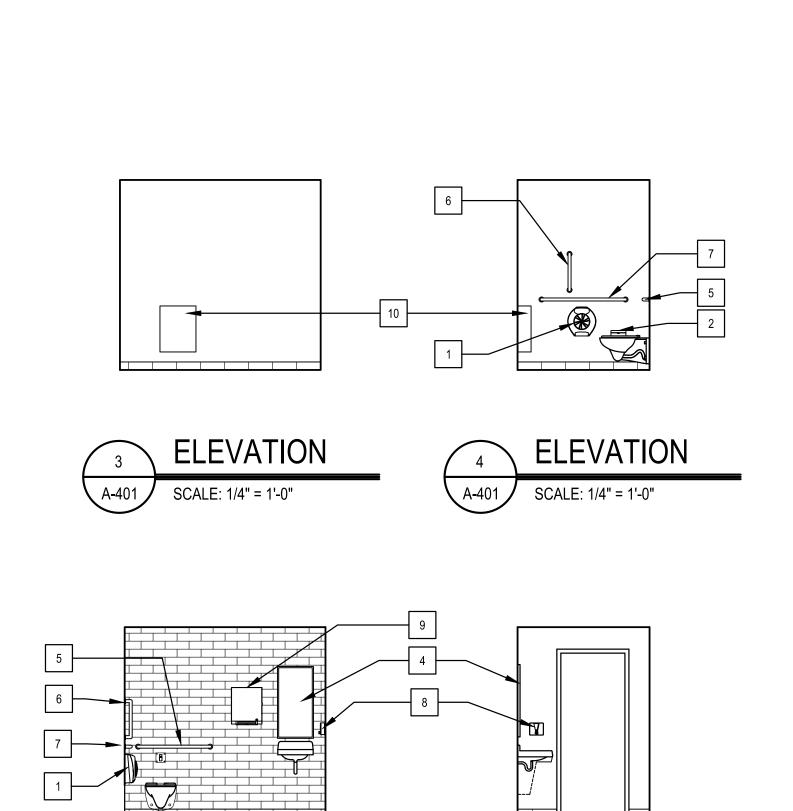

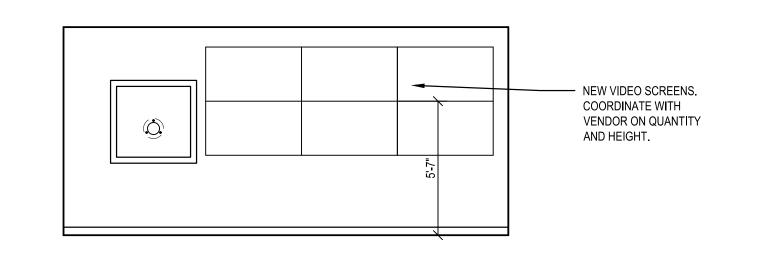
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ARCHITECT / ENGINEER SEAL


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DRAWN CHK'D PROJECT

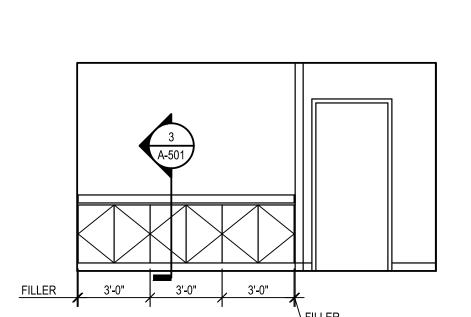KB/AB AB/PG 200

A-401

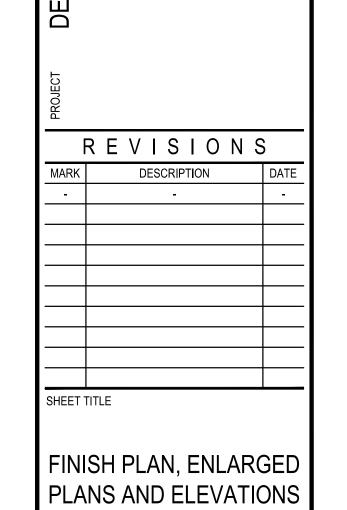

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$\frac{1}{2}$	ιχ.					DESCRIPTI	ION					FRAME DETAILS		SET	
	DOOR NUMBER	DOOR WIDTH	R SHT	DOOR		DOOR			FRAME		FIRE RATING	٥	В	HARDWARE S	REMARKS
<b>┤</b> ┃	DOC	000	DOOR HEIGHT	DOO THIC	TYPE	MATERIAL	FINISH	TYPE	MATERIAL	FINISH	FIRE	HEAD	JAMB	HAR	KEWARKS
	152	ETR	ETR	ETR	ETR	ETR	ETR	ETR	ETR	PAINTED	ETR	ETR	ETR	4	REPAINT DOOR FRAME. REMOVE EXISTING HARDWARE, REPAIR AND STAIN DOOR.
	153	3'-0"	7'-0"	1 3/4"	N	WD	STAINED	F1	НМ	PAINTED	0	H-2	J-2	3	LEVEL 2 BALLISTIC WOOD DOOR
	154	3'-0"	7'-0"	1 3/4"	F	WD	STAINED	F1	НМ	PAINTED	0	H-1	J-1	1	-
	154A	3'-0"	7'-0"	1 3/4"	F	WD	STAINED	F1	НМ	PAINTED	0	H-1	J-1	5	
	155	3'-0"	7'-0"	1 3/4"	F	WD	STAINED	F1	НМ	PAINTED	0	H-3	J-3	1	-
	155A	2'-0"	7'-0"	1 3/4"	F	WD	STAINED	F1	НМ	PAINTED	0	H-1	J-1	2	
	157	3'-0"	7'-0"	1 3/4"	N	WD	STAINED	F1	НМ	PAINTED	0	H-1	J-1	3	LEVEL 2 BALLISTIC WOOD DOOR
	152	ETR	ETR	ETR	ETR	ETR	ETR	ETR	ETR	ETR	ETR	ETR	ETR	4	REMOVE EXISTING HARDWARE. REPAIR AND STAIN DOOR AS REQUIRED FOR NEW HARDWARE.

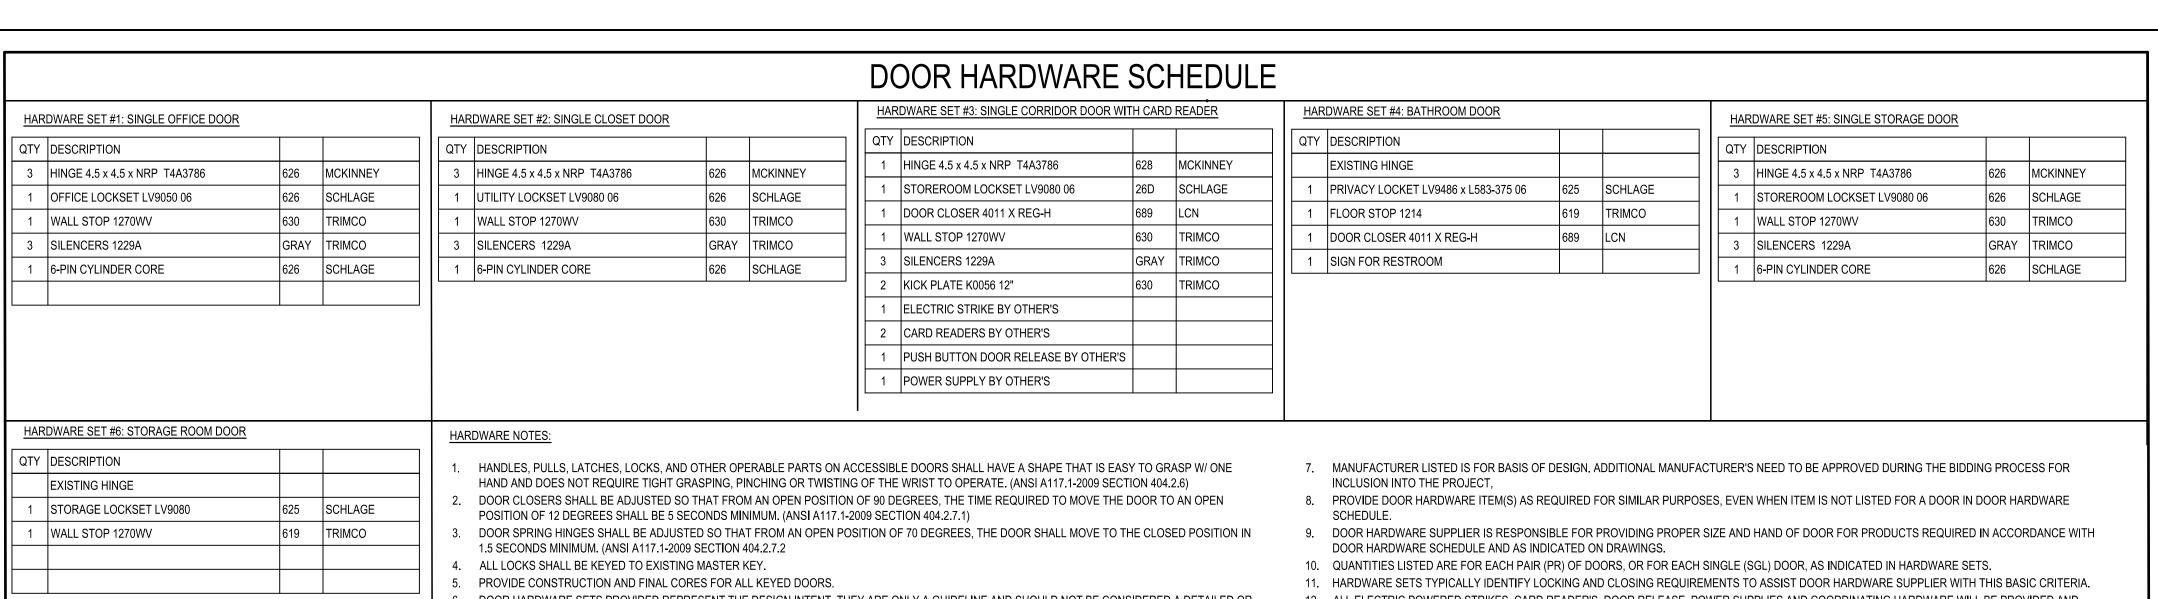Amanda L Bouwe

Date: 2022.02.15


14:25:16-05'00'

DESCRIPTION

**DETAILS** 

**BIDDING** 

CHK'D

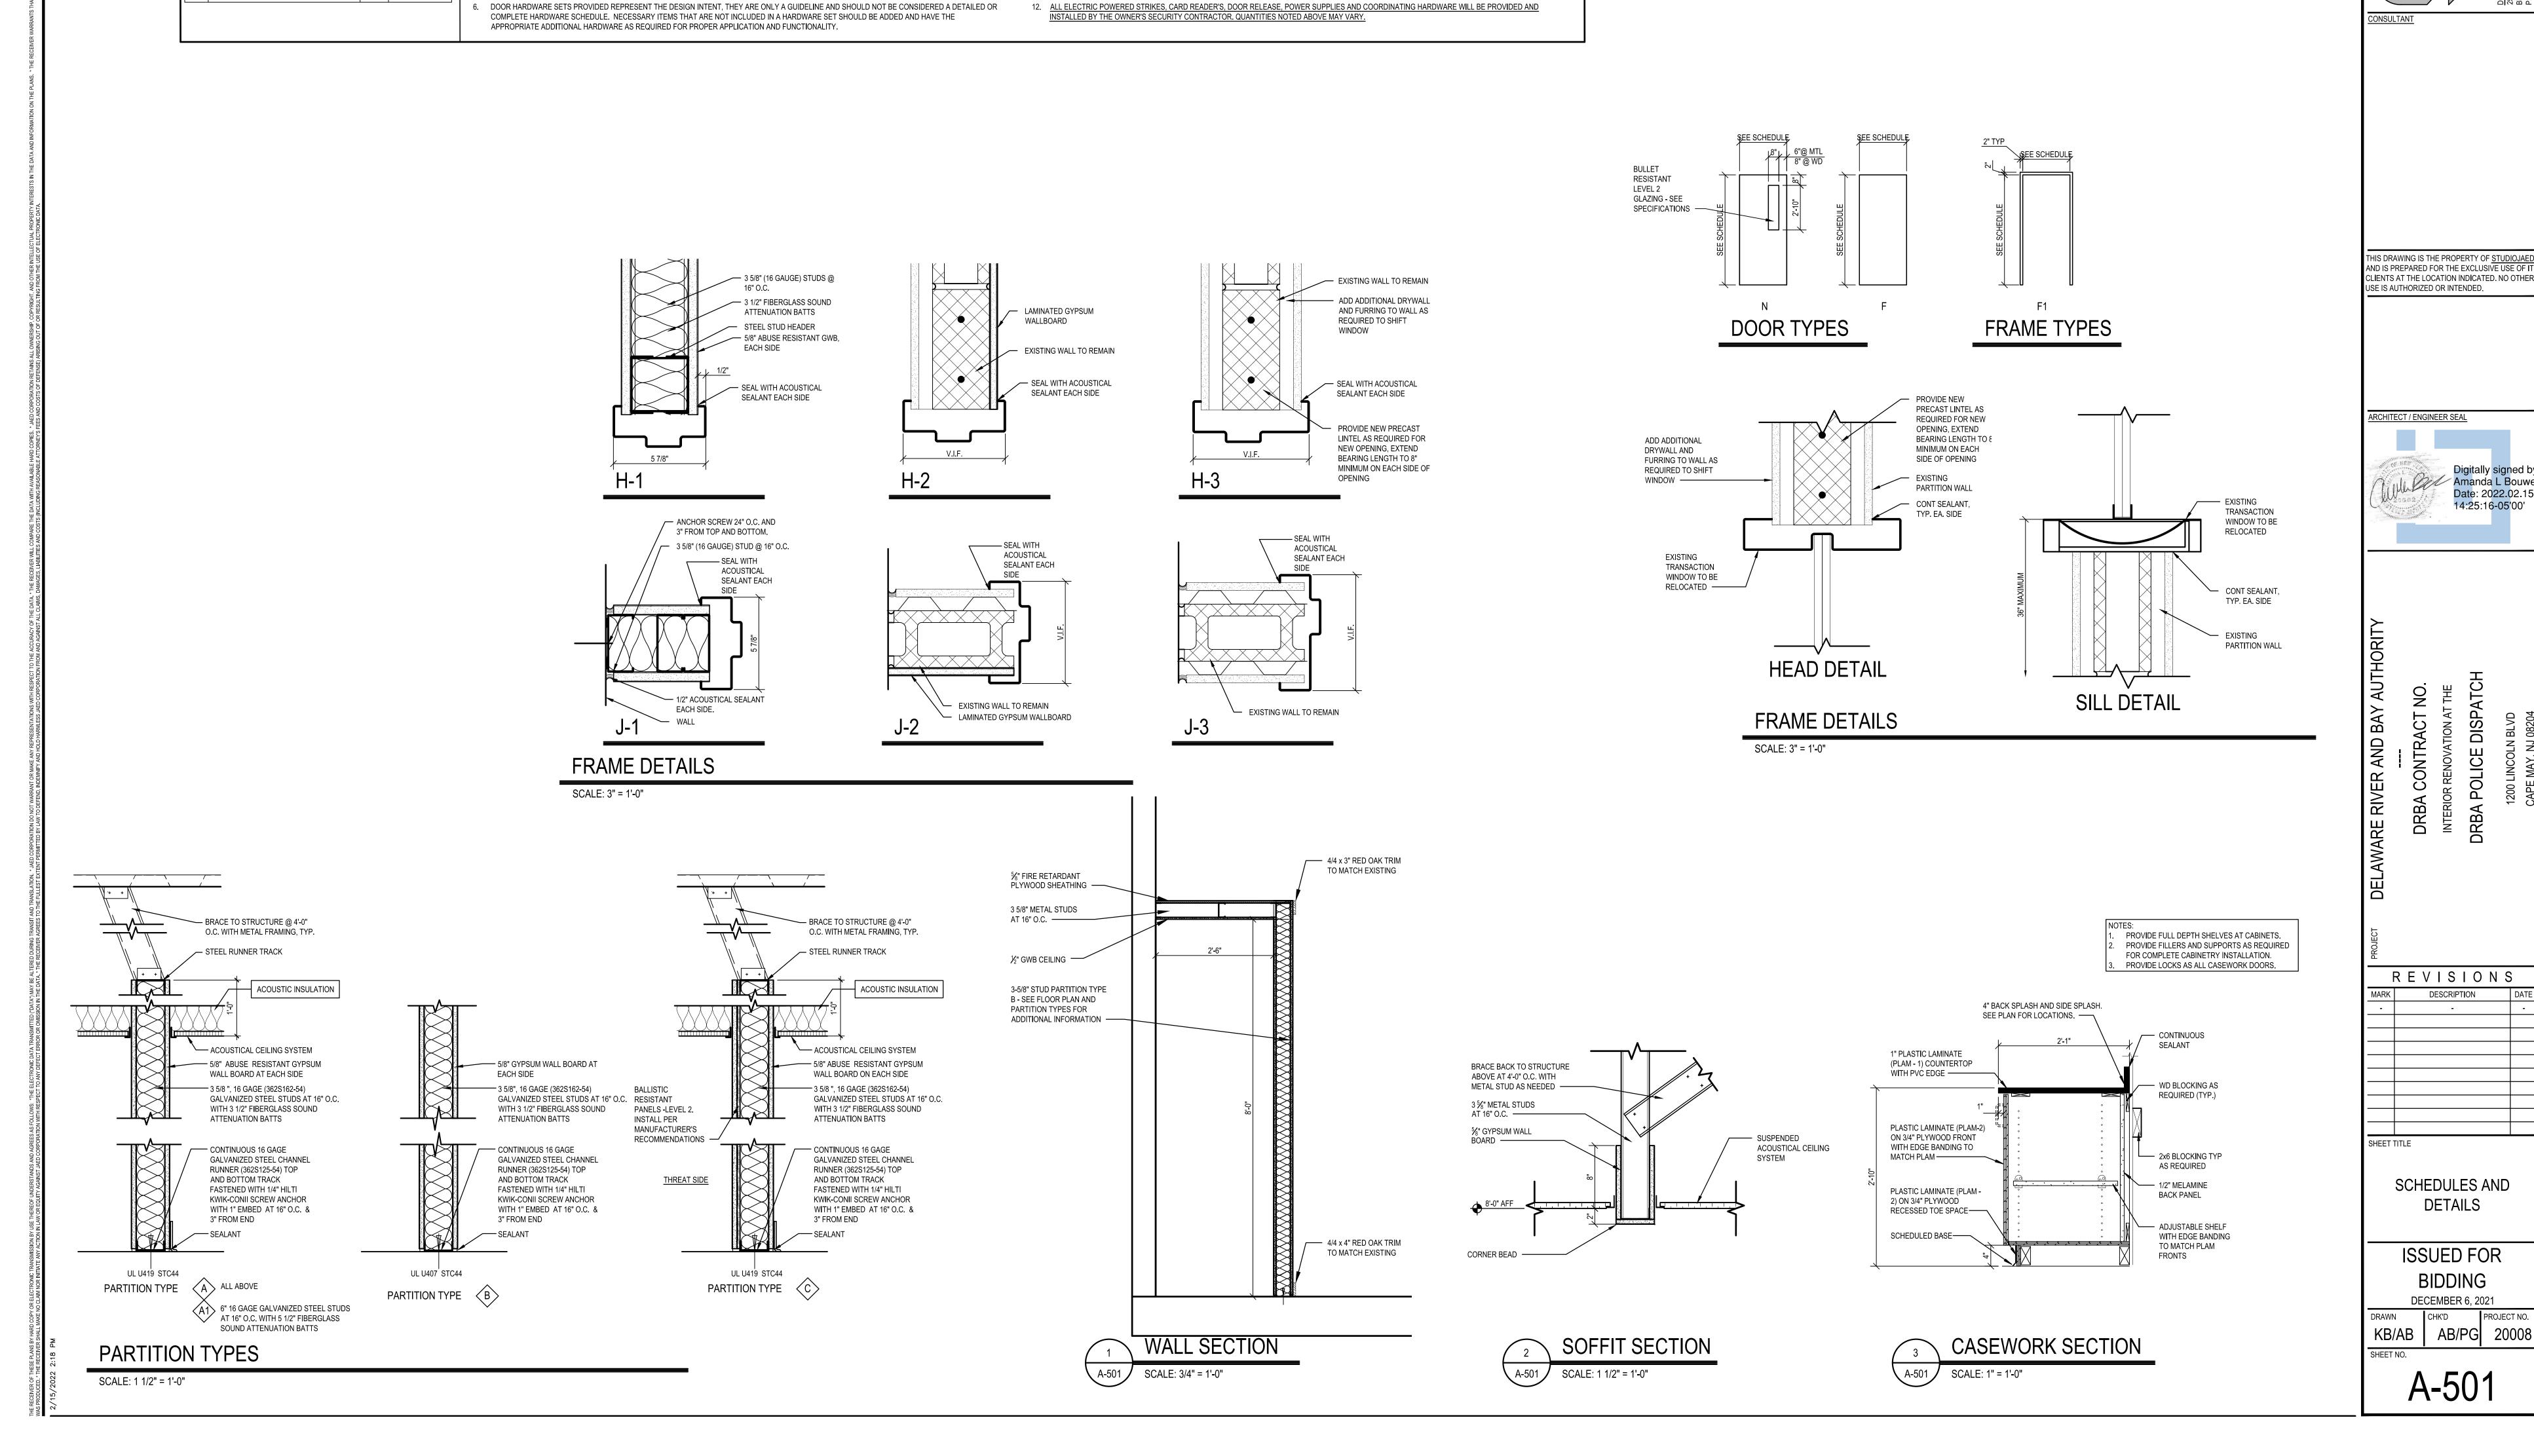

#### **GENERAL DEMOLITION NOTES**

- A. THE CONTRACTOR SHALL FIELD VERIFY THE EXISTING ELECTRICAL WORK SHOWN ON THESE DRAWINGS.
- B. THE EXTENT OF ELECTRICAL DEMOLITION SHALL BE AS NOTED ON THE DRAWINGS. SHOULD THERE BE ANY QUESTION AS TO THE DISPOSITION OF ANY EXISTING ELECTRICAL WORK, IT SHALL BE BROUGHT TO THE ATTENTION OF THE OWNER. THE FINAL DISPOSITION OF SUCH WORK SHALL BE AS DIRECTED BY THE
- C. WHEREVER EXISTING ELECTRICAL WORK IS INDICATED TO BE REMOVED, THE FOLLOWING NOTES SHALL
- 1. WIRING SHALL BE REMOVED AS NOTED ON DRAWINGS.
- 2. SURFACES WHICH ARE DISTURBED BY DEMOLITION UNDER THIS WORK SHALL BE PATCHED WITH MATERIALS TO MATCH THE EXISTING SURFACE. PATCHING SHALL MATCH THE EXISTING SURROUNDING SURFACES, AND SHALL BE DONE TO THE COMPLETE SATISFACTION OF THE OWNER.

#### **GENERAL NOTES - ELECTRICAL WORK**

- 1. DRAWINGS SHALL NOT BE SCALED.
- 2. THE ELECTRICAL CONTRACTOR SHALL COORDINATE HIS WORK WITH THAT OF OTHER TRADES. THE MECHANICAL AND OTHER DRAWINGS AND SPECIFICATIONS SHALL BE CONSULTED AND COORDINATED WITH PRIOR TO ROUGH-IN.
- 3. WHEREVER POSSIBLE. THE CONTRACTOR SHALL OBTAIN ACTUAL ROUGH-IN DRAWINGS FOR THE ACTUAL ITEM OF EQUIPMENT TO BE INSTALLED PRIOR TO ROUGH-IN. THIS SHALL APPLY TO EQUIPMENT, WHETHER IT IS TO BE INSTALLED BY THE CONTRACTOR OR BY THE OWNER.
- 4. IT IS THE INTENT OF THESE DRAWINGS THAT NEW ELECTRICAL WORK TO BE INSTALLED IN FINISHED AREAS. BE INSTALLED CONCEALED WITHIN NEW OR EXISTING WALLS, FLOORS OR CEILINGS. ANY AND CUTTING AND PATCHING OF SURFACES SHALL BE PROVIDED BY THE
- 5. WHERE CIRCUIT AND HOMERUN LINES ARE NOT SHOWN, PROVIDE MINIMUM 2#12+1#12 GROUND + PULL STRING IN 1" CONDUIT.
- 6. PROVIDE PULL STRINGS IN ALL CONDUITS.
- 7. WHERE NEW LOADS ARE ADDED AND EXISTING LOADS REMOVED, PROVIDE UPDATED PRINTED CIRCUIT DIRECTORIES FOR PANELBOARDS TO INDICATE TYPE OF LOAD SERVED AND AREA SERVED (E.G. RECEPTACLES-OFFICE 201).
- 8. UNLESS NOTED OTHERWISE, EVERY CONDUIT CONTAINING 120V OR GREATER WIRING SHALL CONTAIN A SEPARATE INSULATED GROUND WIRE RATED FOR 600V.
- 9. ELECTRICAL PENETRATIONS FOR BOXES, DEVICES, EQUIPMENT, WIRING AND RACEWAYS IN FIRE-RESISTANCE-RATED CONSTRUCTION SHALL COMPLY WITH REQUIREMENTS OF THE INTERNATIONAL BUILDING CODE, "PENETRATIONS" SECTION. PROVIDE FIRE SEALANT FOR PENETRATIONS THROUGH FIRE RATED FLOORS AND WALLS TO MAINTAIN THE APPLICABLE FIRE
- 10. PROVIDE STRUCTURAL STEEL FRAME SUPPORTS AS REQUIRED FOR DISCONNECT SWITCHES, MOTOR STARTERS, ETC.. (IF DISCONNECT SWITCHES OR STARTERS ARE LOCATED ON EQUIPMENT HOUSINGS, COORDINATE LOCATIONS WITH EQUIPMENT SUPPLIER TO ENSURE SWITCHES/STARTERS ARE NOT INSTALLED ON EQUIPMENT ACCESS PANELS). MAINTAIN PROPER NATIONAL ELECTRICAL CODE CLEARANCES. IN ADDITION, MAINTAIN PROPER MECHANICAL WORKING CLEARANCES FOR SERVICING OF EQUIPMENT.
- 11. UNLESS INDICATED OTHERWISE, PROVIDE FINAL CONNECTIONS TO EQUIPMENT.

#### **ELECTRICAL ABBREVIATIONS** (NOT ALL USED

Ą	AMPERE(S)	MS	MOTOR STARTER
ADA	AMERICAN DISABILITY ACT	NEC	NATIONAL ELECTRICAL CODE
\FF	ABOVE FINISHED FLOOR	NO	NORMALLY OPEN
AIC	AMPERES INTERRUPTING CAPACITY	NTS	NOT TO SCALE
AWG	AMERICAN WIRE GAUGE	OC	ON CENTER
2	CONDUIT	OH	OVERHEAD
CB	CIRCUIT BREAKER	OTA	OVER THE AIR
CCT	CORRELATED COLOR TEMPERATURE	Ø	PHASE
CKT	CIRCUIT	P	POLE
CLG	CEILING	PNL	PANELBOARD
)WG	DRAWING	PRI	PRIMARY
X	EXISTING	RL	RELOCATE EXISTING
LA	FULL LOAD AMPERES	RLA	RUNNING LOAD AMPERES
3FI	GROUND FAULT CIRCUIT INTERRUPTER	RMS	ROOT MEAN SQUARE
G/GRD	GROUND	RX	REMOVE EXISTING
<del>I</del> P	HORSEPOWER	SHP	SECURITY HEADEND PANEL
łΖ	HERTZ	S/N	SOLID NEUTRAL
G	ISOLATED GROUND	SPD	SURGE PROTECTIVE DEVICE
sc	SHORT CIRCUIT INTERRUPTING CAPACITY	SWBD	SWITCHBOARD
RMS SY	MMETRICAL AMPERES)	SYM	SYMMETRICAL
IB	JUNCTION BOX	TBB	TELECOMMUNICATION BACKBOA
Ccmil	THOUSAND CIRCULAR MILLS	TELE	TELEPHONE
(V	KILOVOLTS	TYP	TYPICAL
(VA	KILO-VOLT-AMPERES	UNO	UNLESS NOTED OTHERWISE
(W	KILOWATTS	V	VOLTS
.TG	LIGHTING	VA	VOLT-AMPERE
.V	LOW VOLTAGE	W	WIRE, WATTS
/ICA	MINIMUM CIRCUIT AMPACITY	WP	WEATHERPROOF
/ICB	MAIN CIRCUIT BREAKER	Υ	WYE CONNECTED
/ICP	MOTOR CIRCUIT PROTECTOR	1P	SINGLE POLE
ЛΗ	MOUNTING HEIGHT	2P	DOUBLE POLE
/IISC	MISCELLANEOUS	3P	THREE POLE
ΛLO	MAIN LUGS ONLY	4P	FOUR POLE

#### FIRE ALARM SYSTEM LEGEND

MAXIMUM OVER-CURRENT PROTECTION DEVICE

HORN-STROBE COMBINATION STROBE

SMOKE DETECTOR

#### **COMMUNICATIONS LEGEND**

SINGLE GANG BOX, WALL MOUNT AT 18" A.F.F. UNLESS NOTED OTHERWISE. PROVIDE PULL STRING IN 1" CONDUIT TO ABOVE ACCESSIBLE CEILING.

	PANEL NAME EXISTING CONDITION PD	E TYPE A SERIES BREAKER MOUNTING S S RATING: 125 AMPS G ONLY	LOCATION: SQUAD RM 159  VOLTAGE: 208Y/120V, 3-PHASE, 4-WIRE  PANEL MOUNTING: RECESSED  PANEL ENCLOSURE (NEMA): 1  PANEL MIN. A. I. C. RATING: 10K													
CIR.	DESCRIPTION		CIR.	WIRE & CONDUIT		LOAD - VA				LOAD - VA	١	WIRE & CONDUIT	CIR.		DESCRIPTION	CIR.
No.	22000	NOTE	BKR.	***************************************	AØ	BØ	СØ		AØ	BØ	СØ		BKR.	NOTE		No.
1	LIGHT SQUAD RM		20/1	EXISTING				1				EXISTING	20/1		REC RADIO RM	2
3	LIGHT RADIO RM		20/1	EXISTING				┚				EXISTING	20/1		REC RADIO RM	4
5	LIGHT LOBBY		20/1	EXISTING								EXISTING	20/1		REC DOOR A LA RM	6
7	LIGHT LIEUTENANT'S OFFICE		20/1	EXISTING				1				EXISTING	20/1		REC RADIO RM	8
9	LIGHT ENTRANCE		20/1	EXISTING				]				EXISTING	20/1		REC RADIO RM	10
11	LIGHT SERGEANT'S OFFICE		20/1	EXISTING								EXISTING	20/2		HAND DRYER WOMEN'S LOCKER	12
13	LIGHT BACK ENTRANCE		20/1	EXISTING		1		1				EXISTING	"		"	14
15	LIGHT CORRIDOR		20/1	EXISTING			1				1	EXISTING	20/2		HAND DRYER MEN'S LOCKER	16
17	LIGHT WOMEN'S LOCKER RM		20/1	EXISTING	1			1				EXISTING	"		"	18
19	REC STONE RM		20/1	EXISTING		1		1		1		EXISTING	20/1		MXL	20
21	LIGHT MEN'S LOCKER RM		20/1	EXISTING			1				1	EXISTING	20/1		POD	22
23	LIGHT INTERROGATION RM		20/1	EXISTING	1			1				EXISTING	20/1		UNIT HEATER REAR ENTRANCE	24
25	REC SQUAD RM		20/1	EXISTING		1		1		1		EXISTING	20/1		SPARE WOMEN'S LOCKER CEILING	26
27	REC LOBBY		20/1	EXISTING			1				1	EXISTING	20/1		SPARE WAREHOUSE CEILING	28
29	REC INTERROGATION RM		20/1	EXISTING	1			1				EXISTING	20/1		SPARE COMMANDER'S CLOSET CEIL.	30
31	REC SERGEANT'S RM		20/1	EXISTING		1		1		1		EXISTING	20/1		SPARE FRONT ENTRANCE	32
33	REC MEN'S LOCKER RM		20/1	EXISTING			1				1		20/1		SPARE	34
35	REC WOMEN'S LOCKER RM		20/1	EXISTING	1			1					20/1		SPARE	36
37	REC RADIO SHELF		20/1	EXISTING		1		1					20/1		SPARE	38
39	REC RADIO SHELF		20/1	EXISTING			1				1	EXISTING	20/2		CIRCUIT TO FRONT PD ENTRANCE	40
41	SPARE		20/1		1			1				EXISTING	"		"	42
		•			0	0	0	1	0	0	0		_	•	•	
CONNE	CTED LOAD:			'	-	_	_	Х	ISOLATED	NEUTRAL B	SUS	-				
AØ	0.00 KVA							Х	EQUIPM EN	F GROUND E	BUS					
BØ	0.00 KVA	_						NO	TES:	GROUNDIN	G AND BOND	ING SHALL BEIN ACCO	RDANCE	NITH TI	HE NEC.	
сø	0.00 KVA	_														
TOTAL	0.00 KVA		0.00 A		-											
DM D	0.00 KVA	_	0.00 A		-											

#### **GENERAL SYMBOLS**

SPECIFIC DEMOLITION NOTE SPECIFIC NEW WORK NOTE

REVISION NUMBER TAG REVISION CLOUD

#### NORTH ARROW

**ELECTRICAL LEGEND** 



LIGHTING FIXTURE

EXIT SIGN, SINGLE OR DUAL FACE: CEILING MOUNTED; WALL MOUNT AT 7'-6" A.F.F. UNLESS NOTED OTHERWISE. PROVIDE WITH INTEGRAL HEADS. SHADING INDICATES NUMBER OF FACES.

SINGLE POLE SWITCH, MOUNT AT 46" A.F.F. U.N.O.

3-WAY SWITCH, MOUNT AT 46" A.F.F. U.N.O.

3-WAY KEYED SWITCH

DIMMER WITH 3-WAY SWITCH, MOUNT AT 46" A.F.F. U.N.O.

DIMMER, MOUNT AT 46" A.F.F. U.N.O.

COMBINATION TYPE WALL BOX OCCUPANCY/VACANCY SENSOR, MOUNT AT 46" A.F.F. U.N.O.

125V-20A DUPLEX RECEPTACLE, NEMA CONFIGURATION 5-20R, MOUNT AT 18" A.F.F. UNLESS NOTED OTHERWISE


125V-20A DUPLEX RECEPTACLE, NEMA CONFIGURATION 5-20R, MOUNT AT 9" ABOVE COUNTER UNLESS NOTED OTHERWISE

125V-20A QUAD RECEPTACLE, NEMA CONFIGURATION 5-20R, MOUNT AT 18" A.F.F. UNLESS NOTED OTHERWISE

125V-20A DUPLEX RECEPTACLE, NEMA CONFIGURATION 5-20R, MOUNT AT 18" A.F.F. UNLESS NOTED OTHERWISE G = GROUND FAULT CIRCUIT INTERRUPTER WP = WEATHERPROOF WHILE-IN-USE DIE-CAST ALUMINUM COVER

JUNCTION BOX OR DEVICE BOX



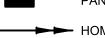

PANEL NAME

→ HOMERUN TO PANELBOARD:

ARROWS INDICATE QUANTITY OF CIRCUITS.

TYPE: SQUARE D TYPE NQ

NOTATION INDICATES PANELBOARD AND CIRCUIT NUMBER TO WHICH CIRCUITS ARE TO BE EXTENDED.

REVISION

DATE

DESCRIPTION

#### SUGGESTED CONSTRUCTION SEQUENCE

CONSTRUCTION SHALL BE IN A PHASED APPROACH, IN ORDER TO MAINTAIN CONTINUITY OF DISPATCH CENTER IN OPERATION. THE TWO MAJOR CONSTRUCTION PHASES ARE RENOVATE THE NON-RADIO ROOM SPACES WHILE KEEPING EXISTING DISPATCH EQUIPMENT IN RADIO ROOM SERVICE AND RENOVATE THE RADIO ROOM. COORDINATE AND SCHEDULE OUTAGES WITH THE AUTHORITY. THE FOLLOWING IS A SUGGESTED SEQUENCE OF GENERAL CONSTRUCTION ACTIVITIES:

- 1. INSTALL NEW PANEL PD AND TRANSFER REMAINING CIRCUITS TO PANEL. MAINTAIN EXISTING PANEL PD IN SERVICE UNTIL CIRCUITS HAVE BEEN TRANSFERRED.
- 2. INSTALL LIGHTING IN NEW CLOSET 155A.
- 3. INSTALL RECEPTACLES AND BOXES IN SQUAD ROOM FOR TEMPORARY WORKSTATION AND WALL-MOUNTED DISPLAYS.
- 4. REMOVE LIGHTING IN SPACE DESIGNATED AS NEW STORAGE 154A. INSTALL LIGHTING AND RECEPTACLE IN NEW STORAGE 154A. INSTALL NEW DISPATCH EQUIPMENT RACK (BY VENDOR).
- INSTALL TEMPORARY CABLING FROM DISPATCH EQUIPMENT RACK TO SQUAD ROOM (BY VENDOR).
- INSTALL DATA CABLING FROM EXISTING IT EQUIPMENT TO DISPATCH EQUIPMENT RACK AND TO TEMPORARY WORKSTATION (BY AUTHORITY IT DEPARTMENT).
- PERFORM TESTING AND CUTOVER TO TEMPORARY WORKSTATION AND WALL-MOUNTED
- PERFORM DEMOLITION WORK IN AREAS DESIGNATED AS PHASE 1, EXCEPT FOR NEW STORAGE
- 154A THAT DEMOLITION WORK WAS DONE IN PREVIOUS STEP ABOVE.
- PERFORM RENOVATION WORK IN AREAS DESIGNATED AS PHASE 1, EXCEPT FOR NEW STORAGE 154A THAT DEMOLITION WORK WAS DONE IN PREVIOUS STEP ABOVE.
- 10. PERFORM DEMOLITION WORK IN RADIO ROOM 154 THAT IS DESIGNATED AS PHASE 2.
- 11. PERFORM RENOVATION WORK IN RADIO ROOM 154 THAT IS DESIGNATED AS PHASE 2.
- 12. INSTALL RECEPTACLES AND BOXES IN RADIO ROOM 154 FOR BOTH WORKSTATIONS AND WALL-MOUNTED DISPLAY.
- 13. RELOCATE WORKSTATION AND DISPLAY FROM SQUAD ROOM TO RADIO ROOM 154 (BY VENDOR)
- 14. ASSIST VENDOR AND AUTHORITY FOR REMOVAL OF TEMPORARY CABLING AND SUPPORTS. REMOVE TEMPORARY RECEPTACLES AND BOXES.
- 15. INSTALL LOW-VOLTAGE CABLING FOR DISPATCH EQUIPMENT, WORKSTATIONS, AND
- WALL-MOUNTED DISPLAY (BY VENDOR AND AUTHORITY IT DEPARTMENT).
- 16. PERFORM WALL/CEILING REPAIRS AND CLEANUP.

	NEW		CIRCUIT	BREAKER MOUNTING	SPACE: 42 VOLTAGE: 208Y/120V, 3-PHASE, 4-WIRE											
	DD		MAIN BU	IS RATING: 125 AMPS							PANEL MC	OUNTING: RECESSED				
	PD		MAIN LU	GONLY							PANEL EN	CLOSURE (NEMA): 1				
											PANEL MIN	N. A. I. C. RATING: 10K				
CIR.			CIR.			LOAD - VA		Г		LOAD - VA			CIR.			CIR.
No.	DESCRIPTION	NOTE	BKR.	WIRE & CONDUIT	AØ	BØ	СØ	1	AØ	BØ	СØ	WIRE & CONDUIT	BKR.	NOTE	DESCRIPTION	No.
1	LIGHT SQUAD RM	2	20/1	2#12, 1#12G IN 1"C	270			1	480			2#12, 1#12G IN 1"C	20/1	2	REC RADIO RM WORKSTATION	2
3	LIGHT RADIO RM	2	20/1	2#12, 1#12G IN 1"C		270		ı		480	1	2#12, 1#12G IN 1"C	20/1	2	REC RADIO RM WORKSTATION	4
5	LIGHT LOBBY	1	20/1	EXTEND EXISTING			300	1			100	EXTEND EXISTING	20/1	1	REC DOOR ALARM	6
7	LIGHT LIEUTENANT'S OFFICE	1	20/1	EXTEND EXISTING	232			1	180			2#12, 1#12G IN 1"C	20/1	2	REC RADIO RM INTERCOM	8
9	LIGHT ENTRANCE	1	20/1	EXTEND EXISTING		100		ı		360	1	2#12, 1#12G IN 1"C	20/1	2	REC RADIO RM	10
11	LIGHT SERGEANT'S OFFICE	1	20/1	EXTEND EXISTING			232	1			480	EXTEND EXISTING	20/2	1	HAND DRYER WOMEN'S LOCKER	12
13	LIGHT BACK ENTRANCE	1	20/1	EXTEND EXISTING	100			1	480			EXTEND EXISTING	"	1	"	14
15	LIGHT CORRIDOR	1	20/1	EXTEND EXISTING		580		ı		480	1	EXTEND EXISTING	20/2	1	HAND DRYER MEN'S LOCKER	16
17	LIGHT WOMEN'S LOCKER RM	1	20/1	EXTEND EXISTING			232	1			480	EXTEND EXISTING	"	1	"	18
19	REC STONE RM	1	20/1	EXTEND EXISTING	180			1	200			EXTEND EXISTING	20/1	1	MXL	20
21	LIGHT MEN'S LOCKER RM	1	20/1	EXTEND EXISTING		232		ı		720		EXTEND EXISTING	20/1	1	POD	22
23	LIGHT INTERROGATION RM	1	20/1	EXTEND EXISTING			100	1			1500	EXTEND EXISTING	20/1	1	UNIT HEATER REAR ENTRANCE	24
25	REC SQUAD RM	2	20/1	2#12, 1#12G IN 1"C	360			1	180			EXTEND EXISTING	20/1	1	SPARE WOMEN'S LOCKER CEILING	26
27	REC LOBBY	1	20/1	EXTEND EXISTING		180		ı		180		EXTEND EXISTING	20/1	1	SPARE WAREHOUSE CEILING	28
29	REC INTERROGATION RM	1	20/1	EXTEND EXISTING			180	1			180	EXTEND EXISTING	20/1	1	SPARE COMMANDER'S CLOSET CEIL.	30
31	REC SERGEANT'S RM	1	20/1	EXTEND EXISTING	720			1	180			EXTEND EXISTING	20/1	1	SPARE FRONT ENTRANCE	32
33	REC MEN'S LOCKER RM	1	20/1	EXTEND EXISTING		180		ı		720		2#12, 1#12G IN 1"C	20/1	2	REC CLOSET 164, SQUAD RM	34
35	REC WOMEN'S LOCKER RM	1	20/1	EXTEND EXISTING			180	1			480	2#12, 1#12G IN 1"C	20/1	2	REC RADIO ROOM DISPLAYS	36
37	REC RADIO CHARGER	2	20/1	2#12, 1#12G IN 1"C	540			1					20/1	1	SPARE	38
39	REC RADIO CHARGER	2	20/1	2#12, 1#12G IN 1"C		540		1		500		EXTEND EXISTING	20/2	1	CIRCUIT TO FRONT PD ENTRANCE	40
41	SPARE	1	20/1								500	EXTEND EXISTING		1	"	42
					2402	2082	1224	L	1700	3440	3720					
CONNE	CTED LOAD:							Х	ISOLATED	NEUTRAL BI	US					
AØ	4.10 KVA	_						Х	EQUIPM ENT	GROUND B	SUS					
BØ	5.52 KVA							NO	TES:	GROUNDING	G AND BOND	ING SHALL BEIN ACCOR	RDANCEW	ITH TI	HE NEC. BALANCE ALL PHASES.	
cø	4.94 KVA	<del>-</del>						1.	EXISTING L	OAD. EXTE	ND EXISTING	CIRCUIT TO NEW LOCA	TION.			
TOTAL	14.57 KVA		40.44 A		2. PROVIDE NEW CONNECTION.											
חשם	9.47 K\/A	-	26 28 A													

LOCATION: HALL 157



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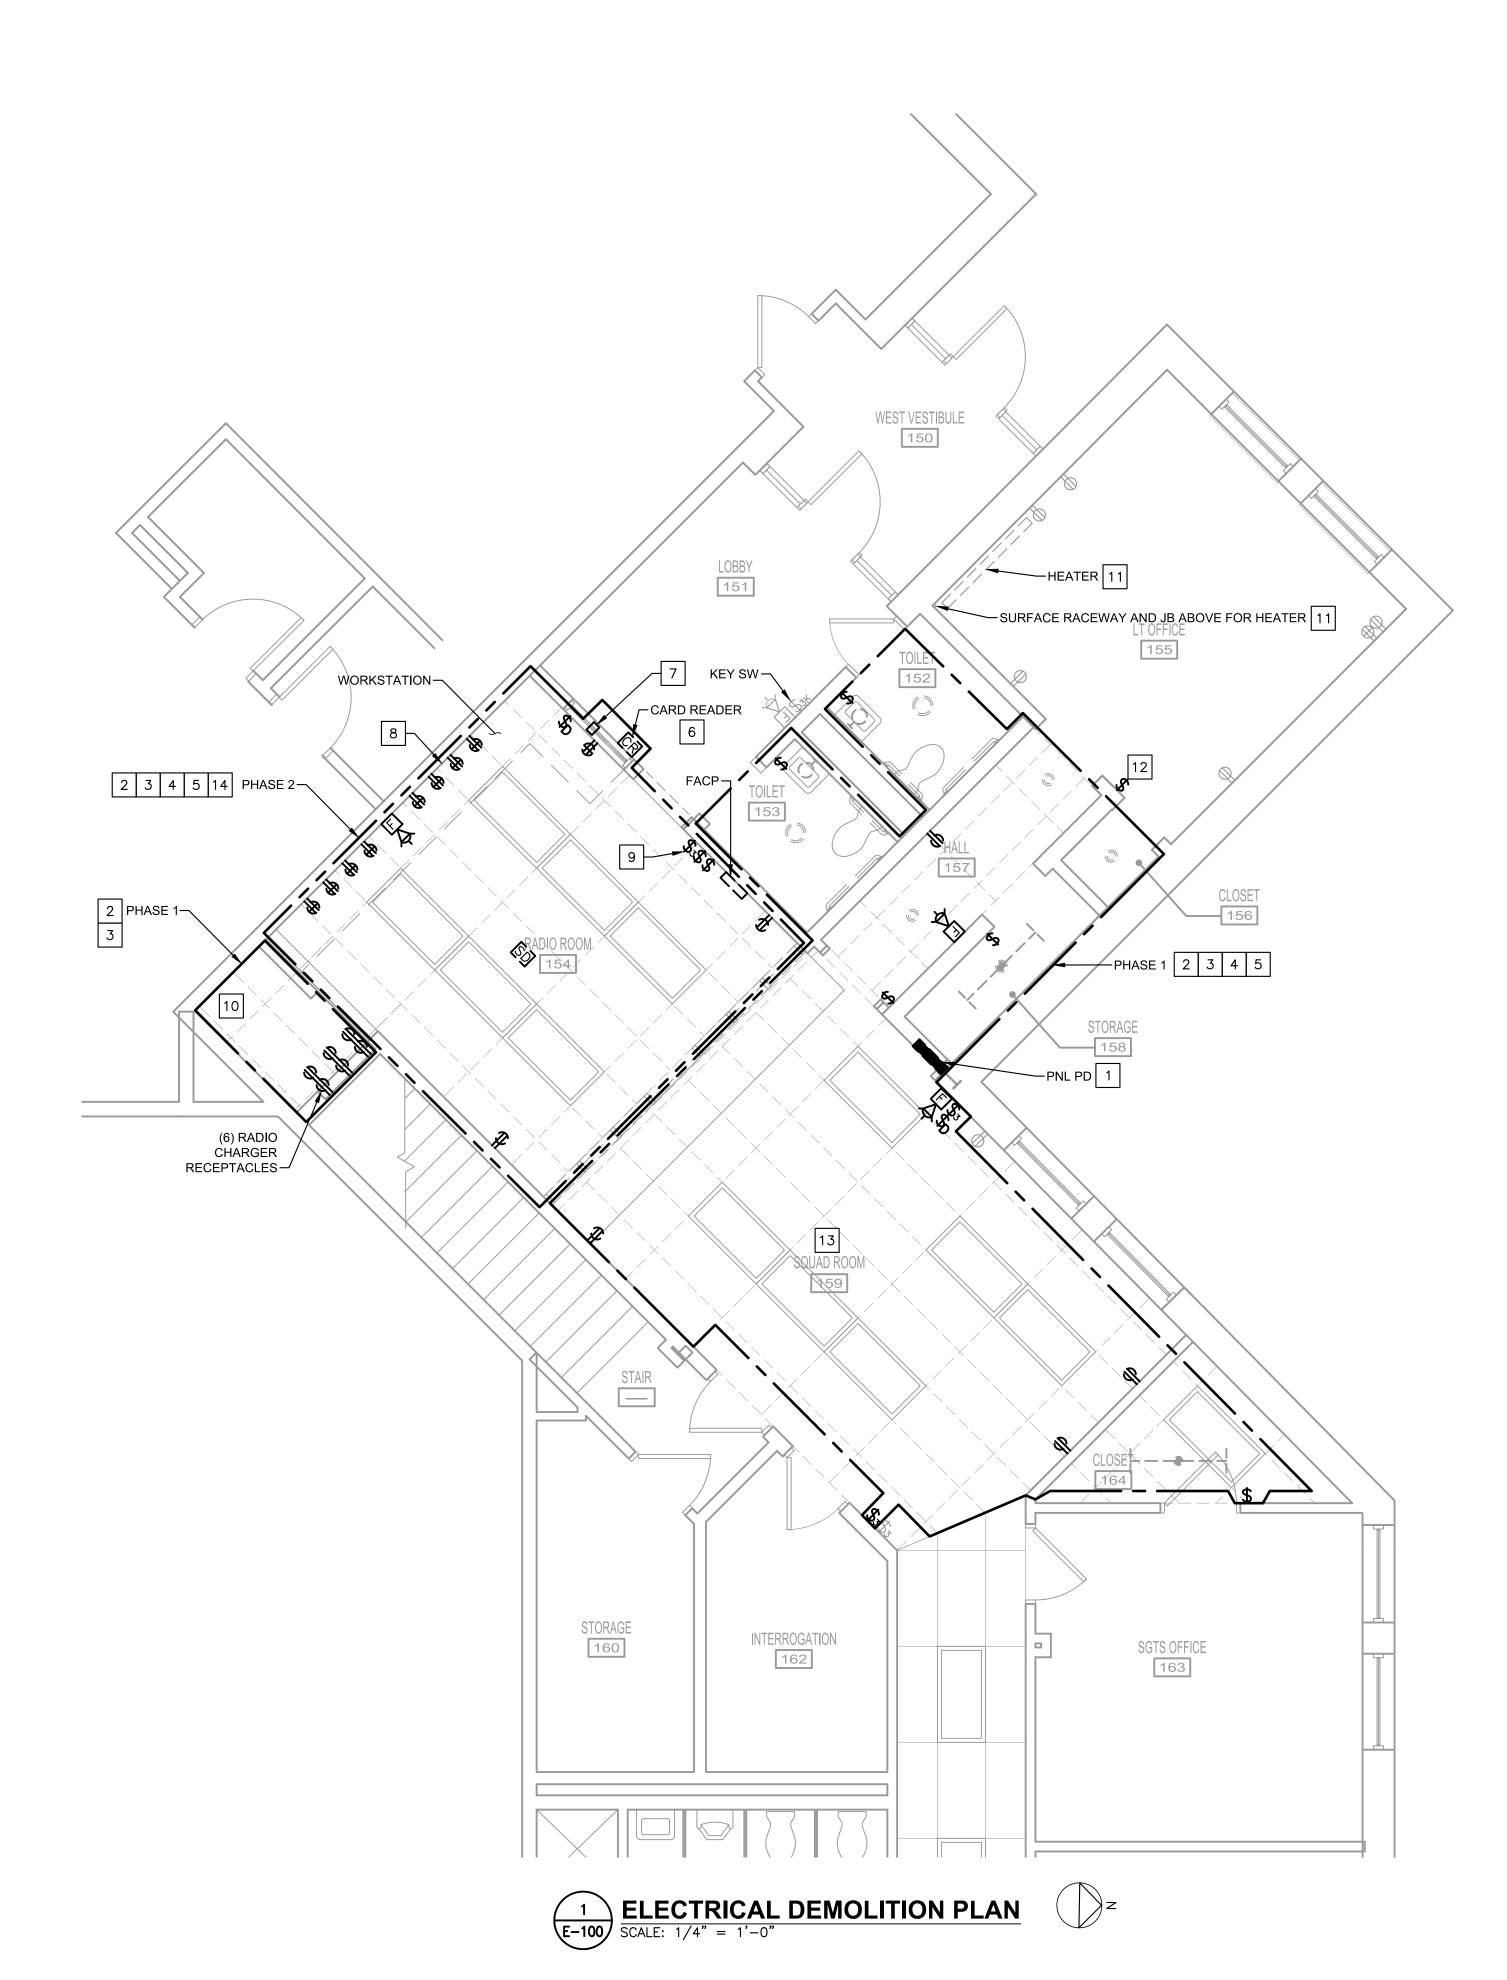
GENERAL	NOTES
SYMBOLS	AND
ABBREVIA	TIONS

E-000

SCALE: AS NOTED

SHEET NO.

DATE: JANUARY 2022





-PROJECT AREA



REVISION



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RICAL DEMOLITION PLAN

**DRAWING NOTES:** 

DEVICES SHALL REMAIN.

EQUIPMENT DEMOLITION WORK.

BACK TO SOURCE.

1. UNLESS NOTED OTHERWISE, EXISTING LIGHTING, EQUIPMENT, AND

4. MAINTAIN CIRCUIT CONTINUITY FOR REMAINING RECEPTACLES AND LIGHTING FIXTURES THAT ARE ON THE SAME CIRCUITS WITH THOSE

REFERENCED NOTES (APPLY TO THIS

TO ALLOW FOR RECONNECTION TO NEW PANEL.

WIRING AND CONDUITS BACK TO SOURCE.

ASSOCIATED CABLING BY OTHERS.

ASSOCIATED CABLING BY OTHERS.

LOBBY LIGHTING IN OPERATION.

DEMOLITION.

ONCE NEW PANEL IS INSTALLED, DISCONNECT AND REMOVE PANEL PD. PULL REMAINING WIRING UP TO ACCESSIBLE CEILING

DISCONNECT AND REMOVE LIGHTING FIXTURES. REMOVE

ASSOCIATED LIGHT SWITCHES. REMOVE WIRING AND CONDUITS

DISCONNECT AND REMOVE RECEPTACLES. REMOVE ASSOCIATED

DISCONNECT AND REMOVE LOW-VOLTAGE JACKS. REMOVE ASSOCIATED CABLING AND CONDUITS BACK TO SOURCE.

RELOCATION WORK FOR FIRE ALARM CONTROL PANEL AND

DEMOLITION WORK FOR CARD READER, DOOR LOCK, DOOR RELEASE BUTTON, AND ASSOCIATED CABLING BY OTHERS.

DEMOLITION WORK FOR INTERCOM SYSTEM ON WINDOW AND

TEMPORARILY MAINTAIN DISPATCH EQUIPMENT OPERATION UNTIL CUT OVER TO TEMPORARY WORKSTATION IN SQUAD ROOM.

THIS SWITCH IS WORKING IN CONJUNCTION WITH KEY SWITCH IN LOBBY FOR LOBBY LIGHTING. DISCONNECT, REMOVE, AND

DISCONNECT ELECTRIC BASEBOARD HEATER. DETACH FIN TUBE BASEBOARD RADIATION'S CONTROL CABLING SUPPORTED ON THE ELECTRIC BASEBOARD HEATER'S SURFACE RACEWAY. REMOVE

DISCONNECT AND REMOVE LIGHT SWITCH. RETAIN WIRING FOR RECONNECTION. PROTECT WIRING DURING PARTIAL WALL

VENDOR TO PREPARE THIS AREA FOR TEMPORARY WORKSTATION

REMOVE WIRING AND CONDUITS FOUND UNDER RAISED FLOOR. REROUTE ANY REMAINING CIRCUIT VIA WALLS AND ACCESSIBLE

COORDINATE WITH AUTHORITY AND DISPATCH EQUIPMENT

INSTALLED NEW SWITCH SHOWN ON LIGHTING PLAN TO KEEP

COORDINATE WITH AUTHORITY AND DISPATCH EQUIPMENT VENDOR TO PREPARE THIS AREA FOR NEW EQUIPMENT RACK.

ELECTRIC BASEBOARD HEATER'S WIRING AND SURFACE RACEWAY BACK TO JUNCTION BOX MOUNTED HIGH ON WALL.

COORDINATE WITH MECHANICAL TO REROUTE FIN TUBE

BASEBOARD RADIATION'S CONTROL CABLING.

AND WALL-MOUNTED DISPLAY INSTALLATION.

2. COORDINATE ELECTRICAL DEMOLITION WORK WITH HVAC

3. COORDINATE AND SCHEDULE WITH AUTHORITY FOR ANY

THAT ARE INDICATED TO BE DEMOLISHED.

DRAWING WHERE INDICATED):

DATE: JANUARY 2022 SCALE: AS NOTED SHEET NO.

GRAPHIC SCALE 1/4" = 1'-0"

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E-100

#### **DRAWINGS NOTES:**

- 1. COORDINATE WITH CEILING INSTALLATION.
- 2. CONNECT EXIT SIGNS TO THE SAME CIRCUIT SERVING AREAS AHEAD OF ANY SWITCHING DEVICES.

#### SPECIFIC NOTES (APPLY TO THIS DRAWING WHERE INDICATED):

- (1) CONNECT TO CONTROL EXISTING LOBBY LIGHTING FIXTURES.
- (2) CONNECT TO EXISTING LOBBY LIGHTING CIRCUIT INDICATED.
- (3) CONNECT TO EXISTING LT OFFICE'S LIGHTING CIRCUIT INDICATED.
- CONNECT TO EXISTING SGTS OFFICE'S LIGHTING CIRCUIT INDICATED.
  - CONNECT TO EXISTING RADIO ROOM'S LIGHTING CIRCUIT INDICATED.
  - PROVIDE LIGHT SWITCH AND CONNECT TO EXISTING CIRCUIT WIRING.
- PROVIDE DOUBLE GANG WALL PLATE FOR NEW DIMMER AND EXISTING LIGHT SWITCH.

					LIG	HTING	FIXTURE	SCHEDULE		
TYPE	DESCRIPTION	VOLTS	LAMP TYPE	WATTS	LUMENS	KELVIN	MOUNTING	MANUFACTURER	MODEL SERIES	REMARKS/ACCESSORIES
Α	2' X 4' LED CENTER RECTANGULAR BASKET, 80+ CRI, 0-10V DIMMING, IC/PLENUM/AIR RETURN RATED	UNV 120-277	LED	36.2	4276	3500	RECESSED	DAYBRITE	FG FLUXGRID SERIES	PROVIDE COMPATIBLE DIMMERS.
В	2' X 4' FLAT PANEL LED, 80+ CRI, 0-10V DIMMING, IC/PLENUM/AIR RETURN RATED	UNV 120-277	LED	38	4118	3500	RECESSED	LITHONIA OR DAYRITE	EPANL LED SERIES OR FXP FLUXPANEL LED SERIES	
DL	6" ROUND LED DOWNLIGHT, SPECULAR REFLECTOR, WHITE FLANGE, 0-10V DIMMING, IC/PLENUM/AIR RETURN RATED	UNV 120 <b>-</b> 277	LED	21	2000	3500	RECESSED	LIGHTOLIER	LYTEPROFILE SERIES	
X1	LED COMBO EXIT SIGN WITH DUAL HEADS, SINGLE-FACE, NI-CAD BATTERY, SELF-DIAGNOSTICS, CHEVRONS	120	LED	4.3	-	-	WALL SURFACE	LITHONIA	LHQM LED SERIES	
X2	LED COMBO EXIT SIGN WITH DUAL HEADS, DOUBLE-FACE, NI-CAD BATTERY, SELF-DIAGNOSTICS, CHEVRONS	120	LED	4.3	-	-	CEILING SURFACE	LITHONIA	LHQM LED SERIES	

#### LIGHTING FIXTURE SCHEDULE GENERAL NOTES:

DATE

- 1. LETTER AT LIGHTING FIXTURE IS THE FIXTURE TYPE. NL = NIGHT LIGHT THAT CONNECTED AHEAD OF SWITCHING DEVICES.
- 2. ALL LIGHTING FIXTURES SHALL BE INSTALLED IN ACCORDANCE WITH LOCAL JURISDICTION REQUIREMENTS, IN STRICT ACCORDANCE WITH NEC ARTICLE 410, AND SHALL PROPERLY AND SUITABLY SUPPORT THE WEIGHT OF ANY FIXTURE INSTALLED.
- 3. MANUFACTURERS LISTED ARE BASIS OF DESIGN. IF OTHER THAN BASIS OF DESIGN MANUFACTURERS ARE SUBMITTED, PROVIDE FIXTURE CUTSHEETS AND EXPLANATION OF DIFFERENCES BETWEEN BASIS OF DESIGN AND PROPOSED ALTERNATE FIXTURE. ALL NON BASIS OF DESIGN SUBMITTED FIXTURES ARE SUBJECT TO REVIEW AND APPROVAL BY THE ENGINEER.





REVISION

DESCRIPTION



DELAWARE RIVER AND BAY AUTHORITY CAPE MAY - LEWES FERRY

CONTRACT NO. CMLF-C19-06 TERMINAL POLICE AND ADMINISTRATION BUILDING - DISPATCH CENTER REHAB

LIGHTING	ΡΙΔΝ


E-101

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WEST VESTIBULE
150

LOBBY


STORAGE 160


LIGHTING PLAN
SCALE: 1/4" = 1'-0"

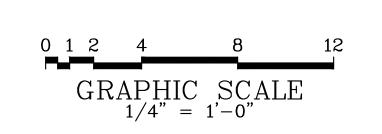
INTERROGATION 162


#### **DRAWING NOTES:**

- 1. REFER TO PHASE 1 AND PHASE 2 PLANS FOR SPECIFIC NOTES.
- 2. REFER TO E-105 FOR SECURITY ACCESS SYSTEM REQUIREMENTS.

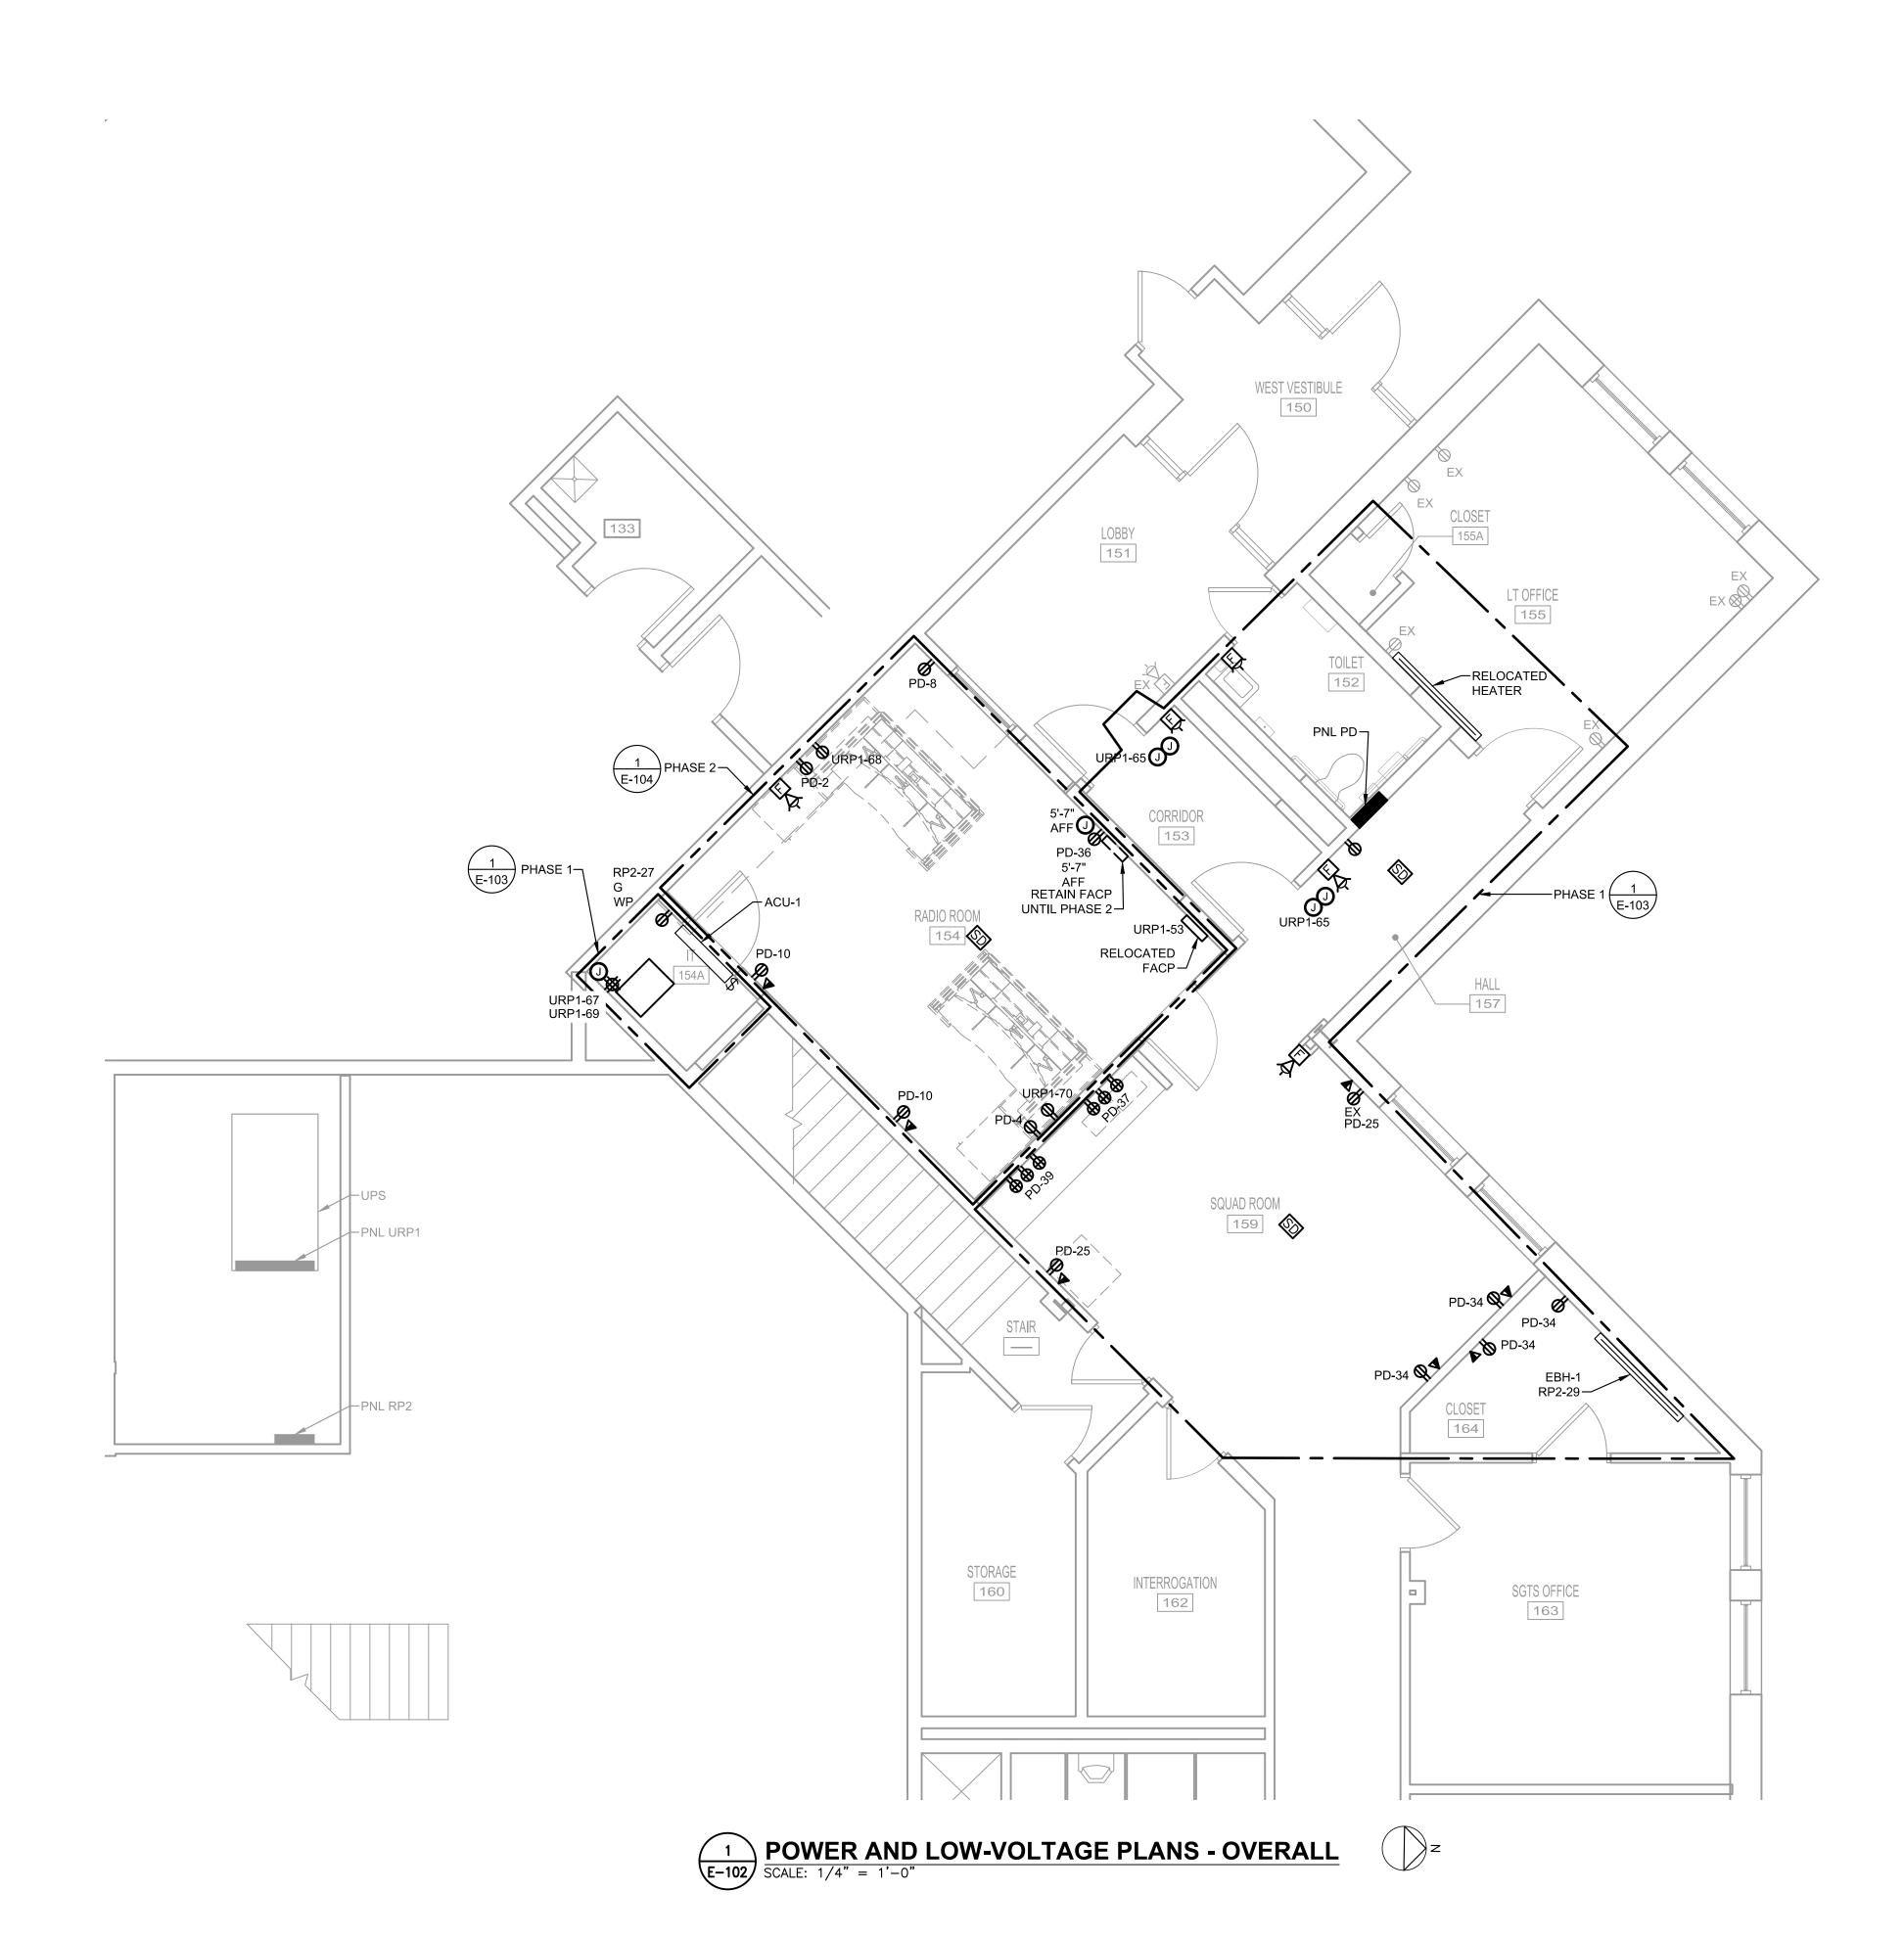

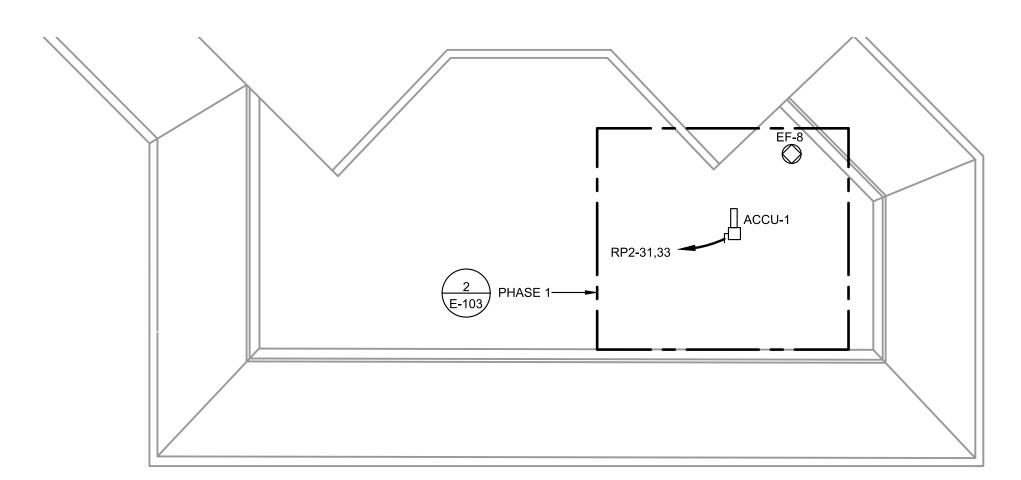

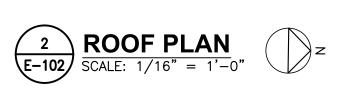

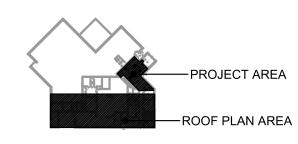







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CONTRACT NO. CMLF-C19-06 TERMINAL POLICE AND ADMINISTRATION BUILDING - DISPATCH CENTER REHAB

POWER AND LOW-VOLTAGE PLANS -

E-102 OVERALL DATE: JANUARY 2022 SCALE: AS NOTED SHEET NO. 22




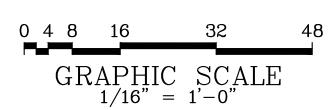

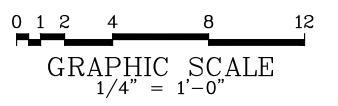
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#### SPECIFIC NOTES (APPLY TO THIS DRAWING WHERE INDICATED):

- TRANSFER ALL EXISTING CIRCUITS TO THIS PANEL PRIOR TO REMOVING EXISTING PANEL. INTERCEPT EXISTING FEEDER AND BRANCH CIRCUITS WITH JUNCTION BOXES ABOVE ACCESSIBLE CEILING. PROVIDE WIRING AND CONDUITS TO EXTEND CIRCUITS TO THIS PANEL. COORDINATE WITH DUCTWORK AND PIPING INSTALLATIONS.
- RECESSED BOX WITH CABLE-THROUGH COVER PLATE FOR WALL-MOUNTED DISPLAY. FIELD VERIFIED AND COORDINATE EXACT LOCATION AND MOUNTING HEIGHT WITH DISPATCH EQUIPMENT VENDOR (ACTIVU).
- REPLACE RECEPTACLE AND COVER PLATE.
- CONNECT TO EXISTING RECEPTACLE CIRCUIT SERVING THE AREA. EXTEND EXISTING CIRCUIT WIRING AS REQUIRED.
- 5 PROVIDE PULL BOX FOR DATA CABLING.
- PROVIDE POWER AND SECURITY BOXES ABOVE ACCESSIBLE CEILING FOR DOOR SECURITY SYSTEM CONNECTIONS.
- UTILIZE EXITING RECEPTACLES FOR TEMPORARY WORKSTATION AND WALL-MOUNTED DISPLAY. WORKSTATION AND WALL-MOUNTED DISPLAYS SHALL BE RELOCATED TO RADIO ROOM IN PHASE 2. COORDINATE ALL WORKS WITH AUTHORITY AND DISPATCH EQUIPMENT VENDOR.
- ALL CABLING SHALL BE PROVIDED BY DISPATCH EQUIPMENT VENDOR.
- CONNECT INDOOR UNIT TO OUTDOOR UNIT WITH 3#12, 1#12G IN3/4"C VIA
- CONNECT DISPATCH EQUIPMENT RACK'S RECEPTACLES AND DOOR SECURITY EQUIPMENT TO EXISTING 20A/1P CIRCUIT BREAKERS INDICATED. UPDATE CIRCUIT DIRECTORY.
- CONNECT CONDENSATE PUMP RECEPTACLE AND EBH-1 TO EXISTING 20A/1P CIRCUIT BREAKERS INDICATED. PROVIDE 30A/2P CIRCUIT BREAKER IN AVAILABLE SLOTS FOR OUTDOOR UNIT ACCU-1. UPDATE CIRCUIT
- TEMPORARILY MAINTAIN EXISTING WORKSTATION AND WALL-MOUNTED DISPLAYS OPERATIONAL UNTIL CUTOVER.
- DISCONNECT EXISTING TO ALLOW FOR FAN REPLACEMENT. REPLACE EXISTING WIRING BACK TO PANEL P IN ELECTRICAL ROOM BELOW. WIRING SHALL BE 3#12, 1#12G IN EXISTING 3/4" CONDUIT. CONNECT TO MECHANICAL PROVIDED DISCONNECT AND DRIVE IN ACCORDANCE WITH MANUFACTURER'S INSTRUCTIONS.
- EXTEND EXISTING CIRCUIT IN JUNCTION BOX TO RELOCATED ELECTRIC BASEBOARD HEATER WITH 2#12, 1#12G IN METAL SURFACE RACEWAY.
- PROVIDE TEMPORARY 20A POWER STRIP WITH (6) RECEPTACLES FOR RADIO CHARGERS. COORDINATE WITH OWNER FOR EXACT LOCATION.
- REINSTALLATION OF FIRE ALARM DEVICE / APPLIANCE AND ASSOCIATED CABLING BY OTHERS.
- FIRE ALARM DEVICE AND ASSOCIATED CABLING BY OTHERS.
- 18 FIRE ALARM STROBE AND ASSOCIATED CABLING BY OTHERS.
- COORDINATE WITH DISPATCH EQUIPMENT VENDOR TO REQUIRE 36" CLEARANCE FROM FRONT AND 24" CLEARANCE ON ON SIDE.



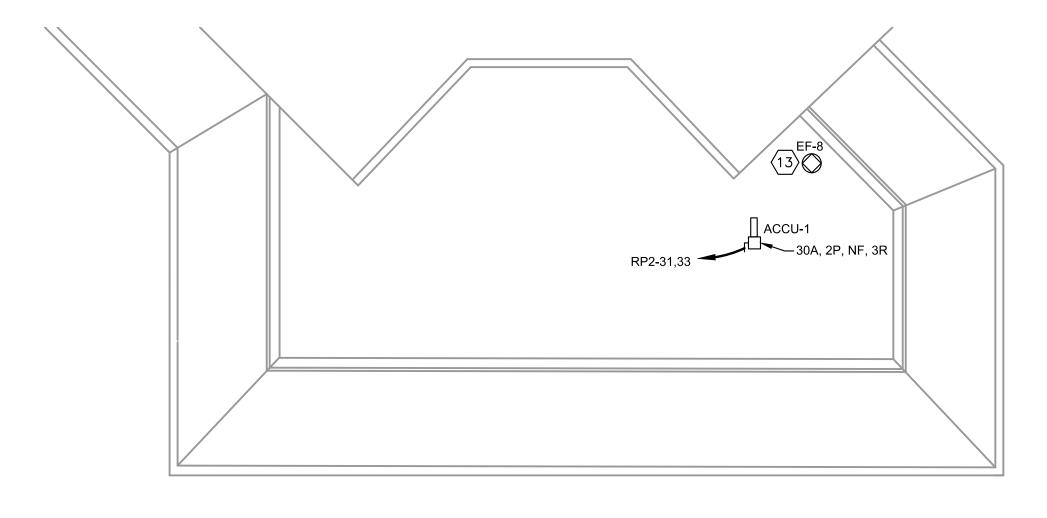

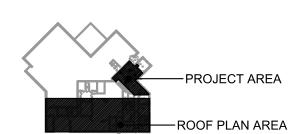



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2 ROOF PLAN SCALE: 1/16" = 1'-0"

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E-103

SHEET NO. 23

POWER AND
LOW-VOLTAGE PLANS
PHASE 1

SCALE: AS NOTED

DATE: JANUARY 2022

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153 19 DISPATCH EQUIP. RACK RETAIN FACP UNTIL PHASE 2 URP1-69 PREFERRED FRONT  $\nearrow$  TEMPORARY WORKSTATION  $\langle 7 \rangle$ -PNL URP1 (10) TEMPORARY
WALL-MOUNTED
DISPLAYS— 8 TEMPORARY ROUTING
FOR DISPATCH
EQUIPMENT CIRCUITS RP2-29 — PNL RP2 (11) CLOSET 164 STORAGE 160 INTERROGATION 162 SGTS OFFICE 163

GRAPHIC SCALE 1/16" = 1'-0"

POWER AND LOW-VOLTAGE PLANS - PHASE 1

| E-103 | SCALE: 1/4" = 1'-0"

WEST VESTIBULE 150

151

GRAPHIC SCALE 1/4" = 1-0"

EX 🛞

155

-RELOCATED $\langle 14 \rangle$ 

HEATER

#### SPECIFIC NOTES: (APPLY TO THIS DRAWING WHERE INDICATED):

- INSTALL RECEPTACLES FOR THIS WORKSTATION PRIOR TO REMOVING EXISTING WORKSTATION.
- RECESSED BOX WITH CABLE-THROUGH COVER PLATE FOR WALL-MOUNTED DISPLAY. FIELD VERIFIED AND COORDINATE EXACT LOCATION AND MOUNTING HEIGHT WITH DISPATCH EQUIPMENT VENDOR.
- ONCE EXISTING WORKSTATION REMOVED, INSTALL RECEPTACLES FOR THIS RELOCATED WORKSTATION FROM SQUAD ROOM.
- CONNECT WORKSTATION'S RECEPTACLES TO EXISTING 20A/1P CIRCUIT BREAKERS INDICATED. UPDATE CIRCUIT DIRECTORY.
- RELOCATE TEMPORARY WORKSTATION TO RADIO ROOM.
- (6) RELOCATE DISPLAYS TO RADIO ROOM.
- 7 REMOVE TEMPORARY CABLING.
- RELOCATION WORK FOR FIRE ALARM CONTROL PANEL AND ASSOCIATED CABLING BY OTHERS.





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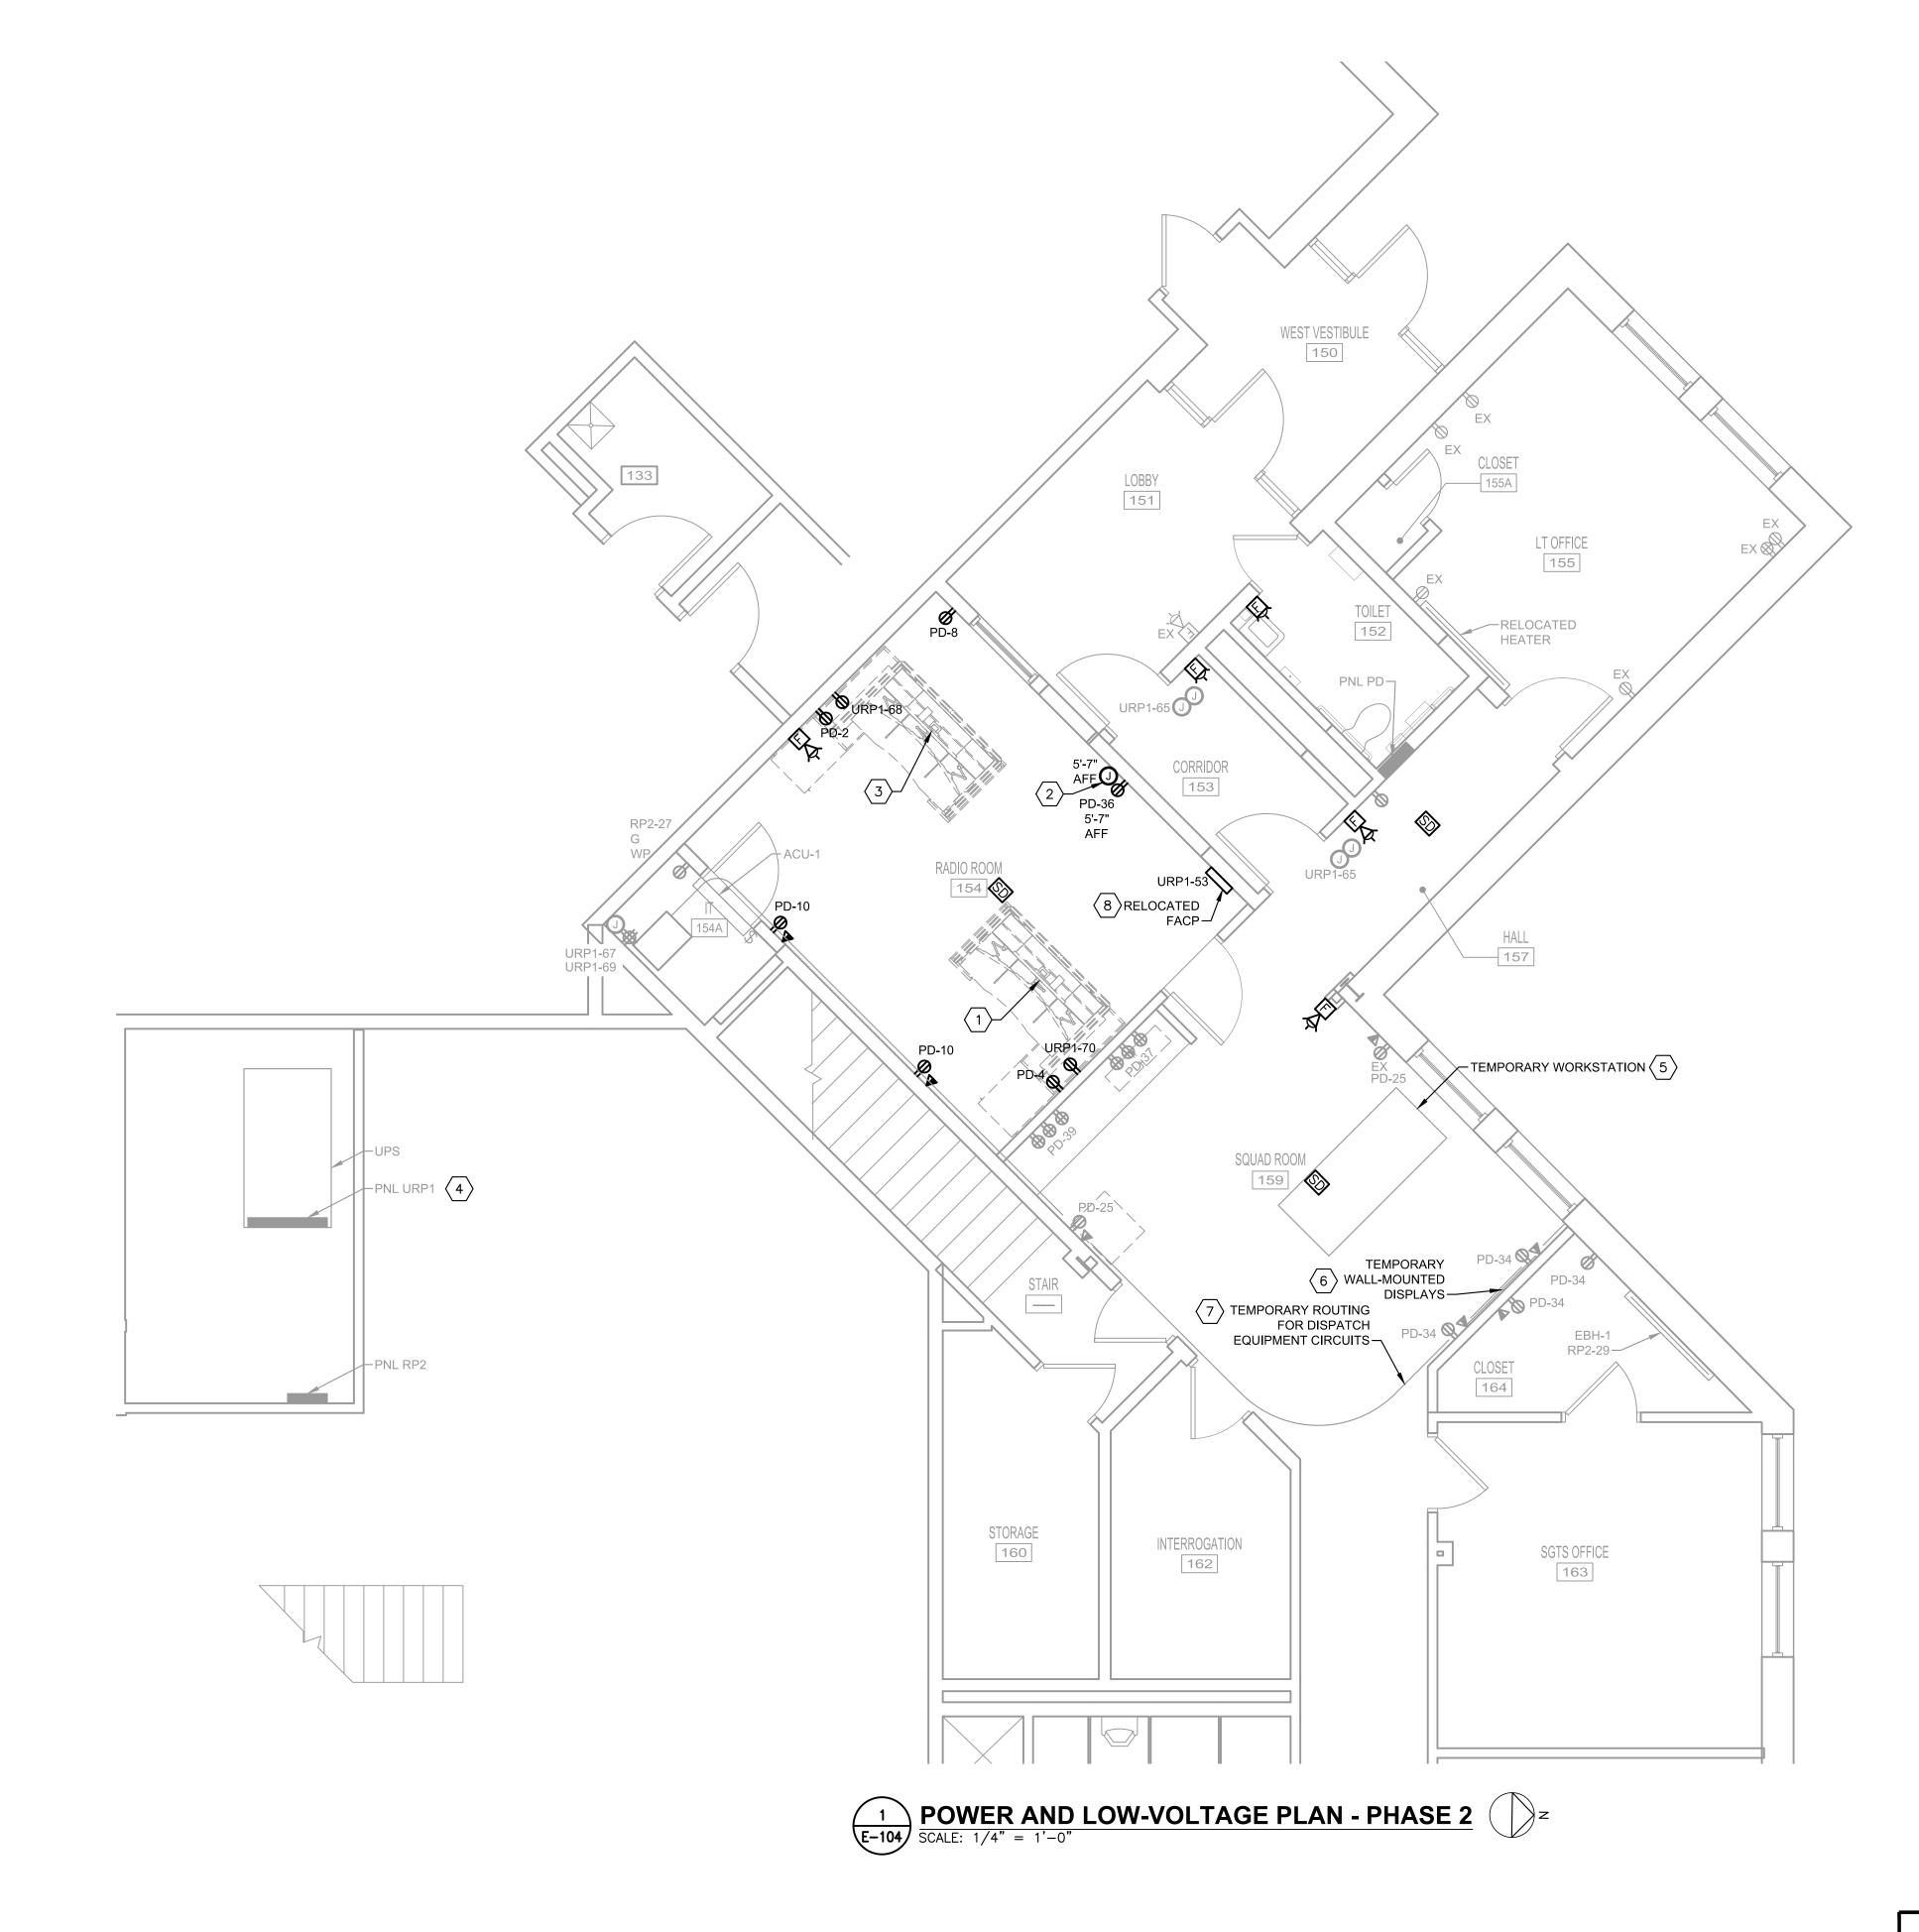
POWER AND
LOW-VOLTAGE PLAN
PHASE 2

DATE: JANUARY 2022

E-104

SCALE: AS NOTED

SHEET NO.






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DESCRIPTION

GRAPHIC SCALE 1/4" = 1'-0"

	NO.	DATE	
12			

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**SECURITY ACCESS LEGEND** 

CARD READER

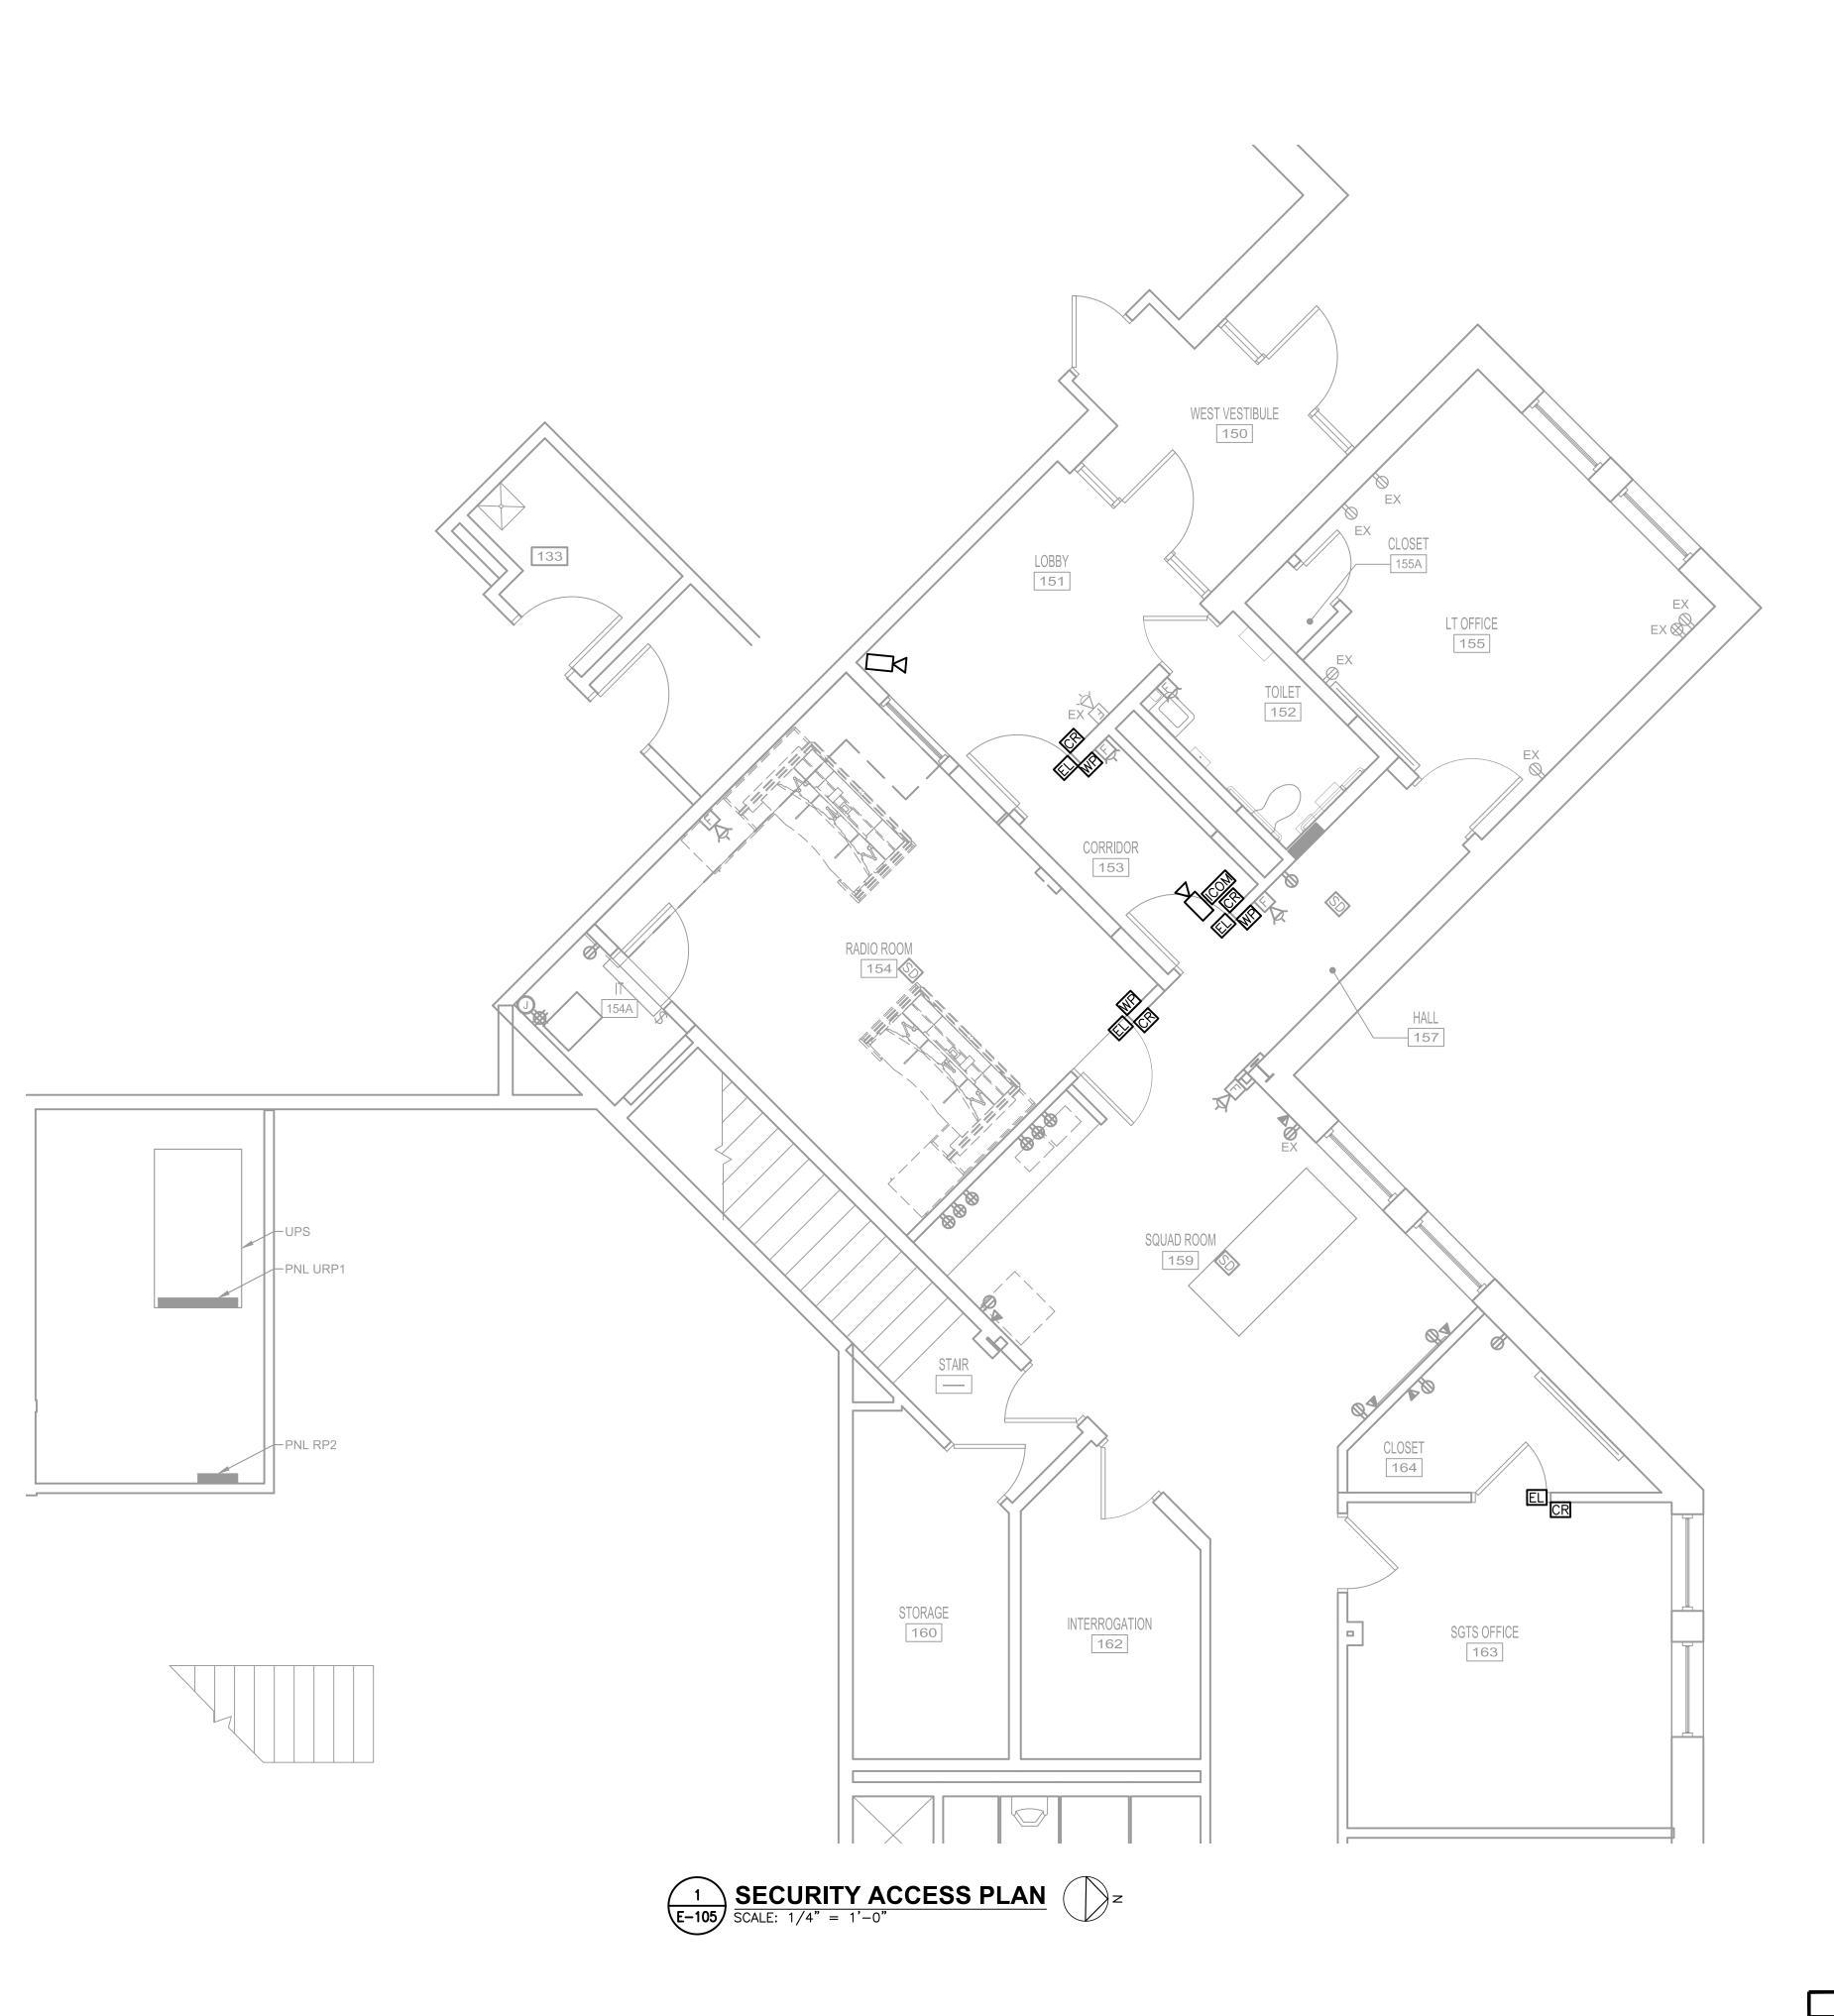
WAVE PLATE

ELECTRIC LOCK / STRIKE

VIDEO INTERCOM SYSTEM WITH CAMERA, MICROPHONE AND SPEAKER

☐☐☐☐ IP CAMERA, DOME TYPE

SECURITY ACCESS SYSTEM COMPONENTS, RELATED CABLING AND CONDUITS ARE BY OTHERS.

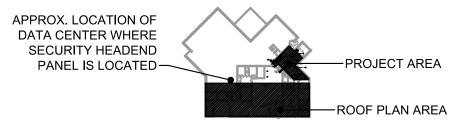



REVISION

DATE

DESCRIPTION



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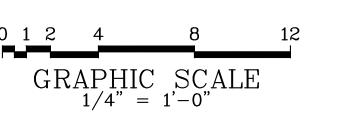
SECURITY ACCESS PLAN

E-105

SHEET NO. 25

DATE: JANUARY 2022

SCALE: AS NOTED



#### **GENERAL NOTES** (APPLY TO WORK PROVIDED UNDER DIV. 20):

- GENERAL: FURNISH LABOR, EQUIPMENT AND MATERIALS NECESSARY FOR THE INSTALLATION OF THE COMPLETE MECHANICAL SYSTEMS AS SPECIFIED HEREIN AND INDICATED IN THE CONTRACT DOCUMENTS. OUTLINE DESCRIPTION AND DIAGRAMMATIC REPRESENTATION OF SYSTEM OPERATION AND EQUIPMENT DOES NOT LIMIT CONTRACTOR LIABILITY FOR FURNISHING AND INSTALLING COMPLETE AND OPERABLE SYSTEMS.
- 2. APPLICABLE CODES: THE INSTALLATION SHALL COMPLY WITH THE LATEST EDITION OF THE CODE OF THE LOCAL AUTHORITY HAVING JURISDICTION.
- 3. NOTE DEFINITIONS: "DRAWING NOTES" APPLY TO THE ENTIRE DRAWING ON WHICH THEY APPEAR, WHERE RELEVANT. SPECIFIC NOTES" APPLY ONLY WHERE INDICATED WITH THE "SPECIFIC NOTE" SYMBOL. REFER TO LEGEND.
- 4. DUCTWORK TO BE SHEET METAL UNLESS NOTED OTHERWISE.
- 5. PROVIDE REQUIRED CLEARANCE FOR MAINTENANCE IN ACCORDANCE WITH MANUFACTURERS RECOMMENDATIONS OR AS REQUIRED BY CODE FOR MECHANICAL EQUIPMENT.
- 6. VERIFY THAT EXISTING EQUIPMENT THAT IS TO REMAIN IS FULLY FUNCTIONAL AND OPERATIONAL.
- 7. PERMITS: INCLUDE IN THE BID PRICE THE PAYMENT OF NECESSARY PERMITS. FURNISH THE OWNER PRIOR TO THE FINAL PAYMENT A CERTIFICATE FROM THE INSPECTION DEPARTMENT HAVING JURISDICTION CERTIFYING THAT THE WORK MEETS THE REQUIREMENTS OF THE LOCAL INSPECTION AUTHORITIES AND/OR THE NATIONAL BOARD OF FIRE UNDERWRITERS.
- 8. <u>SCHEDULING:</u> COORDINATE WITH THE OWNER FOR SCHEDULING OF WORK.
- 9. WORK SHALL BE INSTALLED IN A NEAT AND WORKMANLIKE MANNER.
- 10. KEEP THE WORK SITE AND SURROUNDING AREA FREE FROM ACCUMULATION OF WASTE MATERIALS OR RUBBISH GENERATED BY WORK FROM THIS CONTRACT. PROPERLY AND LEGALLY DISPOSE OF MATERIALS.
- 11. SAFETY: JOB SITE SAFETY SHALL BE IN STRICT ACCORDANCE WITH LOCAL, STATE, AND FEDERAL REQUIREMENTS.
- 12. VISIT THE SITE AND CAREFULLY EXAMINE EXISTING CONDITIONS THAT MAY AFFECT THE BID.
- 13. EXISTING MECHANICAL INSTALLATION: EXISTING MECHANICAL WORK WHICH WILL NOT BE RENDERED OBSOLETE AND WHICH MAY BE DISTURBED DUE TO ANY CHANGES REQUIRED UNDER THIS CONTRACT SHALL BE RESTORED TO ITS ORIGINAL OPERATING CONDITION. OTHER MECHANICAL ITEMS RENDERED OBSOLETE SHALL BE ABANDONED WHERE CONCEALED AND REMOVED WHERE EXPOSED.
- 14. WHERE EXISTING MECHANICAL WORK INTERFERES WITH NEW WORK AND WHERE SUCH INSTALLATIONS ARE TO REMAIN IN USE, THE INSTALLATIONS SHALL BE DISCONNECTED AND RELOCATED AND/OR RECONNECTED TO COORDINATE WITH NEW WORK AS INDICATED IN THE CONTRACT DOCUMENTS AND AS SPECIFIED.
- 15. DO NOT DISCONTINUE ANY MECHANICAL SYSTEM SERVICE WITHOUT FIRST OBTAINING WRITTEN APPROVAL FROM THE USER AGENCY. THE MECHANICAL SYSTEM OUTAGES SHALL BE KEPT TO A MINIMUM.
- 16. PROVIDE SUBMITTALS (SHOP DRAWINGS) FOR REVIEW FOR NEW MATERIALS AND EQUIPMENT. PRIOR TO SUBMITTING, REVIEW SUBMITTALS FOR COMPLIANCE WITH THE CONTRACT DOCUMENTS, CONFLICTS WITH OTHER TRADES, AND CONSTRUCTABILITY. IDENTIFY ANY DEVIATIONS IN SUBMITTALS FROM CONTRACT DOCUMENTS. ENGINEER'S REVIEW OF SUBMITTALS DOES NOT INCLUDE REVIEW OF DIMENSIONS, DETAILS, OR QUANTITIES. REVIEW DOES NOT WAIVE ANY REQUIREMENTS OF CONTRACT DOCUMENTS, INCLUDING REQUIREMENT TO PROVIDE A COMPLETE AND FUNCTIONAL SYSTEM.
- 17. WHEN MOUNTING MECHANICAL WORK IN AREAS SUBJECT TO PEDESTRIAN TRAFFIC, MAINTAIN REQUIRED HEADROOM CLEARANCES.
- 18. MECHANICAL MATERIALS AND EQUIPMENT SHALL BE INSTALLED AS TO MAINTAIN THEIR RESPECTIVE UL RATING AND SHALL CONFORM TO FACTORY MUTUAL STANDARDS AS APPLICABLE.
- 19. MECHANICAL WORK SHALL BE CONCEALED IN FINISHED AREAS SHOWN ON THE ARCHITECTURAL DRAWINGS UNLESS NOTED OTHERWISE.
- 20. <u>EQUIPMENT LOCATIONS:</u> REFER TO THE ARCHITECTURAL DRAWINGS FOR EXACT DIFFUSER LOCATIONS AND THE ELECTRICAL DRAWINGS FOR EXACT ELECTRICAL EQUIPMENT LOCATIONS. LOCATIONS OF MECHANICAL EQUIPMENT DUCTWORK, AND PIPING ARE SHOWN DIAGRAMMATICALLY. DETERMINE EXACT LOCATIONS IN THE FIELD.
- 21. WHERE NEW OR RELOCATED CONTROL DEVICES ARE SHOWN ON EXISTING WALLS, CUT WALL, INSTALL DEVICE AND CONDUIT, AND REPAIR WALL PROPERLY TO ITS ORIGINAL CONDITION.
- 22. SEALING FITTINGS AND APPROVED SEALING COMPOUND SHALL BE INSTALLED IN ACCORDANCE WITH THE APPLICABLE CODE. SEAL AROUND PENETRATIONS OF FIRE-RATED WALLS WITH AN APPROVED SEALANT.
- 23. LOCATIONS OF DUCTWORK, AIR DEVICES, TEMPERATURE CONTROLS, AND EQUIPMENT SHALL BE COORDINATED WITH THE ARCHITECTURAL LAYOUTS, EQUIPMENT CUTS AND PLUMBING/ELECTRICAL PLANS. NO WORK SHALL BE INSTALLED UNTIL THE LOCATIONS HAVE BEEN VERIFIED. BRING ANY DISCREPANCY TO THE ARCHITECTS ATTENTION PRIOR TO MANUFACTURING OF DUCTWORK OR INSTALLATION.
- 24. NORTH ARROWS ON THESE DRAWINGS INDICATE PLAN NORTH ONLY.
- 25. INSTALL A MANUAL VOLUME DAMPER IN EACH BRANCH DUCT THAT RUNS TO (1) AIR DEVICE.
- 26. PROVIDE PIPE SLEEVE FOR PIPING PENETRATIONS THROUGH RATED SLABS OR WALLS.
- 27. DUCT JOINTS SHALL BE SEALED USING 3M MODEL 540 DUCT SEALER. EXCESS SEALER SHALL BE REMOVED FROM DUCTWORK AND JOINTS. PAINT SEALED JOINTS TO MATCH FINISH OF DUCTWORK.
- 28. IN AREAS WHERE WORK IS INSTALLED IN CLOSE PROXIMITY TO WORK OF OTHER TRADES OR WITHIN TRADES. COVERED BY THIS DIVISION OF THE SPECIFICATIONS, PREPARE LARGER SCALE DRAWINGS CONSISTING OF PLANS AND SECTIONS TO SHOW HOW WORK IS TO BE INSTALLED IN RELATION TO WORK OF OTHER TRADES.

#### **GENERAL DEMOLITION NOTES** (APPLY TO WORK PROVIDED UNDER DIVISION 20):

- DEMOLITION WORK IS GENERALLY INDICATED AS PART OF THESE NOTES AND THE NOTES INDICATED ON THE ARCHITECTURAL DEMOLITION PLANS.
- 2. VERIFY THAT EXISTING PIPING, EQUIPMENT, ETC. THAT IS CALLED FOR REMOVAL IS NO LONGER IN SERVICE BEFORE
- 3. THE DEMOLITION NOTES INDICATE THE MAIN COMPONENTS OF SYSTEMS AND EQUIPMENT THAT SHALL BE REMOVED UNDER THIS CONTRACT. IF SYSTEMS AND EQUIPMENT ARE FOUND DURING CONSTRUCTION THAT THE OWNER AUTHORIZES FOR REMOVAL BUT HAVE NOT BEEN SPECIFICALLY CALLED FOR DEMOLITION, REMOVE THE SYSTEMS
- 4. WHEN THE WORK SPECIFIED HEREUNDER CONNECTS TO ANY EXISTING EQUIPMENT, PIPING, ETC., PERFORM NECESSARY ALTERATIONS, CUTTING, FITTING, ETC. OF THE EXISTING WORK AS MAY BE NECESSARY OR REQUIRED TO MAKE SATISFACTORY CONNECTIONS BETWEEN THE NEW AND EXISTING WORK AND LEAVE THE COMPLETE WORK IN A FINISHED AND WORKMANLIKE CONDITION.
- 5. WHEN THE WORK SPECIFIED UNDER OTHER DIVISIONS NECESSITATES RELOCATION OF EXISTING EQUIPMENT, PIPING, ETC. PERFORM WORK AND MAKE NECESSARY CHANGES TO EXISTING WORK AS MAY BE REQUIRED TO LEAVE THE COMPLETED WORK IN A FINISHED AND WORKMANLIKE CONDITION.
- REMOVE FROM THE PREMISES AND DISPOSE OF EXISTING PIPING, MATERIAL, FIXTURES, EQUIPMENT, ETC. NOT REQUIRED FOR RE- USE OR RE-INSTALLATION.
- 7. DELIVER ON THE PREMISES WHERE DIRECTED EXISTING MATERIAL AND EQUIPMENT WHICH IS REMOVED AND IS DESIRED BY THE OWNER OR IS INDICATED TO REMAIN THE PROPERTY OF THE OWNER.
- 8. OTHER MATERIALS AND EQUIPMENT WHICH ARE REMOVED SHALL BECOME THE PROPERTY OF THE CONTRACTOR AND SHALL BE REMOVED FROM THE PREMISES.
- 9. PIPING ABANDONED IN CONCRETE SLABS, WALLS, OR OTHER INACCESSIBLE LOCATIONS SHALL BE LEFT EMPTY.

#### **COMMON CONTROLS NOTES**

- 1. ALL MECHANICAL SYSTEM CONTROLS COMPONENTS AND SEQUENCES SHALL BE COORDINATED AND INTEGRATED WITH THE EXISTING JCI METASYS BUILDING MANAGEMENT SYSTEM.
- 2. PROVIDE ALL NECESSARY WIRING, CONTROLS COMPONENTS, EQUIPMENT, SOFTWARE MODIFICATIONS, AND POWER TRANSFORMERS REQUIRED FOR A FULLY FUNCTIONING, LOCAL STAND-ALONE SYSTEM OPERATION, WITH CENTRAL JCI METASYS BAS SYSTEM MONITORING, AND CONTROLS OVERRIDE CAPABILITY.

#### **HVAC CONTROL SEQUENCES**

#### 1. EXHAUST FAN: (EF-8)

A. DURING OCCUPIED PERIODS EF-8 IS TO BE ENERGIZED AND RUNNING CONTINUOUSLY.

#### B. DURING UNOCCUPIED PERIODS EF-8 IS TO BE OFF.

#### 2. ELECTRIC BASEBOARD HEATERS: (EBH-1)

A. LOCAL WALL MOUNTED THERMOSTAT IS TO CONTROL UNIT TO MAINTAIN A SPACE TEMPERATURE OF 68 DEGREES F (ADJUSTABLE).

#### 3. SPLIT SYSTEM: (ACU-1/ ACCU-1)

A. SYSTEM IS TO CYCLE PER THE MANUFACTURER PROVIDED CONTROLS BASED ON A SIGNAL FROM A WALL MOUNTED THERMOSTAT TO MAINTAIN A SPACE TEMPERATURE SET POINT OF 72 DEGREE F (ADJUSTABLE).

#### BAS MONITORING AND CONTROL:


#### 1. PROVIDE EF-8 WITH MONITORING AND CONTROL FOR THE FOLLOWING:

A. FAN ON/OFF

2. PROVIDE ACU-1/ ACCU-1 WITH MONITORING AND CONTROL FOR THE FOLLOWING: A. UNIT ON/OFF

B. SPACE TEMPERATURE SETPOINT (ADJUSTABLE)

C. SPACE TEMPERATURE (MONITORING AND HIGH TEMP. ALARM ONLY)

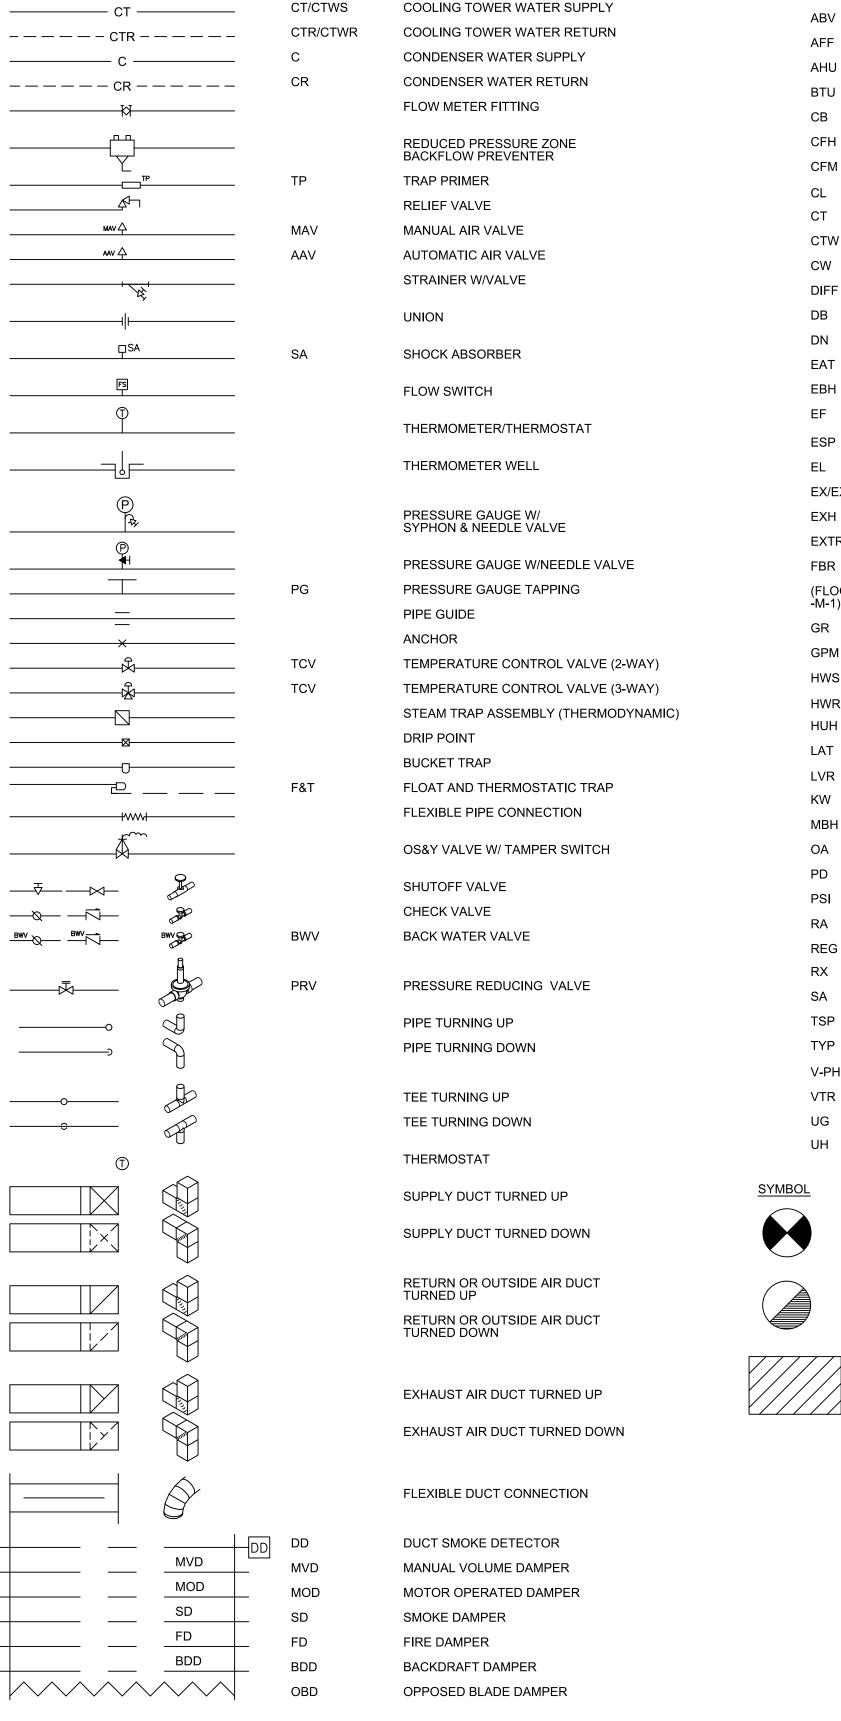

DESCRIPTION

MECHANICAL LEGEND

CFM **CUBIC FEET MINUTE** CENTER LINE CL **COOLING TOWER** CTW COOLING TOWER WATER CW **COLD WATER** DIFF DIFFUSER **DRY BULB** DN DOWN FAT **ENTERING AIR TEMPERATURE EBH** ELECTRIC BASEBOARD HEATER EXHAUST FAN EXTERNAL STATIC PRESSURE ELEVATION EX/EXIST **EXISTING** EXH **EXHAUST EXTR** EXISTING TO REMAIN FBR FIN TUBE BASEBOARD RADIATION (FLOOR PLAN PLAN ON DRAWING M-1 GR GRILLE **GPM GALLONS PER MINUTE** HWS HOT WATER SUPPLY HWR HOT WATER RETURN HUH HYDRONIC UNIT HEATER LAT LEAVING AIR TEMPERATURE LVR LOUVER ΚW KILOWATTS THOUSAND BTU/HR OA OUTSIDE AIR PRESSURE DROP POUNDS PER SQUARE INCH RETURN AIR REGISTER REMOVE EXISTING SUPPLY AIR TOTAL STATIC PRESSURE TYP TYPICAL **VTR VENT THROUGH ROOF UNDER GROUND UNIT HEATER** <u>ABBREV</u> DESCRIPTION EXTENT OF NEW WORK EXTENT OF DEMOLITION AREA TO BE DEMOLISHED MATCH LINE PIPING BELOW GRADE SECTION DESIGNATION DELAWARE RIVER AND BAY AUTHORITY CAPE MAY - LEWES FERRY DETAIL DESIGNATION CONTRACT NO. CMLF-C19-06 BUILDING - DISPATCH CENTER REHAB

DESCRIPTION

ABOVE FINISHED FLOOR


**BRITISH THERMAL UNIT** 

AIR HANDLING UNIT

CUBIC FEET HOUR

CATCH BASIN

ABOVE

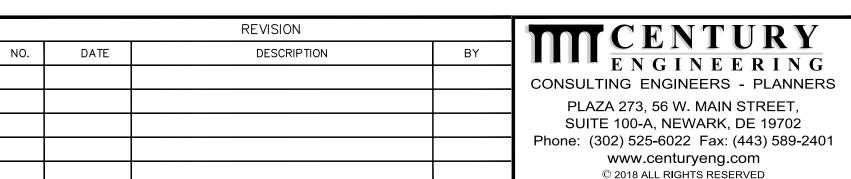


TERMINAL POLICE AND ADMINISTRATION

GENERAL NOTES SYMBOLS AND **ABBREVIATIONS** 

lM-000

DATE: JANUARY 2022 SCALE: AS NOTED SHEET NO.

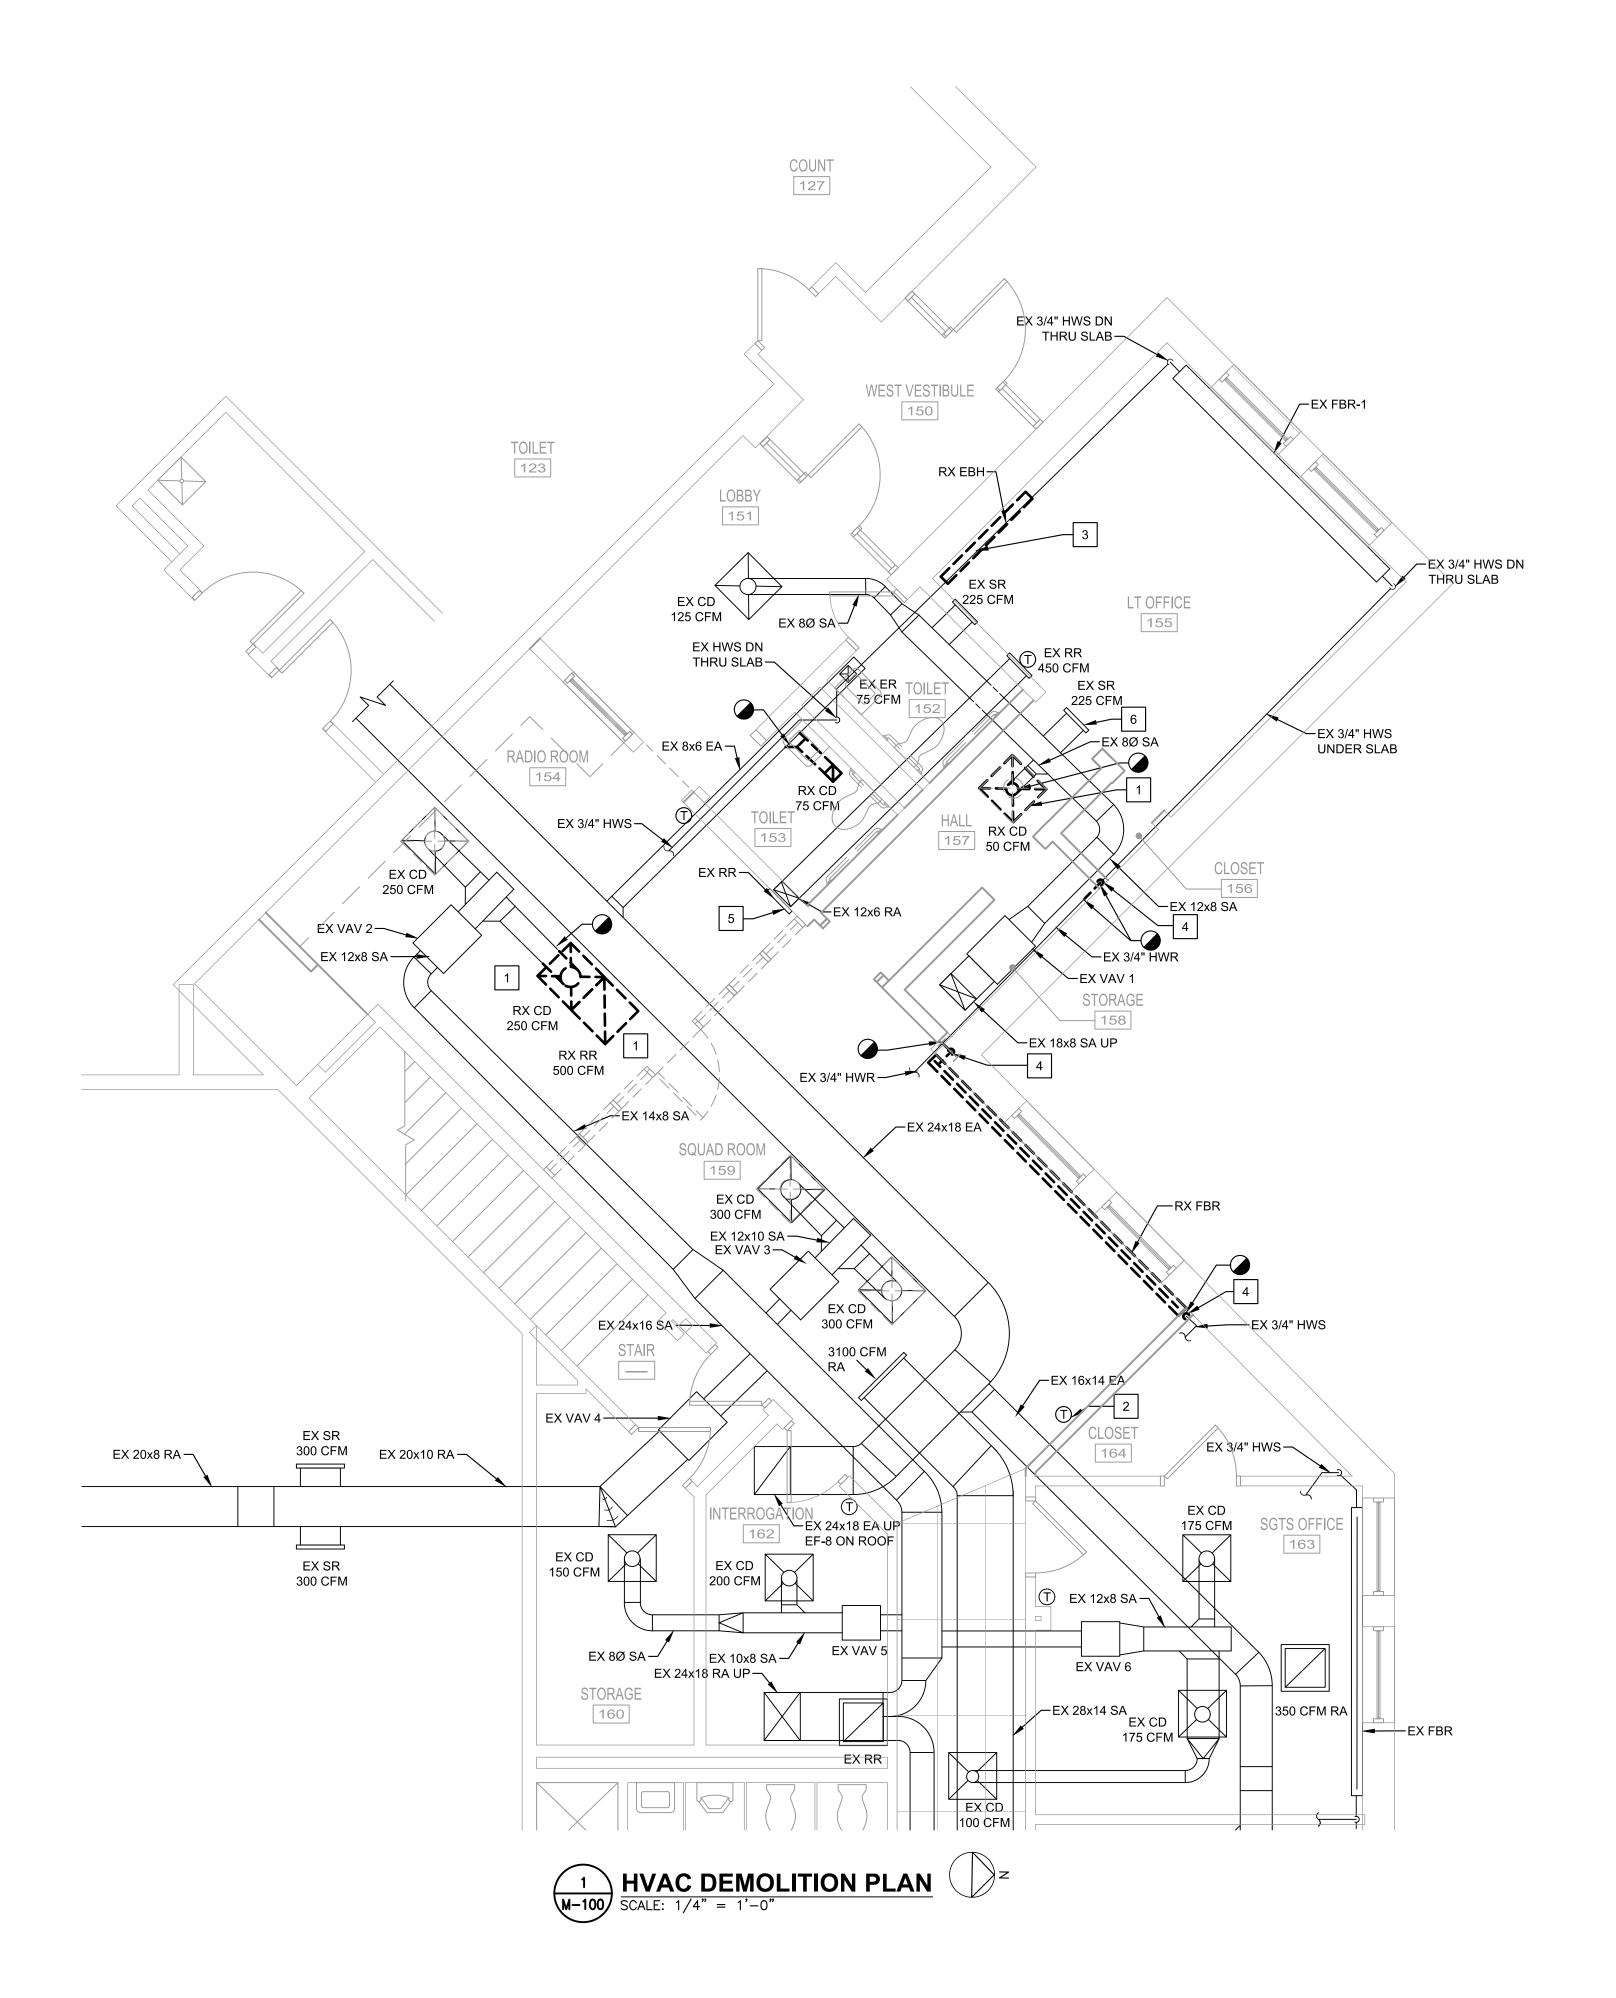

## SPECIFIC DEMOLITION NOTES (APPLY TO THIS DRAWING WHERE INDICATED):

REMOVE RETURN REGISTER/CEILING DIFFUSER, CLEAN, AND RETAIN FOR REINSTALLATION AS PART OF NEW WORK. DEMOLISH AND REPLACE ANY FLEXIBLE DUCTWORK.

EXISTING THERMOSTAT TO BE REMOVED AND REINSTALLED.


J DISCONNECT AND REMOVE EXISTING ELECTRIC BASEBOARD HEATER AND SAVE FOR REINSTALLATION.

4 REMOVE HW PIPE RISER.

5 EXISTING REGISTER ABOVE CEILING IN PLENUM.

6 REMOVE THERMOSTAT AND STORE FOR REINSTALLATION AS PART OF NEW WORK.

DEMOLITION WORK SHALL BE DONE IN PHASES. COORDINATE WORK WITH NEW INSTALLATIONS.

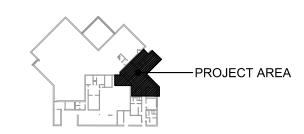





DELAWARE RIVER AND BAY AUTHORITY
CAPE MAY — LEWES FERRY


CONTRACT NO. CMLF—C19—06
TERMINAL POLICE AND ADMINISTRATION
BUILDING — DISPATCH CENTER REHAB

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<b>JAVI</b>	DEMOLITION	PLAN	


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DATE: JANUARY 2022 SCALE: AS NOTED SHEET NO. 10




## SPECIFIC NOTES (APPLY TO THIS DRAWING WHERE INDICATED):

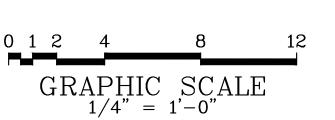REMOVE EXHAUST FAN AND REPAIR ROOF CURB AS REQUIRED.

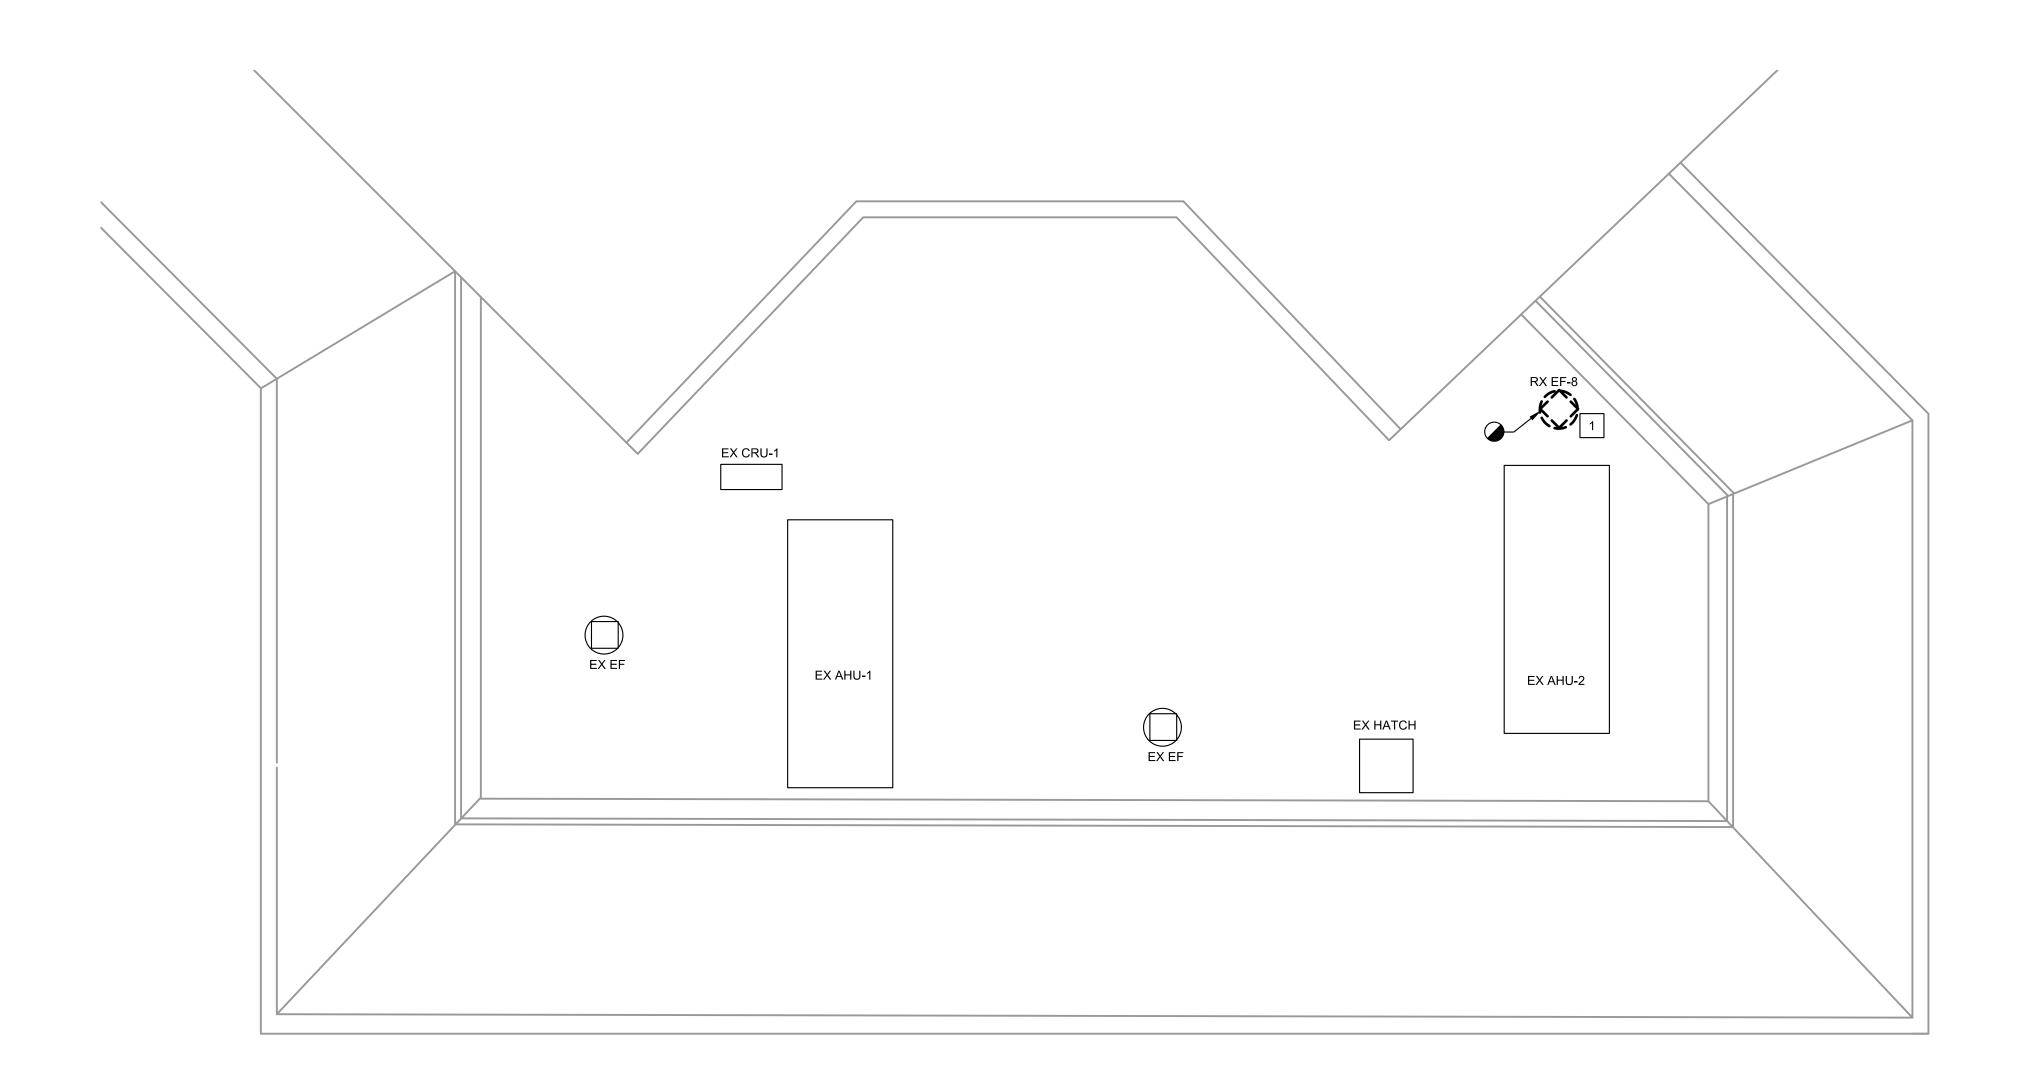

ROOF HVAC DEMOLITION PLAN

SCALE: 1/8" = 1'-0"

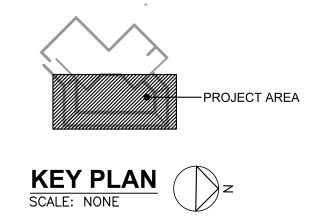



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ROOF	HVAC	DEMOL	ITION	
	PL.	AN		M-1

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#### **DRAWING NOTES:**

1. SEAL WALL PIPE PENETRATIONS.

#### SPECIFIC NOTES: (APPLY TO THIS DRAWING WHERE INDICATED):

- (1) REINSTALL EXISTING AIR DEVICE AT THIS LOCATION.
- 2 REINSTALL EXISTING THERMOSTAT WITH VAV BOX.
- 3/4" HWR WITH INSULATION ROUTED UNDER SLAB. CUT AND PATCH FLOOR AS REQUIRED. COORDINATE WITH OTHER DISCIPLINES.
- 4 3/4" HWR DROP DOWN THRU SLAB IN WALL.
- $\langle 5 \rangle$  COORDINATE PIPE ROUTING WITH DUCTWORK.
- SUSPEND REFRIGERANT PIPING FROM STRUCTURE. COORDINATE ROUTING WITH EXISTING CONDITIONS.
- 7 REINSTALL AND RECONNECT EXISTING ELECTRIC BASEBOARD HEATER
- $\left\langle 8\right\rangle$  PATCH AND SEAL EXHAUST DUCT AT REMOVED BRANCH.
- 9 REINSTALL THERMOSTAT.








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HVAC PLAN |M-110|SHEET NO. DATE: JANUARY 2022 SCALE: AS NOTED





GRAPHIC SCALE 1/4" = 1'-0"

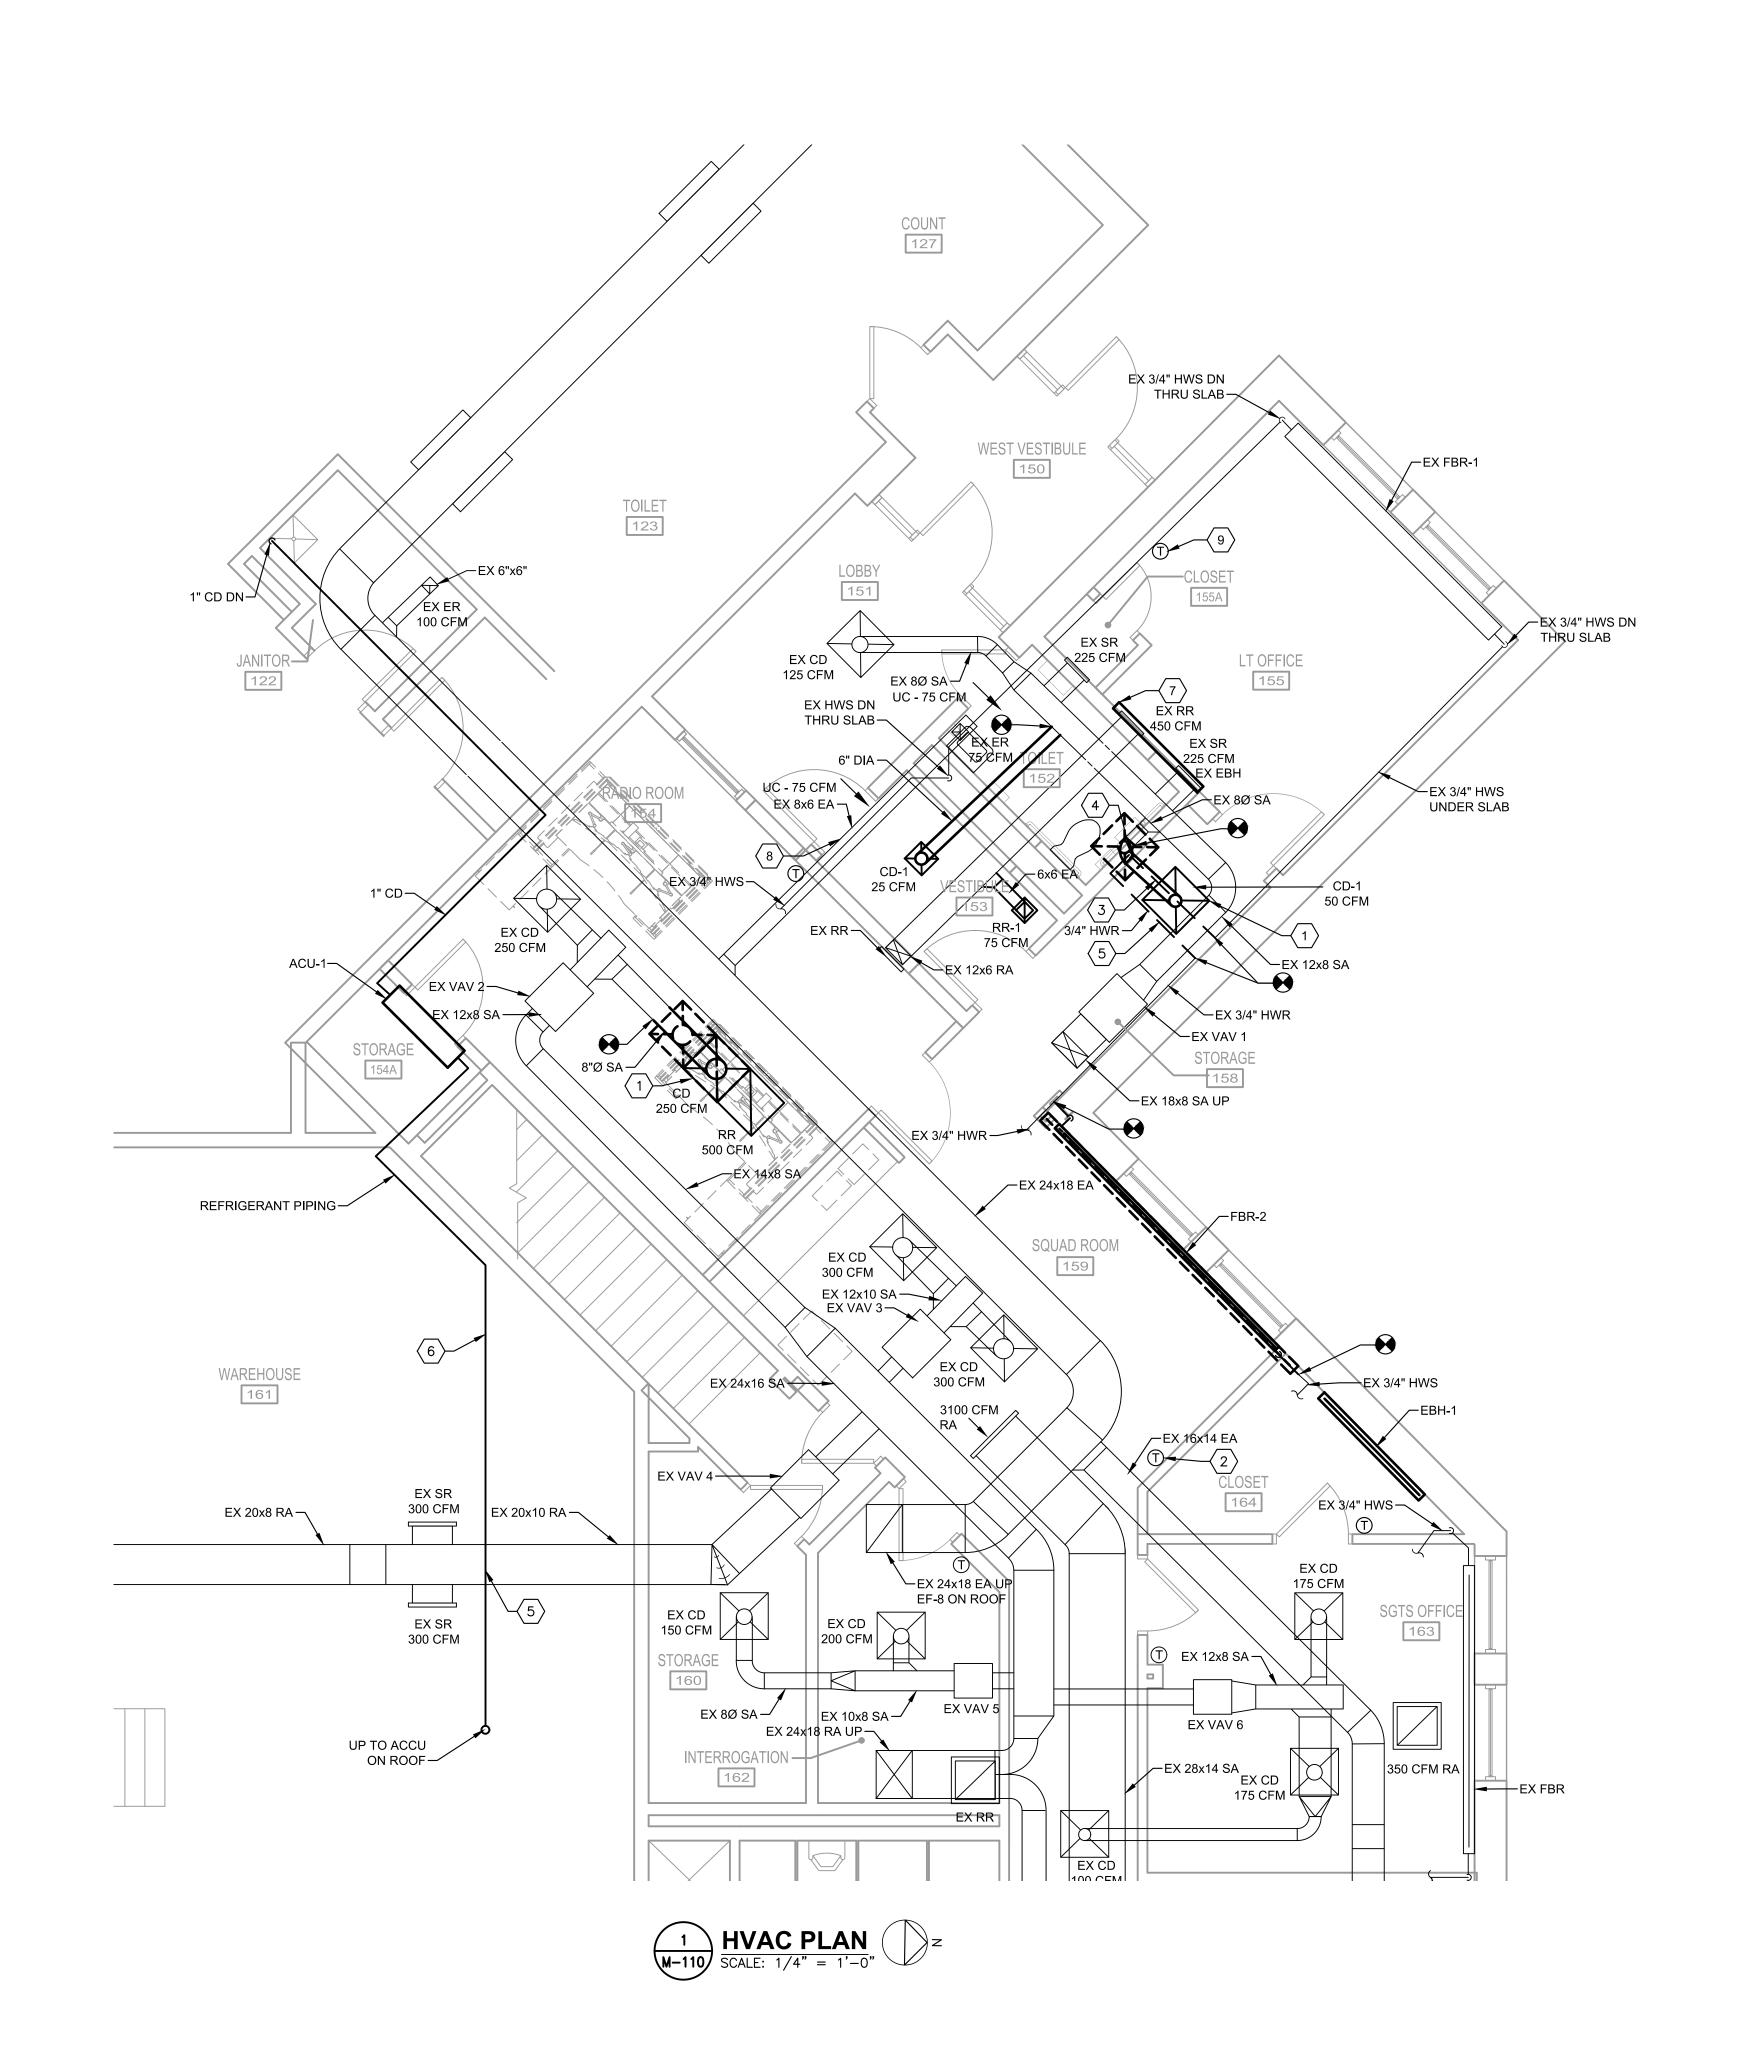



#### **DRAWING NOTES:**


- COORDINATE WORK WITH OTHER TRADES AND EXISTING CONDITIONS
- 2. REFRIGERANT PIPING IS TO BE INSULATED WITH JACKETING SEALED WEATHER TIGHT.

### SPECIFIC NOTES: (APPLY TO THIS DRAWING WHERE INDICATED):

1 REFRIGERANT PIPING ROOF PENETRATION.

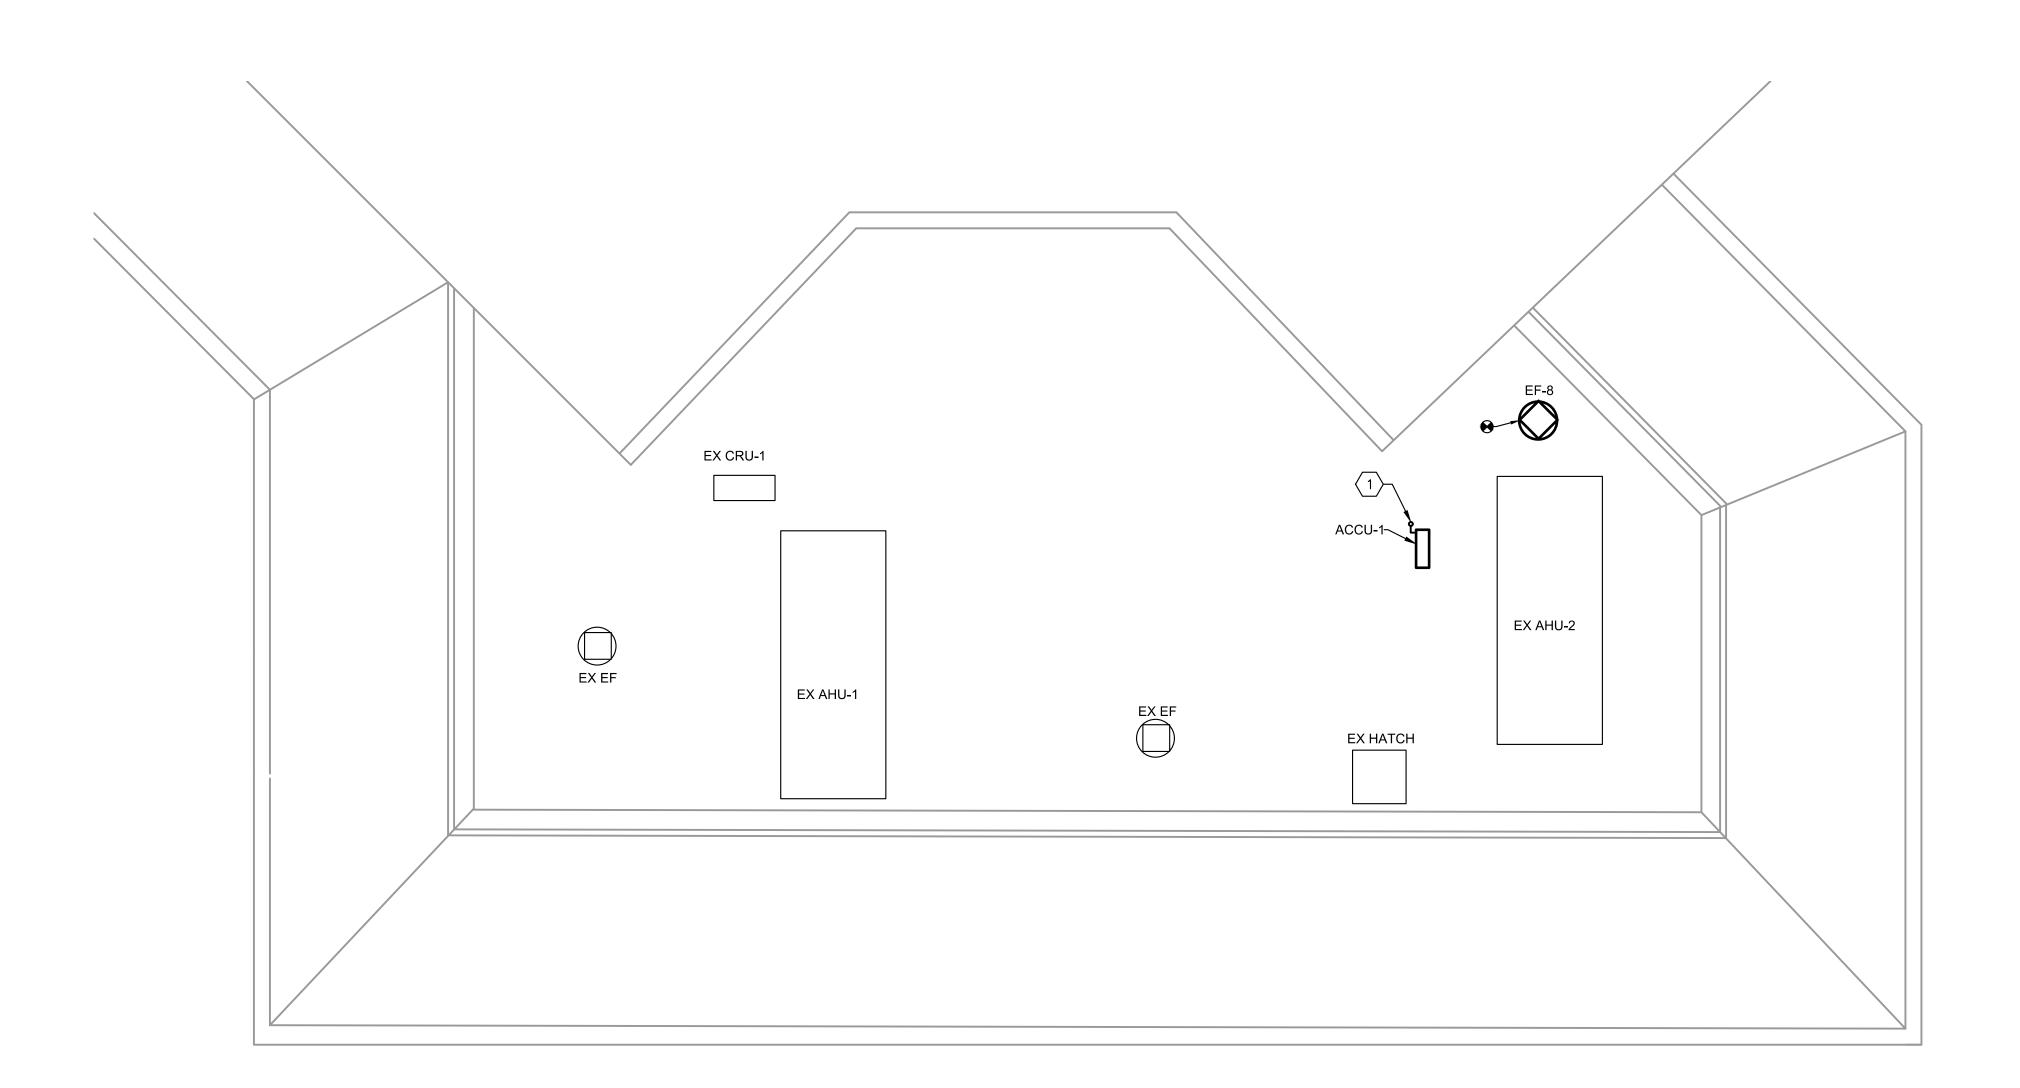

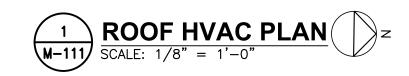

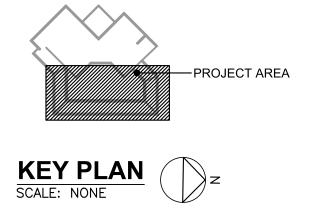

GRAPHIC SCALE 1/8" = 1'-0"



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TERMINAL POLICE AND ADMINISTRATION
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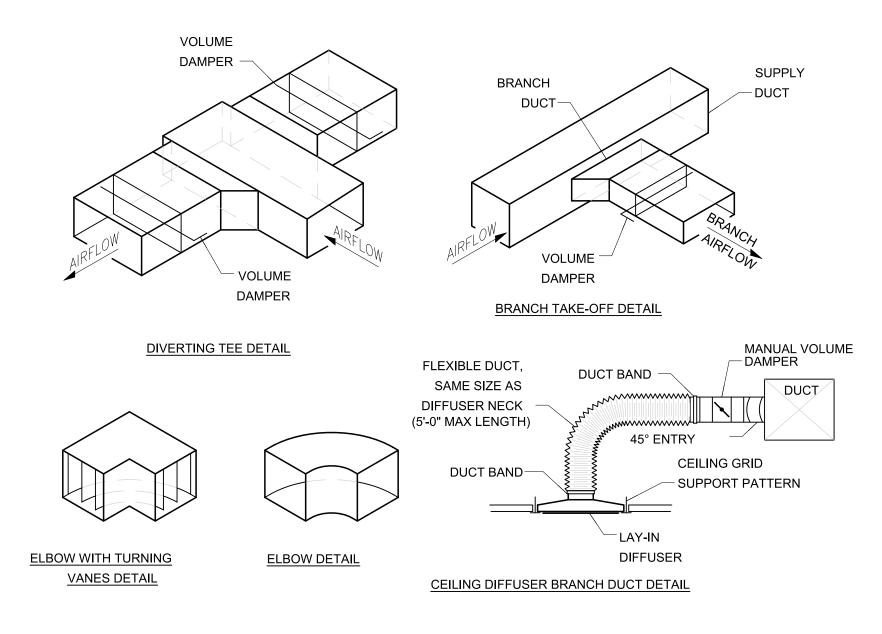
ROOF HVAC PLAN
GINEERS - PLANNERS

DATE: JANUARY 2022


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SHEET NO. 13

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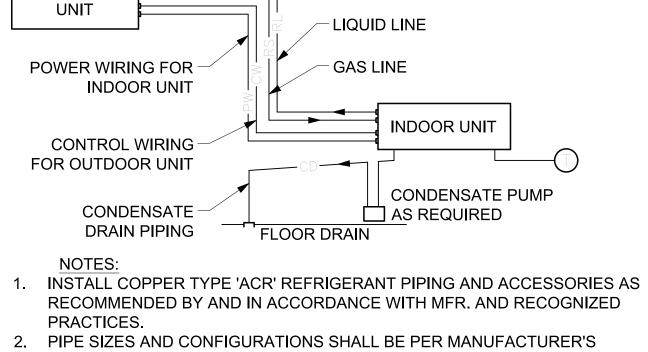


1) TYPICAL DUCT DETAILS NOT TO SCALE



- 1. ANCHOR SECURELY PER MANUFACTURERS INSTALLATION GUIDE. 2. VERIFY SPACING WITH MANUFACTURERS INSTALLATION INSTRUCTIONS.
- 3. RE-FLASH AND PATCH ROOF WATER TIGHT.

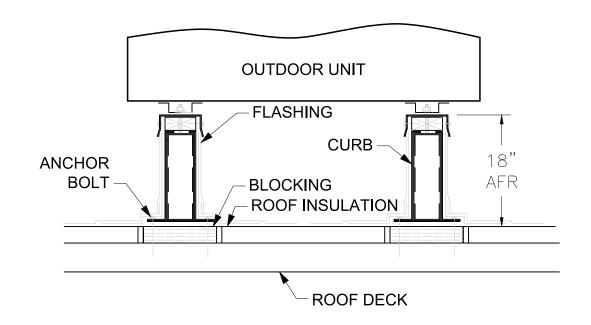
 $4 \frac{ROOF RAIL DETAIL}{NOT TO SCALE}$ 



- RECOMMENDED BY AND IN ACCORDANCE WITH MFR. AND RECOGNIZED
- SPECIFICATIONS AND RECOMMENDATIONS.
- 3. INSULATE BOTH REFRIGERANT LINES PER MFR RECOMMENDATIONS. MIN 1/2" THICK. PROVIDE WITH JACKETING OUTSIDE OF BUILDING.
- 4. ROUTE OUTDOOR CONTROL WIRING WITH, AND SECURE TO, GAS LINE BETWEEN UNITS.
- 5. INSTALL REFRIGERANT PIPING PARALLEL OR PERPENDICULAR TO THE LINES OF THE BUILDING STRUCTURE ALLOWING A MINIMUM OF FOUR INCHES CLEARANCE TO EXISTING PIPING, EQUIPMENT, AND ELECTRICAL/CONTROL WIRING.


DETAIL - SPLIT SYSTEM NOT TO SCALE

CONDENSING

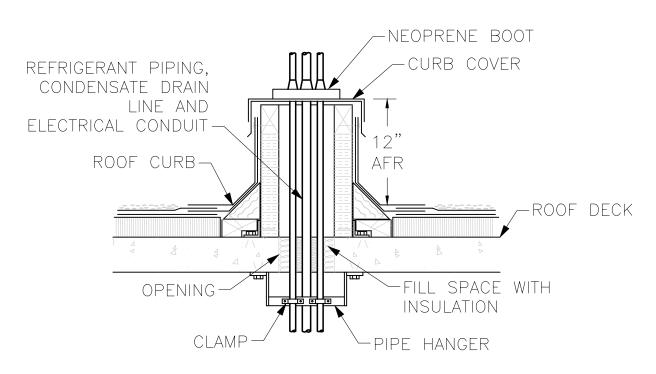

1. VERIFY PIPE AND CONDUIT SIZES AND QUANTITIES 2. PIPE INSULATION NOT SHOWN 3. CUT AND PATCH ROOF OPENING WEATHER TIGHT

(5) ROOF-TOP PIPE CURB DETAIL NOT TO SCALE

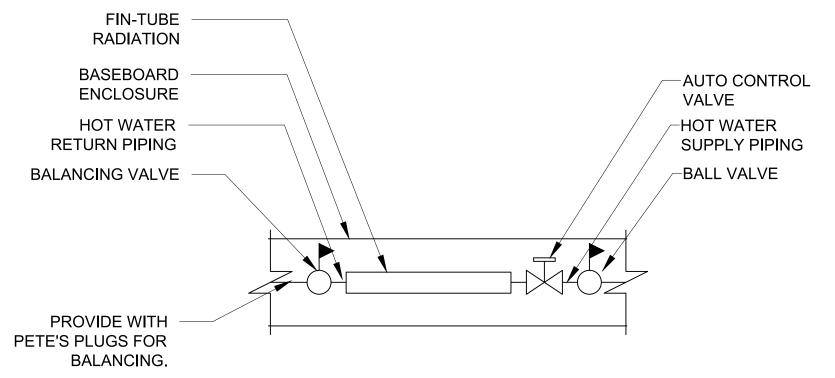

3 DETAIL - TYPICAL FIN-TUBE RADIATION VALVE ARRANGEMENT NOT TO SCALE



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				DUCTLESS SPLIT	SYSTEM INDOOR U	INIT SCHEDULE			
					COOLING				
TAG	SERVING	NOMINAL TONNAGE	SUPPLY AIR CFM	OUTSIDE AIR T	EMPERATURE	COOLING	MANUFACTURER	MODEL	REMARKS
		TOTAL	Ci ivi	DB (F)	WB (F)	CAPACITY (MBH)			
ACU-1	IT ROOM	2	635	95	75	24	MITSUBISHI	PKA	1, 2

- 1. PROVIDE WITH ELECTRICAL DISCONNECT AND WALL MOUNTED THERMOSTAT. PROVIDE WITH CONDENSATE PUMP. REFRIGERANT R-410A.
- 2. INDOOR UNIT IS POWERED FROM OUTDOOR UNIT.

					SPLIT SYSTEM	OUTDOOR UN	IIT SCHEDULE					
TAG	CEDVING	COOLING	OA 1	ГЕМР	FED	SEER		ELEC	TRICAL		NAANUITACTUDED	MODEL
IAG	SERVING	CAPACITY ( MBH)	DB (F)	WB (F)	EER	SEEK	VOLTAGE	PHASE	MCA (A)	MOCP (A)	MANUFACTURER	INIODEL
ACCU-1	ACU-1	24	95	75	10.6	17	208	1	18	30	MITSUBISHI	PUY-A24NHA6

		EXISTING	G VAV BOX SCH	EDULE		
TAG	SERVING	AIRFLOW	HEATING	CAPACITY	MANUFACTURER	MODEL
IAG	SERVING	(CFM)	МВН	GPM	- IVIANOFACTORER	MODEL
VAV-1	115 LOBBY & 155 LT OFFICE	650	-	-	TRANE	VCWF-08
VAV-2	154 RADIO ROOM	500	-	-	TRANE	VCWF-08
VAV-3	159 SQUAD ROOM	600	-	-	TRANE	VCWF-08
VAV-4	161 WAREHOUSE	1200	-	-	TRANE	VCWF-12
VAV-5	INTERROGATION/STORAGE	350	-	-	TRANE	VCWF-06
VAV-6	163 SGTS OFFICE	450	-	-	TRANE	VCWF-08
VAV-7	LUNCH ROOM	400	-	-	TRANE	VCWF-08
VAV-8	MEN'S LOCKER ROOM	450	8.2	1	TRANE	VFWC-08
VAV-9	WOMEN'S LOCKER ROOM	350	14	1.5	TRANE	VFWC-08
VAV-11	203 PC TRAINING	650	-	-	TRANE	VCWF-08
VAV-12	201 WORKROOM	1900	-	-	TRANE	VCWF-12

- 1. VAV BOXES ARE EXISTING TO REMAIN.
- 2. MIN AIR SUPPLY FOR BOXES SHALL BE 25% OR AS REQUIRED FOR MAKE-UP

			FIN-TUBE	BASEBOARD RADIA	TION HEATER SCHEDUL	.E		
TAG	SERVING	ROWS	AVERAGE TEMP (°F)	LENGTH (FT)	RECOVERY RATE (BTU/LF)	MANUFACTURER	MODEL	REMARKS
FBR-1	155 LT OFFICE	1	170	12	775	TRANE	TA	1, 2
FBR-2	159 SQUAD ROOM	1	170	13	775	TRANE	TA	1, 3

- 1. COPPER ALUMINIUM 1-1/4", SERIES 60, FINS 2-1/2" x 5-1/4" x 0.015".
- 2. EXISTING TO REMAIN.
- 3. UNIT TO BE CONTROLLED IN A MANNER CONSISTENT WITH THE EXISTING WITH THE EXISTING UNIT TO BE REPLACED.

AIR DEVICE SCHEDULE - RETURN REGISTERS							
TAG	AIRFLOW	ТҮРЕ	SIZE	MANUFACTURER	MODEL		
RR-1	75 CFM	LAY-IN	12"x12"	TITUS	350FL		

AIR DEVICE SCHEDULE - SUPPLY DIFFUSER							
TAG	AIRFLOW	TYPE	SIZE	MANUFACTURER	MODEL		
CD-1	25 CFM	LAY-IN	12"x12"	TITUS	TMS		

			ELEC	CTRIC BASEBOARD I	HEATER SCHEDULE			
TAC	CEDVING	LENGTH		ELECTRICAL		NAANUIFACTURER	MODEL	DEMARKS
TAG	SERVING	LENGTH	KW	VOLTAGE	PHASE	MANUFACTURER	MIODEL	REMARKS
EBH-1	164 CLOSET	5'-0"	1.25	120	1	BERKO	ASL3	1

NOTES 1. PROVIDE WITH WALL THERMOSTAT.

			EXH	AUST F	AN SCHEDULE				
	AIRFLOW				ELECTR	ICAL			
TAG	(CFM)	TYPE	ESP	HP	VOLTAGE	PHASE	MANUFACTURER	MODEL	REMARKS
EF-8	2875	UPBLAST CENTRIFUGAL	0.75	1.5	480	3	GREENHECK	CUE-200HP	1

1. PROVIDE WITH ELECTRICAL DISCONNECT SWITCH, VARI-GREEN DRIVE, BACKDRAFT DAMPER. VERIFY THAT NEW EF IS COMPATIBLE WITH EXISTING ROOF CURB. REPLACE CURB AS REQUIRED.



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CONTRACT NO. CMLF-C19-06 TERMINAL POLICE AND ADMINISTRATION BUILDING - DISPATCH CENTER REHAB

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#### **GENERAL NOTES** (APPLY TO WORK PROVIDED UNDER DIV. 20):

- 1. GENERAL: FURNISH LABOR, EQUIPMENT AND MATERIALS NECESSARY FOR THE INSTALLATION OF THE COMPLETE PLUMBING SYSTEMS AS SPECIFIED HEREIN AND INDICATED IN THE CONTRACT DOCUMENTS. OUTLINE DESCRIPTION AND DIAGRAMMATIC REPRESENTATION OF SYSTEM OPERATION AND EQUIPMENT DOES NOT LIMIT CONTRACTOR LIABILITY FOR FURNISHING AND INSTALLING COMPLETE AND OPERABLE SYSTEMS.
- 2. APPLICABLE CODES: THE INSTALLATION SHALL COMPLY WITH THE LATEST EDITION OF THE CODE OF THE LOCAL AUTHORITY HAVING JURISDICTION.
- 3. NOTE DEFINITIONS: "DRAWING NOTES" APPLY TO THE ENTIRE DRAWING ON WHICH THEY APPEAR, WHERE RELEVANT. SPECIFIC NOTES" APPLY ONLY WHERE INDICATED WITH THE "SPECIFIC NOTE" SYMBOL. REFER TO LEGEND.
- 4. PROVIDE REQUIRED CLEARANCE FOR MAINTENANCE IN ACCORDANCE WITH MANUFACTURERS RECOMMENDATIONS OR AS REQUIRED BY CODE FOR MECHANICAL AND PLUMBING EQUIPMENT.
- 5. VERIFY THAT EXISTING EQUIPMENT THAT IS TO REMAIN IS FULLY FUNCTIONAL AND OPERATIONAL.
- 6. PERMITS: INCLUDE IN THE BID PRICE THE PAYMENT OF NECESSARY PERMITS. FURNISH THE OWNER PRIOR TO THE FINAL PAYMENT A CERTIFICATE FROM THE INSPECTION DEPARTMENT HAVING JURISDICTION CERTIFYING THAT THE WORK MEETS THE REQUIREMENTS OF THE LOCAL INSPECTION AUTHORITIES AND/OR THE NATIONAL BOARD OF FIRE UNDERWRITERS.
- 7. <u>SCHEDULING:</u> COORDINATE WITH THE OWNER FOR SCHEDULING OF WORK.
- 8. WORK SHALL BE INSTALLED IN A NEAT AND WORKMANLIKE MANNER.
- 9. KEEP THE WORK SITE AND SURROUNDING AREA FREE FROM ACCUMULATION OF WASTE MATERIALS OR RUBBISH GENERATED BY WORK FROM THIS CONTRACT. PROPERLY AND LEGALLY DISPOSE OF MATERIALS.
- 10. SAFETY: JOB SITE SAFETY SHALL BE IN STRICT ACCORDANCE WITH LOCAL, STATE, AND FEDERAL REQUIREMENTS.
- 11. VISIT THE SITE AND CAREFULLY EXAMINE EXISTING CONDITIONS THAT MAY AFFECT THE BID.
- 12. EXISTING PLUMBING INSTALLATION: EXISTING PLUMBING WORK WHICH WILL NOT BE RENDERED OBSOLETE AND WHICH MAY BE DISTURBED DUE TO ANY CHANGES REQUIRED UNDER THIS CONTRACT SHALL BE RESTORED TO ITS ORIGINAL OPERATING CONDITION. OTHER PLUMBING ITEMS OR PLUMBING FIXTURES RENDERED OBSOLETE SHALL BE ABANDONED WHERE CONCEALED AND REMOVED WHERE EXPOSED.
- 13. WHERE EXISTING PLUMBING WORK INTERFERES WITH NEW WORK AND WHERE SUCH INSTALLATIONS ARE TO REMAIN IN USE. THE INSTALLATIONS SHALL BE DISCONNECTED AND RELOCATED AND/OR RECONNECTED TO COORDINATE WITH NEW WORK AS INDICATED IN THE CONTRACT DOCUMENTS AND AS SPECIFIED.
- 14. DO NOT DISCONTINUE ANY PLUMBING SYSTEM SERVICE WITHOUT FIRST OBTAINING WRITTEN APPROVAL FROM THE USER AGENCY. THE PLUMBING SYSTEM OUTAGES SHALL BE KEPT TO A MINIMUM.
- 15. PROVIDE SUBMITTALS (SHOP DRAWINGS) FOR REVIEW FOR NEW MATERIALS AND EQUIPMENT. PRIOR TO SUBMITTING, REVIEW SUBMITTALS FOR COMPLIANCE WITH THE CONTRACT DOCUMENTS, CONFLICTS WITH OTHER TRADES, AND CONSTRUCTABILITY. IDENTIFY ANY DEVIATIONS IN SUBMITTALS FROM CONTRACT DOCUMENTS. ENGINEER'S REVIEW OF SUBMITTALS DOES NOT INCLUDE REVIEW OF DIMENSIONS, DETAILS, OR QUANTITIES. REVIEW DOES NOT WAIVE ANY REQUIREMENTS OF CONTRACT DOCUMENTS, INCLUDING REQUIREMENT TO PROVIDE A COMPLETE AND FUNCTIONAL SYSTEM.
- 16. WHEN MOUNTING PLUMBING WORK IN AREAS SUBJECT TO PEDESTRIAN TRAFFIC, MAINTAIN REQUIRED HEADROOM CLEARANCES.
- 17. PLUMBING MATERIALS AND EQUIPMENT SHALL BE INSTALLED AS TO MAINTAIN THEIR RESPECTIVE UL RATING AND SHALL CONFORM TO FACTORY MUTUAL STANDARDS AS APPLICABLE.
- 18. PLUMBING WORK SHALL BE CONCEALED IN FINISHED AREAS SHOWN ON THE ARCHITECTURAL DRAWINGS UNLESS NOTED OTHERWISE.
- 19. EQUIPMENT LOCATIONS: REFER TO THE ARCHITECTURAL DRAWINGS FOR EXACT FIXTURE LOCATIONS AND THE ELECTRICAL DRAWINGS FOR EXACT ELECTRICAL EQUIPMENT LOCATIONS. LOCATIONS PLUMBING EQUIPMENT AND PIPING ARE SHOWN DIAGRAMMATICALLY. DETERMINE EXACT LOCATIONS IN THE FIELD.
- 20. SEALING FITTINGS AND APPROVED SEALING COMPOUND SHALL BE INSTALLED IN ACCORDANCE WITH THE APPLICABLE CODE. SEAL AROUND PENETRATIONS OF FIRE-RATED WALLS WITH AN APPROVED SEALANT.
- 21. SANITARY AND DRAINAGE PIPING SHALL RUN AT 2% SLOPE MINIMUM, UNLESS NOTED OTHERWISE.
- 22. LOCATIONS OF DRAINS AND CONNECTIONS TO FIXTURES AND EQUIPMENT SHALL BE COORDINATED WITH FLOOR PLANS, EQUIPMENT CUTS AND MECHANCIAL/ELECTRICAL/STRUCTURAL PLANS. NO WORK SHALL BE INSTALLED UNTIL LOCATIONS HAVE BEEN VERIFIED.
- 23. PLUMBING FIXTURES SHALL BE CAULKED TO THE ADJOINING FLOOR OR WALL SURFACE.
- 24. PROVIDE CLEANOUTS IN SANITARY AND DRAIN LINES EVERY 50 FEET UNLESS INDICATED AT CLOSER INTERVALS ON THE DRAWINGS AND AT CHANGES OF DIRECTION.
- 25. THE PLUMBING FIXTURE SCHEDULE AND SPECIFICATIONS SUPERCEDE THE SYMBOLS INDICATED ON THE FLOOR
- 26. PIPE DROPS IN EXTERIOR WALLS SHALL BE INBOARD OF INSULATION.

#### **GENERAL DEMOLITION NOTES** (APPLY TO WORK PROVIDED UNDER DIVISION 20):

- DEMOLITION WORK IS GENERALLY INDICATED AS PART OF THESE NOTES AND THE NOTES INDICATED ON THE ARCHITECTURAL DEMOLITION PLANS.
- 2. VERIFY THAT EXISTING PIPING, EQUIPMENT, ETC. THAT IS CALLED FOR REMOVAL IS NO LONGER IN SERVICE BEFORE BEGINNING DEMOLITION.
- 3. THE DEMOLITION NOTES INDICATE THE MAIN COMPONENTS OF SYSTEMS AND EQUIPMENT THAT SHALL BE REMOVED UNDER THIS CONTRACT. IF SYSTEMS AND EQUIPMENT ARE FOUND DURING CONSTRUCTION THAT THE OWNER AUTHORIZES FOR REMOVAL BUT HAVE NOT BEEN SPECIFICALLY CALLED FOR DEMOLITION, REMOVE THE SYSTEMS
- 4. WHEN THE WORK SPECIFIED HEREUNDER CONNECTS TO ANY EXISTING EQUIPMENT, PIPING, ETC., PERFORM NECESSARY ALTERATIONS, CUTTING, FITTING, ETC. OF THE EXISTING WORK AS MAY BE NECESSARY OR REQUIRED TO MAKE SATISFACTORY CONNECTIONS BETWEEN THE NEW AND EXISTING WORK AND LEAVE THE COMPLETE WORK IN A FINISHED AND WORKMANLIKE CONDITION.
- 5. WHEN THE WORK SPECIFIED UNDER OTHER DIVISIONS NECESSITATES RELOCATION OF EXISTING EQUIPMENT, PIPING, ETC. PERFORM WORK AND MAKE NECESSARY CHANGES TO EXISTING WORK AS MAY BE REQUIRED TO LEAVE THE COMPLETED WORK IN A FINISHED AND WORKMANLIKE CONDITION.
- REMOVE FROM THE PREMISES AND DISPOSE OF EXISTING PIPING, MATERIAL, FIXTURES, EQUIPMENT, ETC. NOT REQUIRED FOR RE- USE OR RE-INSTALLATION.
- 7. DELIVER ON THE PREMISES WHERE DIRECTED EXISTING MATERIAL AND EQUIPMENT WHICH IS REMOVED AND IS DESIRED BY THE OWNER OR IS INDICATED TO REMAIN THE PROPERTY OF THE OWNER.
- 8. OTHER MATERIALS AND EQUIPMENT WHICH ARE REMOVED SHALL BECOME THE PROPERTY OF THE CONTRACTOR AND SHALL BE REMOVED FROM THE PREMISES.
- 9. PIPING ABANDONED IN CONCRETE SLABS, WALLS, OR OTHER INACCESSIBLE LOCATIONS SHALL BE LEFT EMPTY.

#### GENERAL NOTES: FIRE PROTECTION (APPLY TO WORK PROVIDED UNDER DIVISION 20):

- EXISTING SPRINKLER SYSTEM SERVING THE RENOVATED SPACE IS TO REMAIN AND SHALL BE MODIFIED AND EXTENDED AS REQUIRED BY A CERTIFIED SPRINKLER CONTRACTOR TO SUIT NEW CONSTRUCTION.
- REROUTE EXISTING SPRINKLER PIPING AS REQUIRED TO AVOID ROUTING THRU OR ABOVE ELECTRICAL EQUIPMENT ROOMS. ELECTRIC ROOMS SHALL ONLY CONTAIN PIPING THAT SERVES THAT ROOM.
- 3. THE EXISTING SPRINKLER SYSTEM AND SPRINKLER HEADS SHALL BE UPGRADED AS REQUIRED TO MEET ALL CURRENT NFPA 13, NFPA 25 AND ALL APPLICABLE LOCAL FIRE CODES, REGULATIONS AND WITH THE APPROVAL OF THE LOCAL FIRE MARSHAL AND/OR THE AUTHORITY HAVING
- 4. EXISTING SPRINKLER PIPING TO REMAIN IS TO BE THOROUGHLY FLUSHED AND TESTED FOR LEAKAGE AND DEFECTS IN WORK AND MATERIALS. A CERTIFIED SPRINKLER ENGINEER SHALL PROVIDE SPRINKLER SHOP DRAWINGS AND HYDRAULIC CALCULATION FOR A LIGHT HAZARD SPRINKLER CLASSIFICATION
- 5. COORDINATE SPRINKLER HEADS WITH NEW CEILING LAYOUT AND ALL OTHER TRADES. PROVIDE TAMPER/SUPERVISORY SWITCHES AS REQUIRED PER NFPA. SPRINKLER HEADS ARE TO BE PENDANT TYPE TO MATCH EXISTING.
- 6. IN RENOVATED AREAS SUBJECT TO FREEZING, DRY SIDEWALL HEADS SHALL BE USED FROM THE WET SYSTEM SERVING SUCH AREAS.

			PLUMBING FIXTU	IRE SCHEDULE		
TAG	DESCRIPTION	CW SIZE	HW SIZE	SAN SIZE	VENT SIZE	NOTES
WC-1	WATER CLOSET	1/2"	-	4"	2"	

<u>YMBOL</u>		<u>ABBREV</u> SP,SAN	<u>DESCRIPTION</u> SANITARY PIPE
0147		SP,SAN SW	SANITARY PIPE  STORM WATER
SW - D -		D	DRAIN
_	. ——	FDR	FOUNDATION DRAIN
	CO	СО	CLEANOUT
		VP	VENT PIPE
		CW	COLD WATER
		HW	HOT WATER
	_	HWC	HOT WATER CIRCULATING
т		Т	TEMPERED WATER
G -		G -	GAS
——— F -		F	FIRE LINE
<del> </del>			FLOW METER FITTING
			REDUCED PRESSURE ZONE BACKFLOW PREVENTER
<u> </u>	TP	TP	TRAP PRIMER
<u> </u>	_ ¬		RELIEF VALVE
мачД		MAV	MANUAL AIR VALVE
AAV A		AAV	AUTOMATIC AIR VALVE
<del></del>	攻,		STRAINER W/VALVE
	<i>¬</i> y		UNION
₽S.	Α	SA	SHOCK ABSORBER
FS			FLOW SWITCH
Φ			THERMOMETER/THERMOSTAT
	<u>-</u>		THERMOMETER WELL
(P)	>		PRESSURE GAUGE W/ SYPHON & NEEDLE VALVE
<b>®</b> ₩			PRESSURE GAUGE W/NEEDLE VALVE
	<u> </u>	PG	PRESSURE GAUGE TAPPING
			PIPE GUIDE
×			ANCHOR
<del></del>	W <del> </del>		FLEXIBLE PIPE CONNECTION
	<u> </u>	OS&Y	OS&Y VALVE W/ TAMPER SWITCH
——₹			SHUTOFF VALVE
~ ~~ ~~~			CHECK VALVE
	BINY	BWV	BACK WATER VALVE
——————————————————————————————————————		PRV	PRESSURE REDUCING VALVE
	δ, <b>ν</b> θ ~β		PIPE TURNING UP
o	9		PIPE TURNING DOWN
			TEE TURNING UP
			TEE TURNING DOWN
——   wн	→ WH	WH	WALL HYDRANT
	7		GAS PRESSURE REGULATOR
o AD	***	AD	AREA DRAIN
⊚ <sup>FD</sup>		FD	FLOOR DRAIN
ØFDP		FDP	FLOOR DRAIN WITH TRAP PRIMER
o RD		RD	ROOF DRAIN
ofs 		FS	FLOOR SINK MATCH LINE
1	<del>\</del>		SECTION DESIGNATION
( ·	<del>)</del>		DETAIL DESIGNATION
\ 1			

**REVISION** 

DESCRIPTION

DATE



ENGINEERING

CONSULTING ENGINEERS - PLANNERS

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DELAWARE RIVER AND BAY AUTHORITY CAPE MAY - LEWES FERRY

CONTRACT NO. CMLF-C19-06 TERMINAL POLICE AND ADMINISTRATION BUILDING - DISPATCH CENTER REHAB

GENERAL NOTES SYMBOLS AND **ABBREVIATIONS** 

AFF

BTU

СВ

CFH

CFM

DIFF

EX

**EXTR** 

GPM

KW

VTR

(FLOOR PLAN

ABOVE FINISHED FLOOR

BRITISH THERMAL UNIT

CATCH BASIN

DIFFUSER

**EXISTING** 

KILOWATTS

VOLT-PHASE

<u>ABBREV</u>

CUBIC FEET HOUR

CUBIC FEET MINUTE

EXISTING TO REMAIN

PLAN ON DRAWING M-1

GALLONS PER MINUTE

THOUSAND BTU/HR

REMOVE EXISTING

VENT THROUGH ROOF

DESCRIPTION

EXTENT OF NEW WORK

EXTENT OF DEMOLITION


AREA TO BE DEMOLISHED

FOR CONTINUATION SEE FLOOR

P - 000

SHEET NO.

DATE: JANUARY 2022 SCALE: AS NOTED

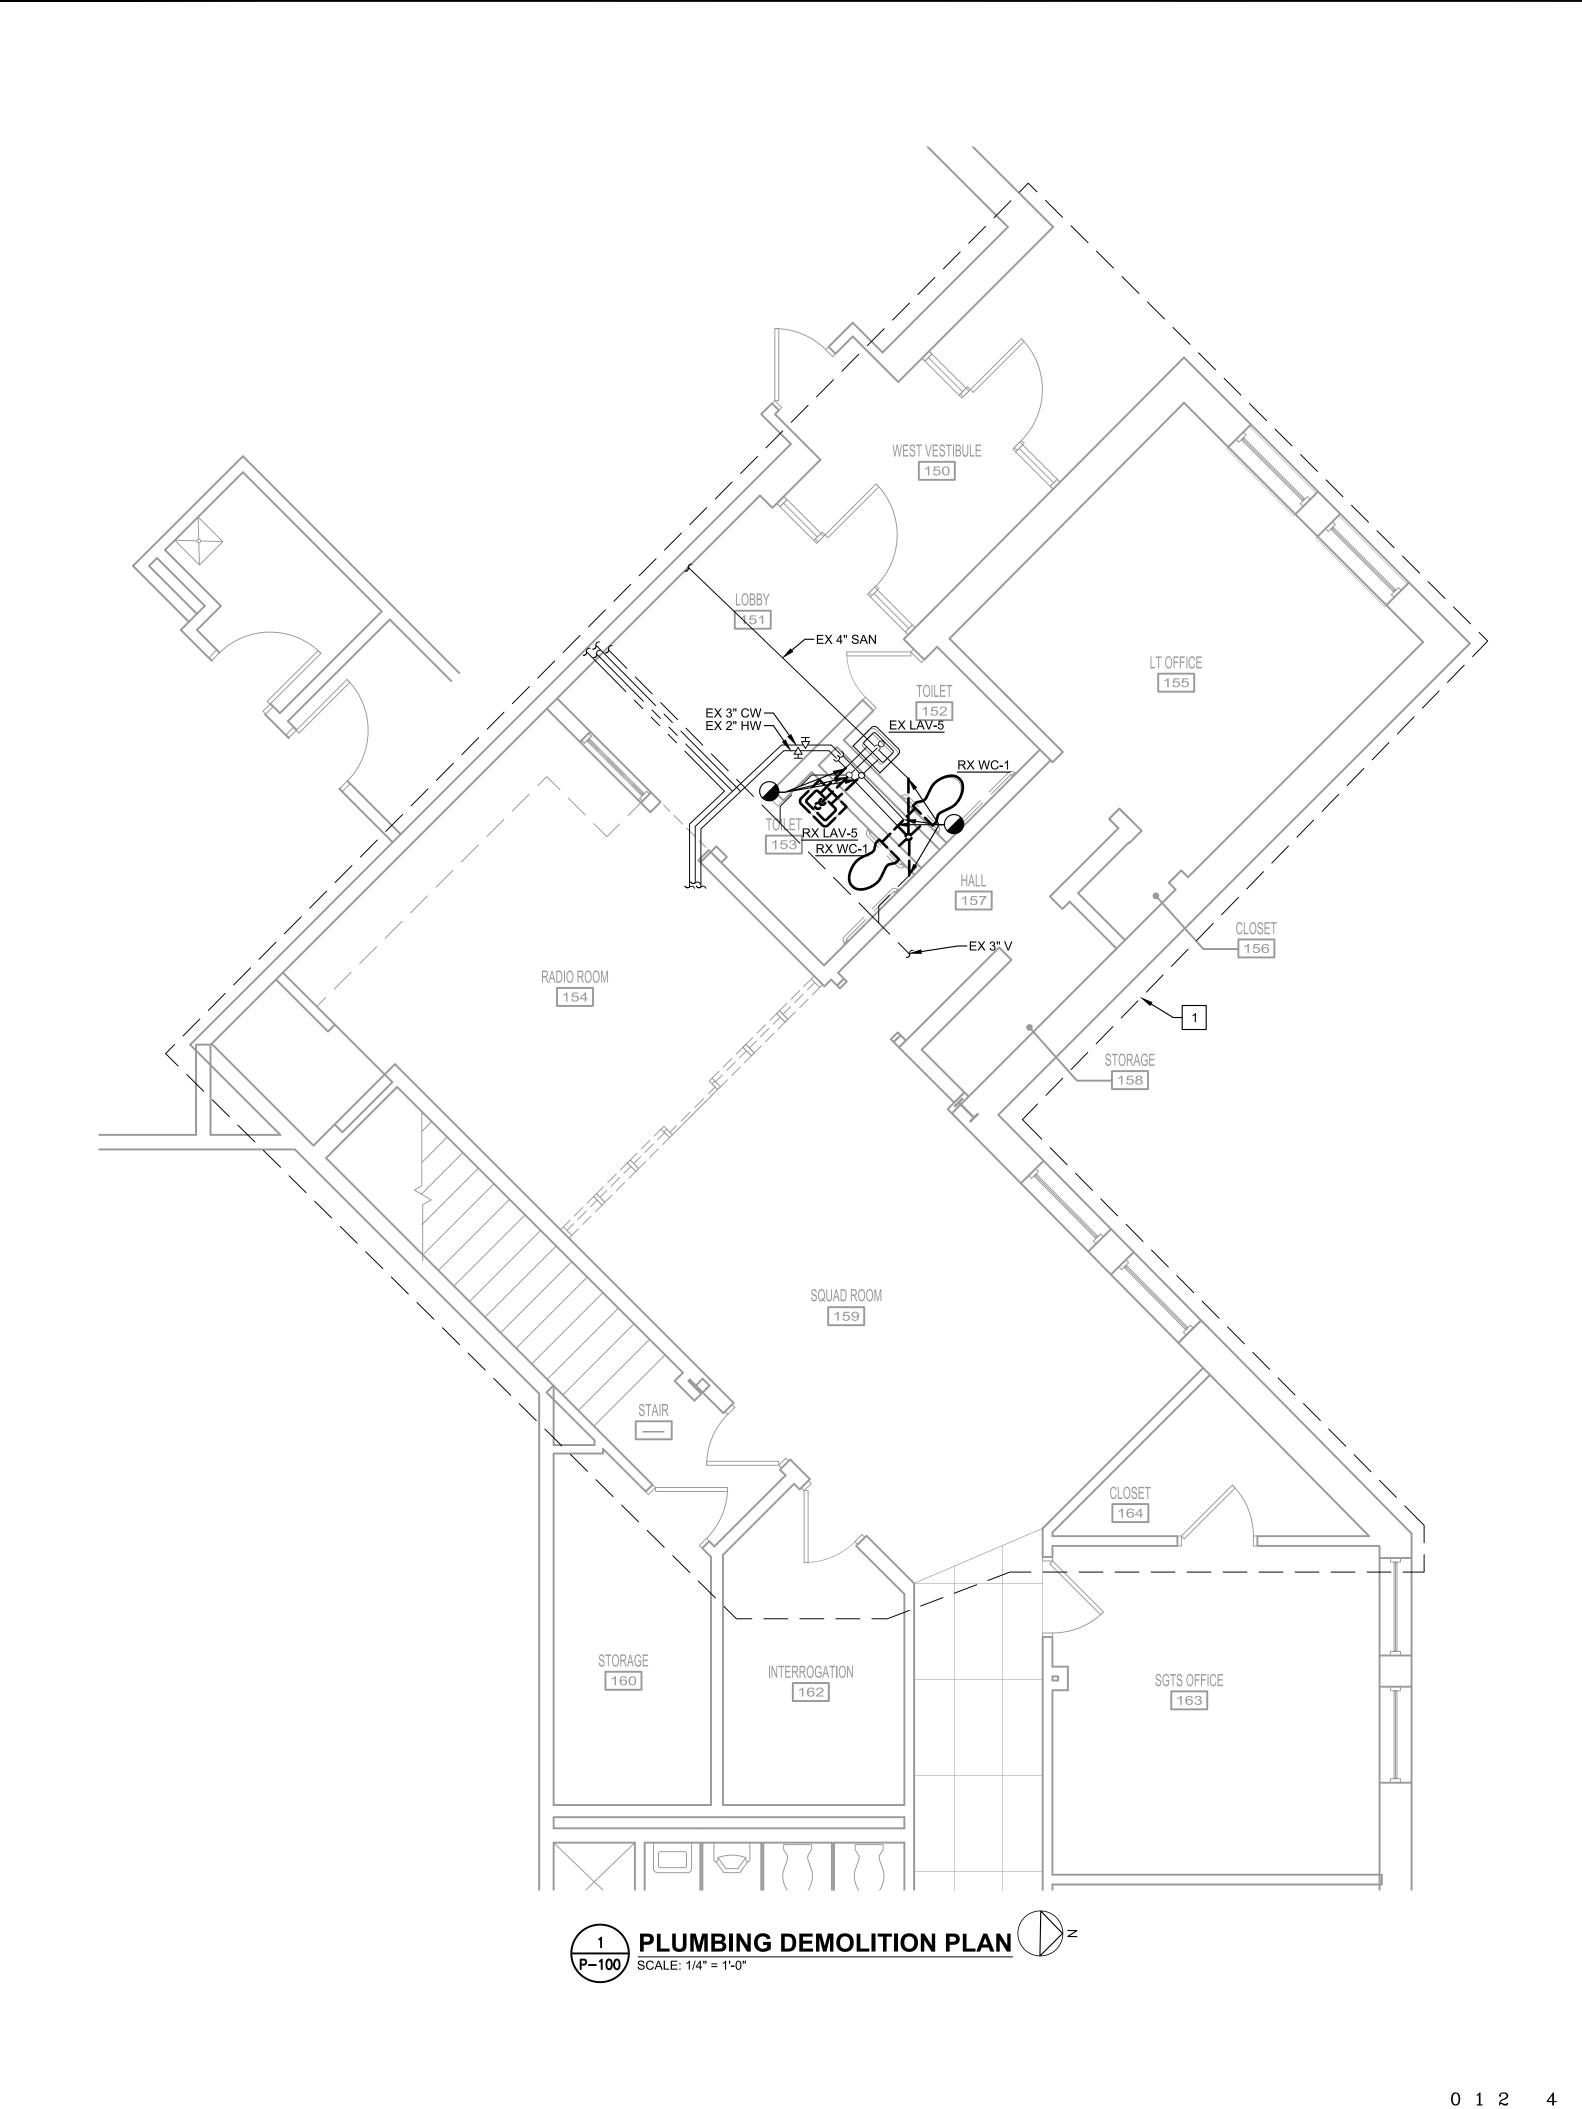

SPECIFIC NOTES: (APPLY TO THIS DRAWING WHERE INDICATED):

SEE GENERAL SPRINKLER NOTES FOR SCOPE OF SPRINKLER WORK IN THIS AREA.

DEMOLITION WORK SHALL BE DONE IN PHASES.
COORDINATE ALL WORK WITH NEW
INSTALLATIONS.





GRAPHIC SCALE 1/4" = 1'-0"




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CONTRACT NO. CMLF-C19-06
TERMINAL POLICE AND ADMINISTRATION
BUILDING - DISPATCH CENTER REHAB

REVISION			
NO.	DATE	DESCRIPTION	BY

PLUMBING	DEMOLITION			
PLAN				

DATE: JANUARY 2022 SCALE: AS NOTED SHEET NO. 17



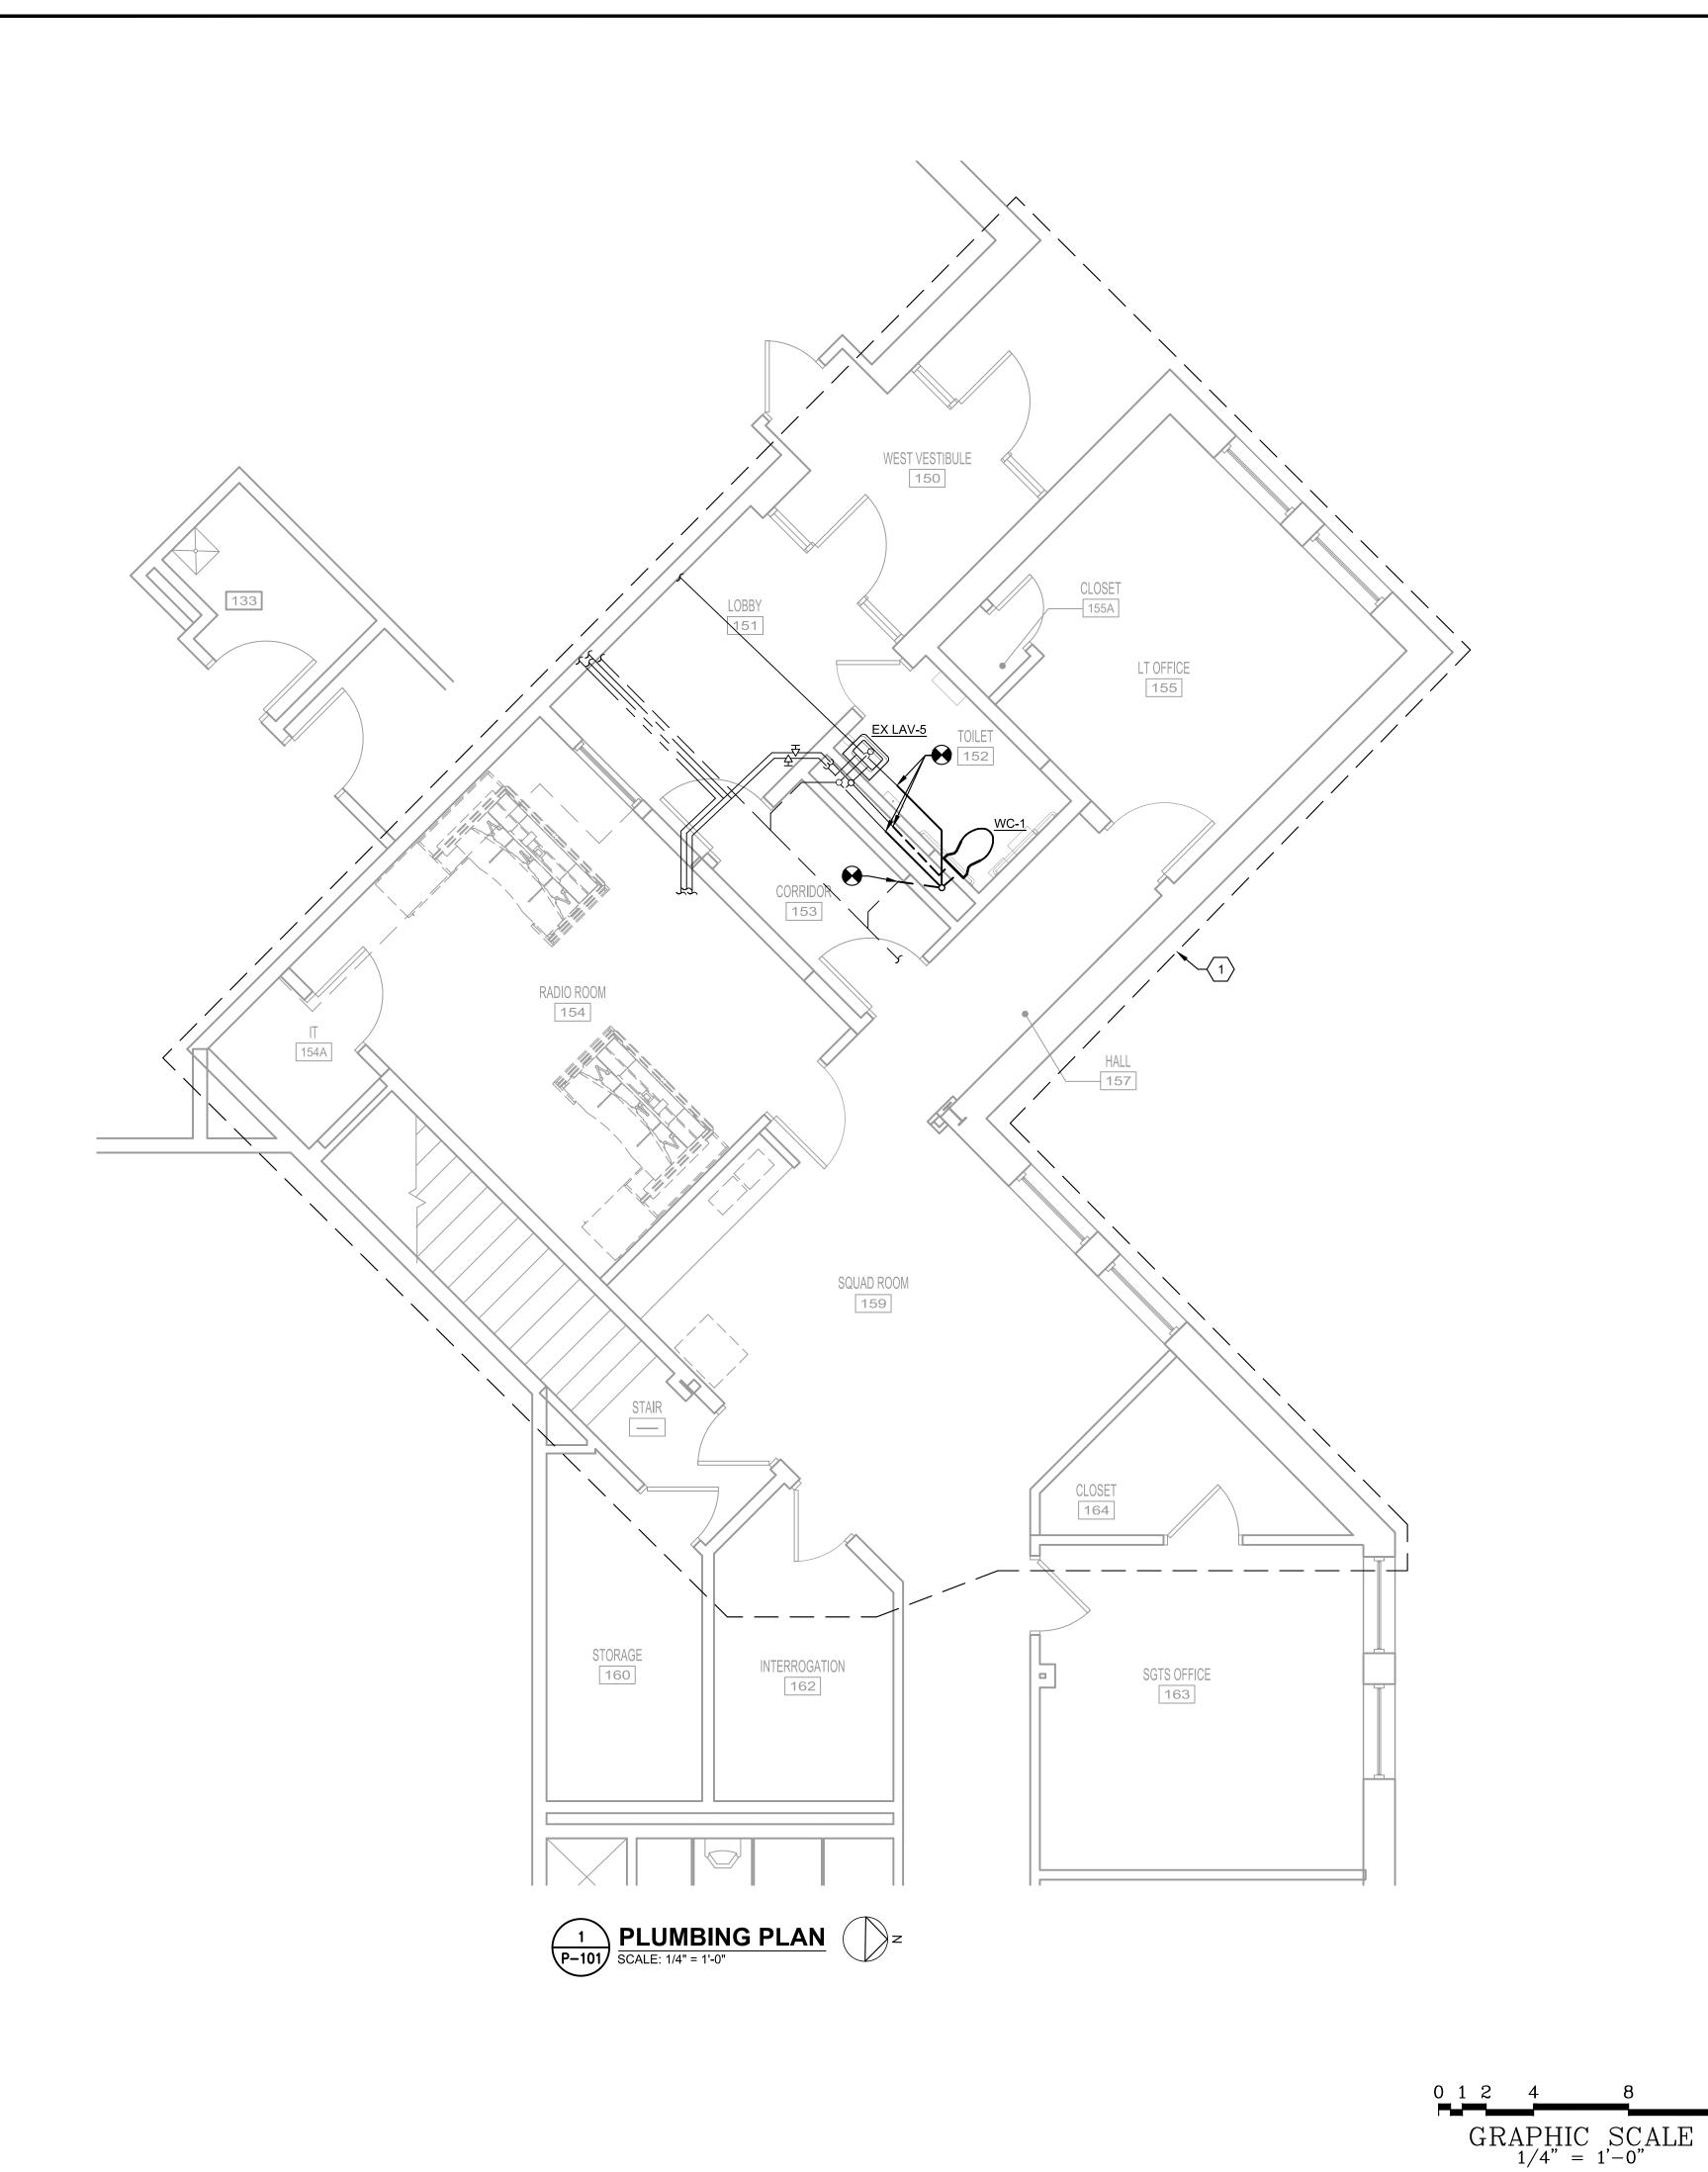

SEE GENERAL SPRINKLER NOTES FOR SCOPE OF SPRINKLER WORK IN THIS AREA.







DELAWARE RIVER AND BAY AUTHORITY
CAPE MAY — LEWES FERRY

CONTRACT NO. CMLF-C19-06
TERMINAL POLICE AND ADMINISTRATION
BUILDING - DISPATCH CENTER REHAB

REVISION				
NO.	DATE	DESCRIPTION	BY	
_				
+				

PLUMBING	PLAN

DATE: JANUARY 2022

			P-10	1
SCALE:	AS NOTED	SHEET NO.	18	