
POLICE DEPARTMENT RENOVATIONS AT THE MUNICIPAL BUILDING

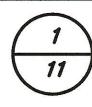

BLOCK 29, LOTS 7-10 & 17-23 #229 TRENTON AVENUE

BOROUGH OF BARRINGTON CAMDEN COUNTY, NEW JERSEY

General Notes:

- 1. Zoning district: C-1 (Central Commercial District)
- 2. Use group classification: I-3
- 3. 2018 International Building Code, New Jersey Addition, construction type classification: 3B-Unprotected
- 4. The Contractor shall submit and obtain a construction permit along with these plans and any plumbing and electrical plans prepared by the respective licensed profession, if required, by the Borough Subcode Official(s) (at the Contractor's cost). All permit fees shall be waived by the Borough.
- 5. The scope of responsibility of the engineer is limited to the work indicated on these drawings, and the engineer assumes no responsibility or liability for any other work on the site that is not indicated on
- 6. Contractor shall verify all conditions in the field and immediately notify the engineer of any discrepancies found between actual field conditions and those shown on these drawings prior to proceeding with any
- 7. Security: provide and maintain temporary barriers and other devices where appropriate or required by regulations to maintain general safety and to prevent public entry to the work area and to secure the work area from unauthorized entry. (No Specific Payment)
- 8. Shoring and bracing: provide adequate and appropriate temporary shoring and bracing as required to prevent structural failure of both existing and new building components during the entire course of the project. (No Specific Payment)
- 9. At the end of each work day, the contractor shall collect all rubbish, demolition and construction debris, and dispose of it in a dumpster or dump truck provided by the contractor for such purpose; when such dumpster or truck is full, the contractor shall have it removed and emptied in an appropriate and legal manner including disposal fees. Dumpster or dump truck shall be covered with tarp to secure at the end of each work day to prevent access. (No Specific Payment)
- 10. All materials and equipment shall be installed in accordance with manufacturer's instructions and
- 11. All concrete shall be Class 'B'.

All reinforced concrete shall be furnished and installed in accordance with the current ACTI-318 "Building Code Requirements" for reinforced concrete.

Reinforcing steel shall conform to ASTN-A615 grade 60. Welded wire fabric shall be 6x6-w1.4 x w1.4 conforming to ASTM A-185.

12. Concrete masonry unit (cmu) walls shall be hollow core load— bearing units (unless otherwise indicated on the drawings) conforming to ASTM C90; solid cmu shall conform to C145. All cmu walls to have truss type galvanized horizontal joint reinforcing, continuous in alternate courses.

Mortar shall meet requirements of ASTM C270 and as specified herein. Type m mortar shall be used for exterior walls below grade; type s mortar shall be used for walls and partitions above grade.

- 13. All construction shall be in strict conformance with the following codes/regulations, current edition and
- NJ State Uniform Construction Code - NJ Rehabilitation Subcode 5:23-6
- 2020 National Electrical Code
- NJ Uniform Fire Protection Subcode
- ICC/ANSI A117.1-2009 - 2018 IRC NJ Edition
- 2018 IBC NJ Edition - 2021 National Standard Plumbina Code
- 2021 International Mechanical Code - 2021 International Fuel Gas Code
- 2021 International Energy Code
- All Local Regulations and Ordinances
- NJ Barrier Free Subcode
- Federal Americans with Disabilities Act - NJ Department of Corrections NJSA Section 10A: A: 34-2.5 Cell Specifications
- 14. The security walls, windows and doors shall be constructed to meet or exceed ballistic U.L. level 3.
- 15. The detention cell and corridor shall be constructed in strict conformance with N.J.S.A. Chapter 34, N.J. Municipal Detention Facilities, current edition, Sections 10A: 34-2.5 Cell Construction Specifications and 10A: 34-2.6 Cell Equipment, Security Level 1.
- 16. The Contractor shall not be permitted to work on Saturdays, Sundays or holidays.
- 17. The Contractor's hours of operation shall be from 8:30 A.M. to 4:30 P.M.
- 18. The Contractor shall coordinate all construction activities with Chief Minardi and Lt. Pawling and/or the
- 19. The Contractor shall be solely responsible for performing all measurements and verifying all dimensions necessary prior to ordering any materials.
- 20. The Contractor shall coordinate his work with the Borough's I.T. Contractor (E3 IT Services) for the cabling/server room improvements and full access control for the 8 doors indicated on the Main Floor Improvement Plan with Proximity Key Fob (by others).

Utility Companies:

New Jersey American Water Company 204 Carriage Lane

Delran, NJ 08075 ATTN: Mr. John Graham, Jr. (856)-764-6920

Barrington Borough Sewer Department Public Works 100 Reamer Drive

ATTN: Mr. Michael Ciocco, C.P.W.M., Superintendent of Public Works (856)-547-2486

C.C.M.U.A.: Camden County Municipal Utilities Authority

1645 Ferry Avenue Camden, NJ 08104

ATTN: Mr Scott Schreiber, Executive Director (856)-583-1261

P.S.E.G. Services Corporation Gas Distribution Department 535 Nicholson Road Audubon, NJ 08106 ATTN: Mr. Ryan Morze (609)-381-0530

P.S.E.G. Services Corporation Construction Inquiry Center 410 Route 130 South Bordentown, NJ 08505 1-800-832-0076

Comcast Cable Communications, Inc. 1250 Haddonfield-Berlin Road Post Office Box 5025 Cherry Hill NJ 08034 ATTN: Mr. Wyatt Parrish (484)-368-4391

Verizon 10 Tansboro Road Berlin NJ 08009 ATTN: Mr. Ed Gasko (856)-306-8592

Index of Sheets								
Sheet Number	Sheet Title							
1	Cover Sheet							
2	Demolition Plan							
3	Main Floor Improvement Plan							
4	Restrooms Floor Plan							
5	Detention Cell Demolition Plan							
6	Detention Cell Improvement Plan							
7	Dispatch Office Security Wall Improvements							
8 Processing Room Security Wall Improveme								
9	Electrical Plan							
10	Plumbing Plan							
11	Sections and Details							

Construction Schedule


The following construction schedule is anticipated:

- Award of Contract: October 10, 2023
- Preconstruction Meeting: October 24, 2023

Shop Drawings/Materials: 49 Calendar Days or 7 Weeks

- Commence with Construction: December 20, 2023
- Complete Construction: April 17, 2024

The construction schedule has been developed to ensure the completion of the project in a timely manner. However, it is understood that due to unforeseen circumstances (i.e. material/equipment lead times), the construction schedule is subject to change.

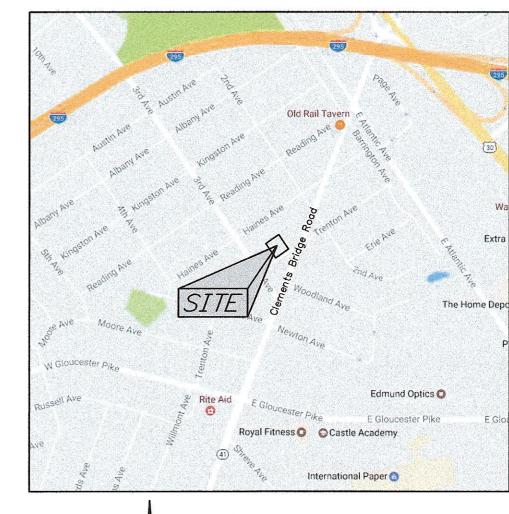

Key Map SCALE: 1" = 800' TAKEN FROM GOOGLE MAPS

<u>List of Quantities:</u>

ITEM NUMBER	DESCRIPTION	UNIT	QUANTITY
1	DEMOLITION, COMPLETE	L.S.	L.S.
2	REMOVE ASBESTOS CONTAINING MATERIAL (ACM), COMPLETE	S.F.	700
3	RECREATION CENTER CONVERSION IMPROVEMENTS, COMPLETE	L.S.	L.S.
4	PROCESSING ROOM IMPROVEMENTS, COMPLETE	L.S.	L.S.
5	DETENTION CELL AND CORRIDOR IMPROVEMENTS, COMPLETE	L. S.	L. S.
6	WOMEN'S LOCKER ROOM IMPROVEMENTS, COMPLETE	L.S.	L.S.
7	MEN'S LOCKER ROOM IMPROVEMENTS, COMPLETE	L.S.	L.S.
8	DETECTIVE'S OFFICE IMPROVEMENTS, COMPLETE	L.S.	L.S.
9	EVIDENCE/INTERVIEW ROOM IMPROVEMENTS, COMPLETE	L.S.	L.S.
10	SERGEANT'S OFFICE IMPROVEMENTS, COMPLETE	L.S.	L.S.
11	PARKING AREA IMPROVEMENTS, COMPLETE	L.S.	L.S.

1. 08/30/23 GENERAL REVISIONS DRWN. CHKD. REV. DATE: DESCRIPTION Cover Sheet Police Department Renovations At The Municipal Building


> 229 Trenton Avenue Borough of Barrington Camden County, New Jersey


 DATE: 05/15/23
 DRAWN BY: T.D.
 CHKD. BY:
 SCALE: AS NOTED


 PROJECT No. 11-411BR1116
 FIELD BOOK/PAGE:
 SHEET No. 1 OF 11

GREGORY BLASE FUSCO PROFESSIONAL ENGINEER

PA.PE No. 036608-E NJ PROFESSIONAL PLANNER No. 4076

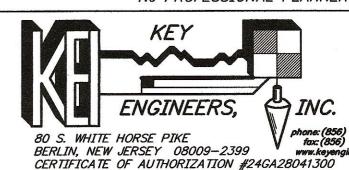

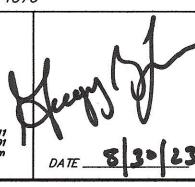

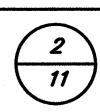


Demolition Notes:


- 1. ALL DEMOLITION MATERIALS SHALL BE PROPERLY AND LAWFULLY DISPOSED OF AT A LAWFUL FACILITY INCLUDING TRANSPORTATION AND DISPOSAL FEES. ALSO, ANY RECYCLABLE MATERIALS SHALL BE DISPOSED OF AT A RECYCLING FACILITY INCLUDING TRANSPORTATION AND DISPOSAL FEES AND THE TONNAGE MUSI BE REPORTED TO THE BOROUGH CLERK AND/OR RECYCLING COORDINATOR.
- 2. ALL ASBESTOS CONTAINING MATERIAL (ACM) SHALL BE LAWFULLY REMOVED, CONTAINED AND DISPOSED OF AT A LAWFUL FACILITY.
- 3. ALL ITEMS SCHEDULED TO BE RELOCATED SHALL BE CAREFULLY REMOVED AND STORED UNTIL THEY AREA RELOCATED. ANY ITEMS THAT ARE DAMAGED SHALL BE REPLACED BY THE CONTRACTOR AS HIS EXPENSE.
- 4. EXISTING TOILET, FLOOR, URINAL AND SINK DRAIN PIPING SHALL BE FIELD LOCATED BY THE CONTRACTOR AT HIS EXPENSE. THE CONCRETE FLOOR AREA OVER THE EXISTING DRAIN PIPING SHALL BE SAWCUT AND REMOVED BY THE CONTRACTOR AND ALL EXISTING DRAIN PIPING SHALL BE REMOVED AND PROPERLY TERMINATED (CAPPED) AT THE MAIN SERVICE LATERAL.
- 5. EXISTING DOMESTIC WATER PIPING FOR TOILETS, SINKS AND URINALS SHALL BE REMOVED FROM THE FIXTURES AND SHALL BE PROPERLY TERMINATED (CAPPED) ABOVE THE CEILING LINE.
- 6. EXISTING WOOD FRAME WALLS TO BE REMOVED SHALL BE DEMOLISHED FROM THE FLOOR TO THE CEILING AND SHALL BE NEATLY TERMINATED AT EXISTING WALL LOCATIONS THAT WILL REMAIN.

Wall Legend:


KEYED TO THIS SHEET ONLY

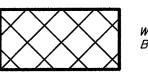

WOOD FRAME OR MASONRY WALL TO BE CONSTRUCTED IN DOOR OPENING

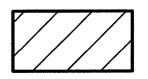

REMOVE WALLS AS NECESSARY TO CREATE OPENING OR REMOVE WINDOW AND CONSTRUCT WOOD FRAME WALL

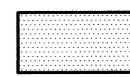

REMOVE ACM

Electrical Legend:

KEYED TO THIS SHEET ONLY

EXISTING 20 AMP RECEPTACLE

EXISTING 20 AMP RECEPTACLE TO BE RELOCATED

EXISTING SWITCH

EXISTING SWITCH TO BE RELOCATED


ETHERNET JACK

TELEPHONE JACK

LIGHT LIGHT

LIGHT

LIGHT TO BE RELOCATED

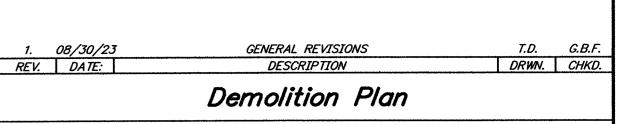

Police Department Renovations
At The Municipal Building
229 Trenton Avenue


Borough of Barrington Camden County, New Jersey

 DATE: 05/15/23
 DRAWN BY: T.D.
 CHKD. BY:
 SCALE: 3/16" = 1'


 PROJECT No. 11-411BR1116
 FIELD BOOK/PAGE:
 SHEET No. 2 OF 11


GREGORY BLASE FUSCO

PROFESSIONAL ENGINEER
PE No. 32853 PA.PE No. 036608-E
NJ PROFESSIONAL PLANNER No. 4076

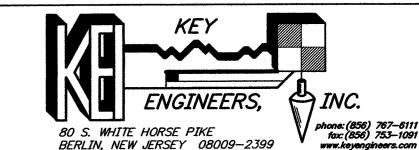

CERTIFICATE OF AUTHORIZATION #24GA28041300

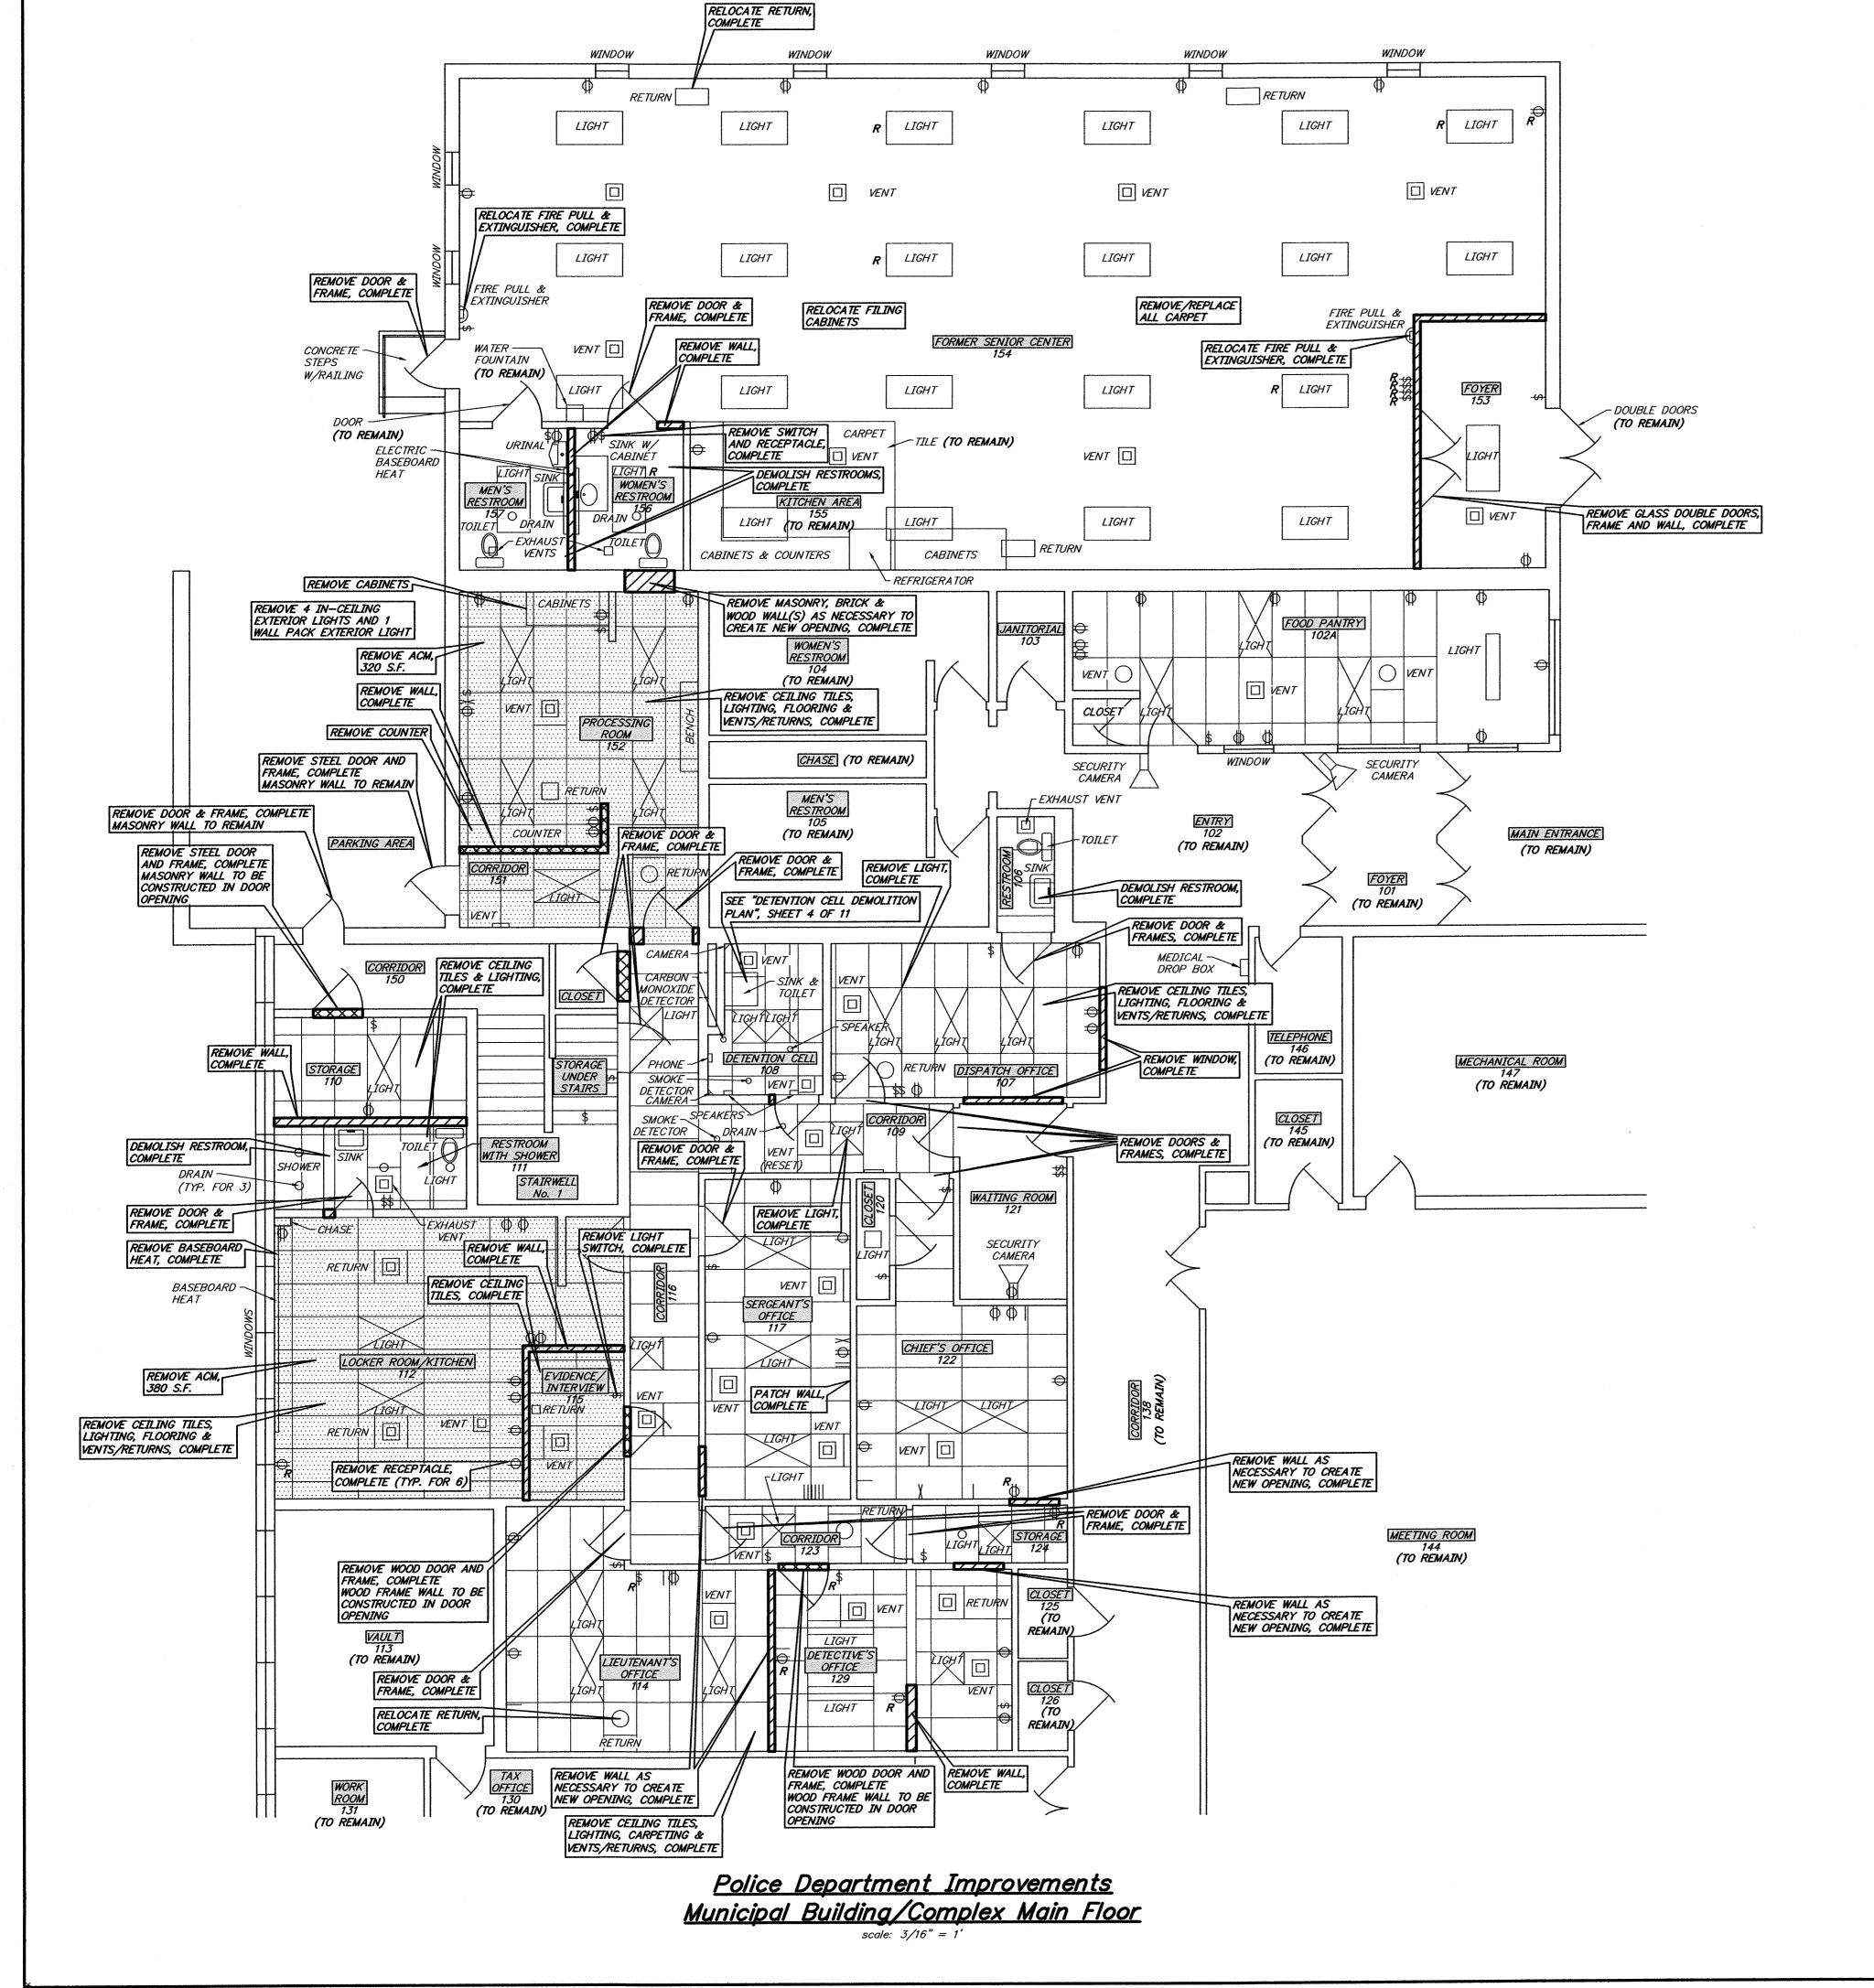

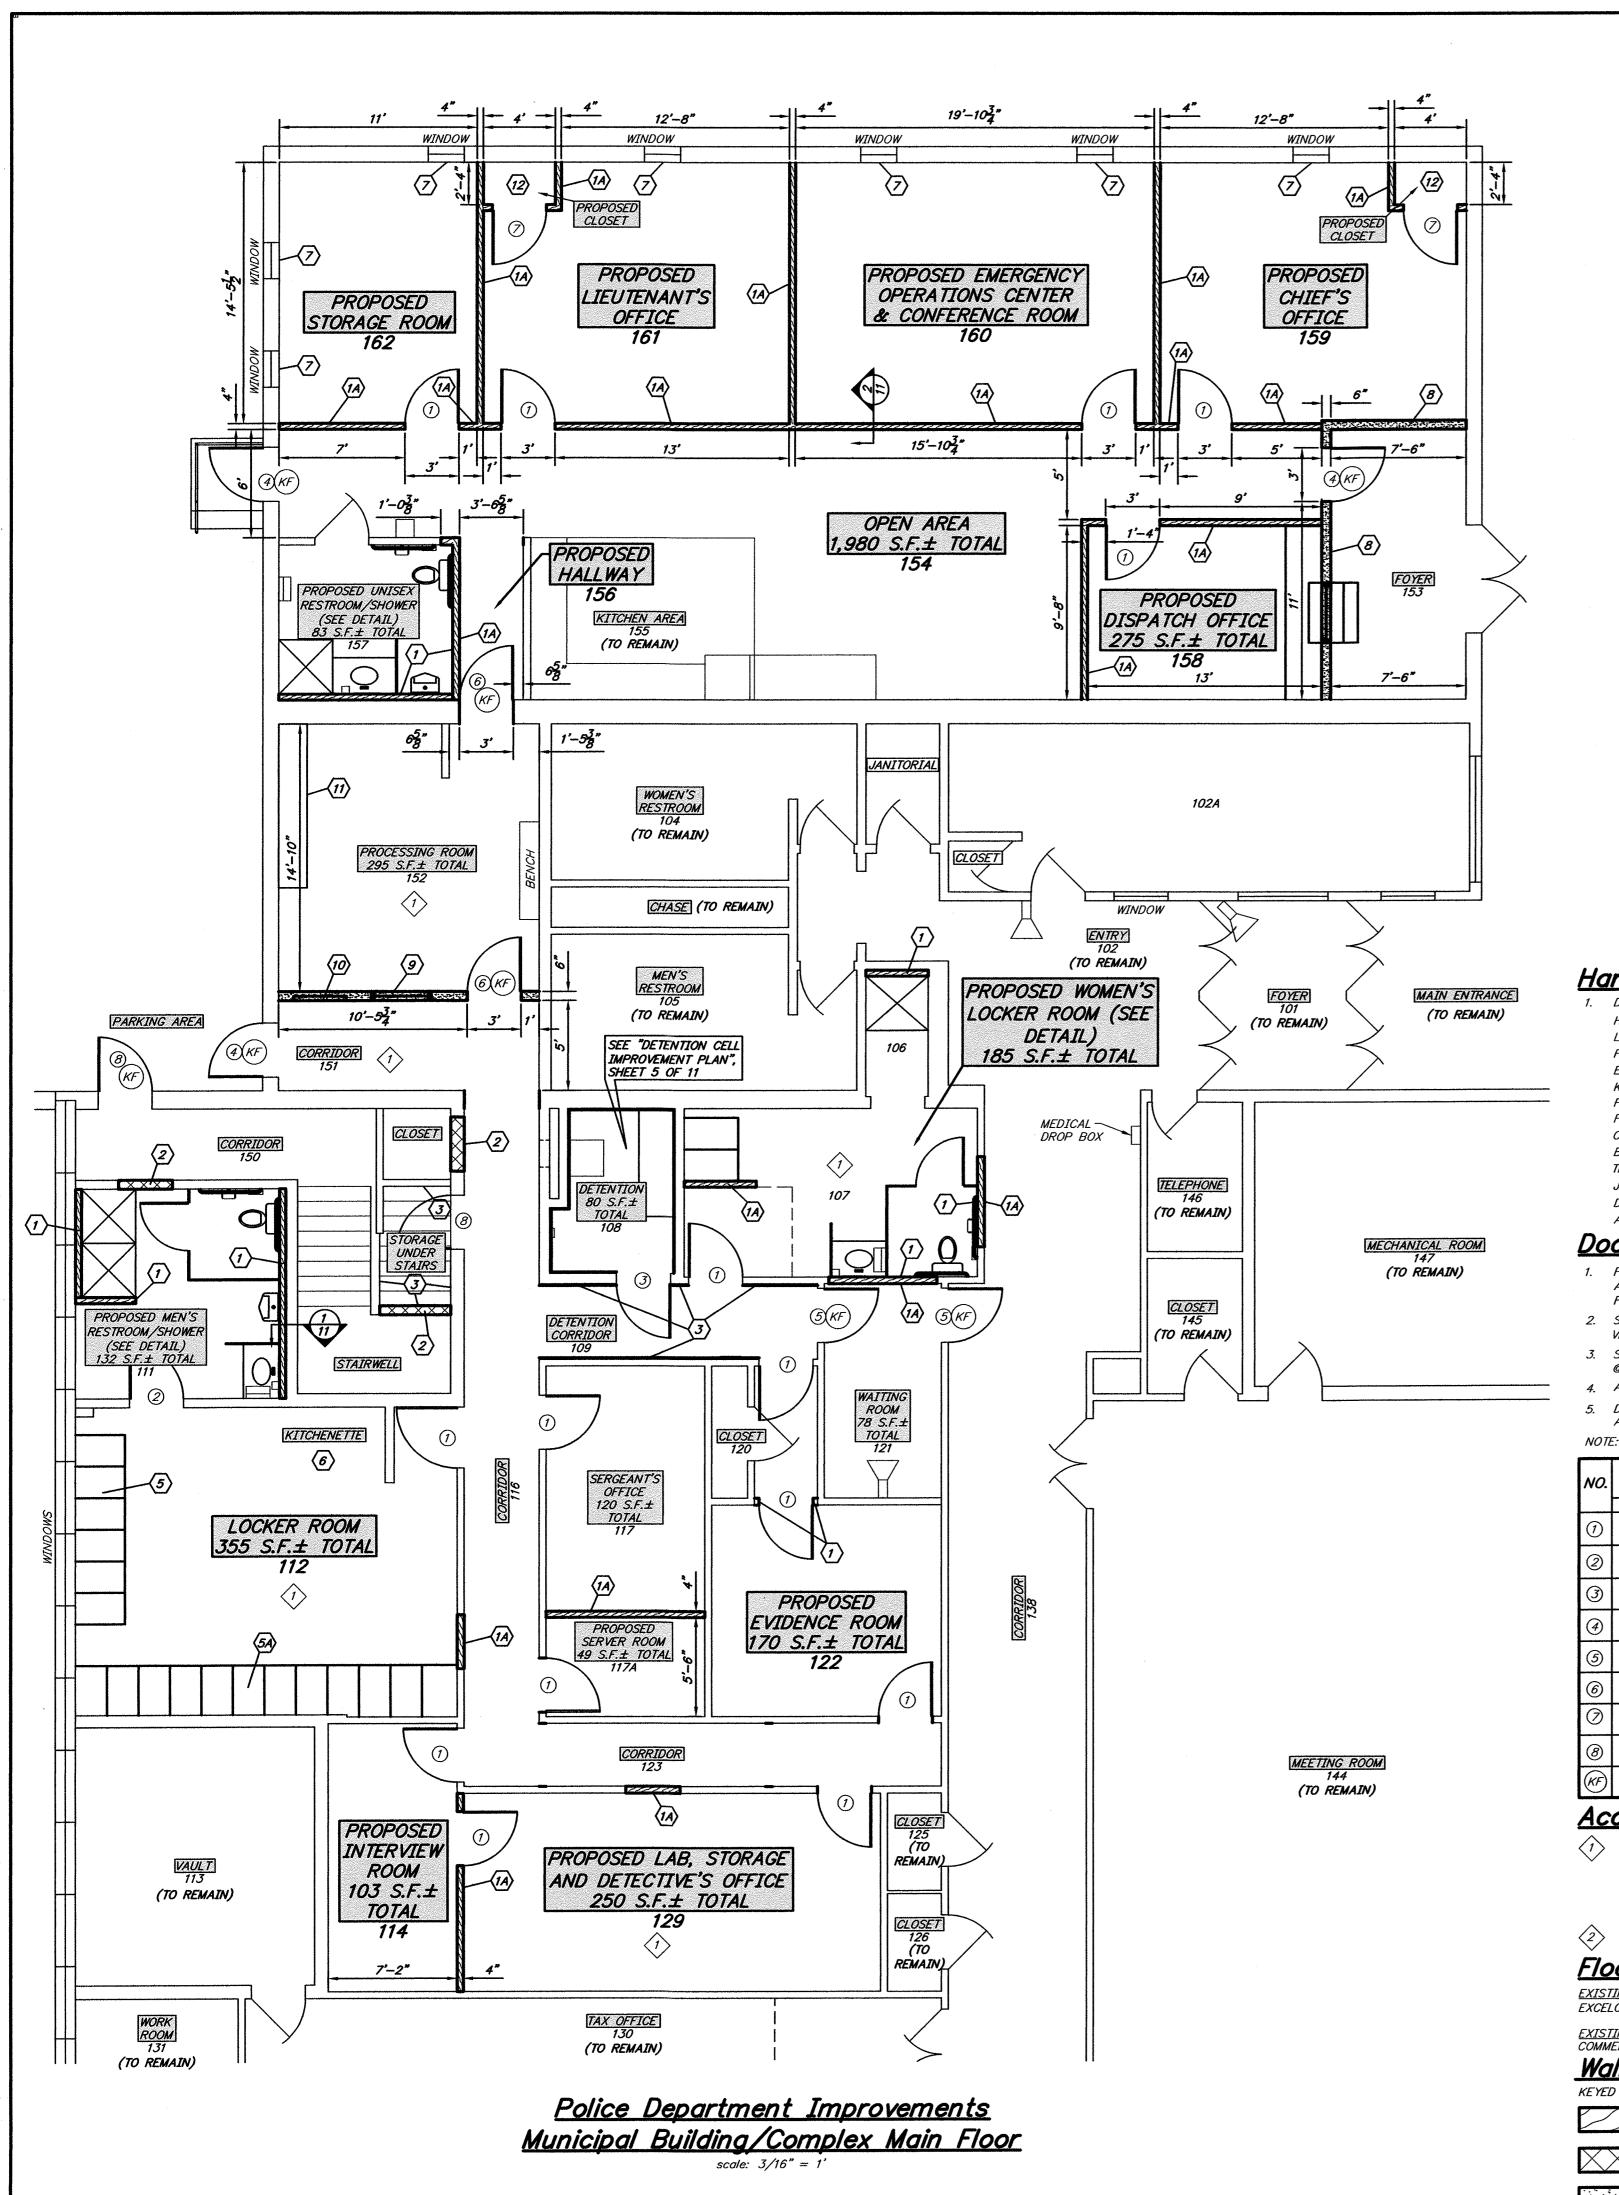

ROOM NUMBER	ROOM NAME		FLOOR		BA	ISE	WALLS				CEI	LING		A.C.M.	NOTES		
									_								
									PATCHED AND PAINTED EXISTING GYPSUM BOARD				0	DED.	 		
		4	La la	l			S		N 7E BO				PAINTED	SUSPENDED	PAINTED STEEL PLATE TRUSSDECK CEILING		
		GRADE	240	7E 71	35	747	M	\$	ZAI		PANELS		241	ldS/	12/5		
		1, 8	£7	Ş	BASE	Fil.	S M	SS	101	AND BLOCK	4%				75.11		
		XX	14L 4RF	8	77	8	SZ	S	€0	8 A	•		AND	74	S X		
		12,	COMMERCIAL GRADE NYLON CARPET	PAINTED CONCRETE	WALL	1/	ED	20	#ED	PATCHED PAINTED	WALL	EXISTING	РА ТСНЕО	12/2	ED	REMOVAL	
		7.1	0 2 2	<u>%</u>	ž	SE	1V7 4 7E	1×1	757.	55€	0	157.	5	199	IN1	10%	
		V.C.T. 12"X12' COMMERCIAL	85	4	VINY	CARPET COVE WALL BASE	PAINTED STEEL PLATE TRUSS WALLS	P 9	27	94	FRP	Ä	4	ACOUSTICAL CEILING	28	RE	
101	FOYER		-	 	 		 	 _		 	ļ			 	 	 	TO REMAIN
102	ENTRY		 	 	 	 	-	 -		 	 	 		 	 	+	TO REMAIN
102A	FOOD PANTRY	 -	 	 	 	 -	 -			 	 		 	 	 	 	TO REMAIN
103	JANITORIAL		 	 	I	 				†				†	†	 	TO REMAIN
104	WOMEN'S RESTROOM														1		TO REMAIN
105	MEN'S RESTROOM			1	1	1									1		TO REMAIN
106	RESTROOM/WOMEN'S	•			•						•			•			INTERIOR OF ROOM TO BE COMPLETELY REMODELED
107	DISPATCH OFFICE/WOMEN'S LOCKER ROOM		•			•		•	•	•				•			INTERIOR OF ROOM TO BE COMPLETELY REMODELED, INCLUDES PAINTING THE EXTERIOR WALLS WHERE THE WINDOWS ARE REMOVED IN ROOM NO.'S 121 &
108	DETENTION CELL			•			•								•		TO BE COMPLETELY REMODELED TO PROVIDE COMPLIANCE
109	CORRIDOR						•								•		TO BE COMPLETELY REMODELED TO PROVIDE COMPLIANCE
110	STORAGE																TO BE DEMOLISHED AND INCORPORATED INTO ROOM NO. 111
111	RESTROOM WITH SHOWERS	•			•	<u></u>	<u></u>				•			•	ļ		
112	LOCKER ROOM/KITCHEN	•	<u></u>	ļ	•	<u> </u>		ļ		•				•	<u> </u>	•	
113	VAULT		ļ	ļ	ļ	ļ		ļ		ļ	ļ		ļ		ļ	 	TO REMAIN
114	LIEUTENANT'S OFFICE/INTERVIEW ROOM	ļ	•		ļ	•	ļ	•	•	ļ		ļ		<u> </u>	 	 	TO BE REDUCED IN SIZE W/PROPOSED WALL TO BE COMPLETELY DEMOLISHED AND INCORPORATED INTO ROOM NO. 112
115	EVIDENCE/INTERVIEW		ļ	 	 	ļ		<u> </u>	<u> </u>	<u> </u>	ļ			ļ	 	•	ENTIRE CORRIDOR TO BE REPAINTED
116	CORRIDOR		<u> </u>		<u> </u>	 	ļ	•	•	•	 	<u> </u>	ļ	-	├	 	INTERIOR OF ROOM TO BE COMPLETELY REMODELED
117 117A	SERGEANT'S OFFICE SERVER ROOM		•	-		•	 -	•	•	<u> </u>	 	_	<u></u>	•	╁──	 	INTERIOR OF ROOM TO BE COMPLETELY REMODELED
117A 120	CLOSET		-	 	 	-		_		 				-	┼	 	TO REMAIN
121	WAITING ROOM		<u> </u>	 	 	 	 		•	 				<u> </u>	<u> </u>	 	10 ALMILIA
122	CHIEF'S OFFICE/EVIDENCE ROOM		l	 	 -			<u> </u>	•	<u> </u>				†	 	†	
123	CORRIDOR			!	 			•	•	 		<u> </u>		•	 	†	ENTIRE CORRIDOR TO BE REPAINTED
124	STORAGE			1				•	•						T		TO BE DEMOLISHED
125	CLOSET																TO REMAIN
126	CLOSET																TO REMAIN
129	DETECTIVE'S OFFICE		•			•		•	•								TO REMAIN
150	CORRIDOR							•						•			
151	CORRIDOR	•			•	_				ļ		_		ļ	<u> </u>	•	ENTIRE CORRIDOR TO BE COMPLETELY REMODELED
152	PROCESSING ROOM	•	 	ļ	•	ļ	ļ	•	•		ļ	ļ		•	 	•	ENTIRE ROOM TO BE COMPLETELY REMODELED
153	FOYER			ļ	ļ	ļ				ļ				ļ	 	_	TO REMAIN
154	FORMER SENIOR CENTER/OPEN AREA		•		ļ	•	ļ		•					<u> </u>	 	ļ	KITCHEN AND FLOOR TO REMAIN AND ENTIRE CEILING TO BE REPAINTED
155 156	KITCHEN AREA			ļ	<u> </u>	<u> </u>	 			 	ļ	 		 	 	 	KITCHEN AND FLOOR TO REMAIN RESTROOM TO BE DEMOLISHED AND CONVERTED TO HALLWAY
156	WOMEN'S RESTROOM/HALLWAY	<u> </u>		 	 _	 				•	 	_	ļ	•	 	 	RESTROOM TO BE DEMOLISHED AND CONVERTED TO A UNISEX RESTROOM
157	MEN'S RESTROOM/UNISEX RESTROOM	•	•	ļ	•	-	 -	•	•	 	 	 		•	 	 	NESTROOM TO BE DEMOLISHED AND CONVERTED TO A UNISEA RESTROOM
158 159	DISPATCH OFFICE CHIEF'S OFFICE		•	 	 	•		•	•	 	 -			•	 	 	
160	E.O.C./CONFERENCE ROOM	 -	•	 	 	•		•	•	 	 			•	 	 	
161	LIEUTENANT'S OFFICE		•	 	 	•	 	•	•	 				•	 	†	
162	STORAGE ROOM		•	 	 	•	-	•	•	 	-			•	 	 	

Hardware Schedule: DOOR HARDWARE OR EQUIVALENT:

HINGE - (3) $4\frac{1}{2}$ " X $4\frac{1}{2}$ " STANDARD WEIGHT HINGES SUPPLIED WITH DOOR

LOCKSET - YALE 8800, AU LEVER, (SATIN CHROME FINISH) OR 8891(FL), FAIL SAFE, 12v AU LEVER, (SATIN CHROME FINISH) WHERE KEY

FOB KEYLESS ENTRY IS PROPOSED. EXIT DEVICES - YALE 7130-K5(F), (SATIN CHROME FINISH) WITH 8891(FL), FAIL SAFE, 12v AU LEVER, (SATIN CHROME FINISH) WHERE

KEY FOB KEYLESS ENTRY IS PROPOSED. FUNCTION - ENTRY ALL KEYED ALIKE

FINISH - SATIN CHROME PLATE CLOSER - YALE 3301 (SATIN CHROME FINISH)

BUMPER - 1 WALL BUMPER

THRESHOLD - PEMKO 171A (EXTERIOR EXIT DOORS) JAMB/HEAD WEATHERSTRIP - PEMKO 303AS W/53 (EXTERIOR EXIT DOORS)

DOOR SWEEP - PEMKO 18062AP (EXTERIOR EXIT DOORS) ALL DOOR HARDWARE SHALL BE A.D.A. AND NEW JERSEY BARRIER-FREE COMPLIANT

Door & Frame Notes:

- 1. FRAMES TO BE MIN. 12 GA., GALVANIZED STEEL, W/WELDED CORNERS, 5 3/4" DEPTH, 2" JAMB FACE, 4" HEAD FACE; PROVIDE MIN. 3 MASONRY JAMB ANCHORS PER JAMB: REINFORCE ALL AREAS TO RÉCEIVE HARDWARE: PRÓVIDE MORTAR BOXES, WELDED TO FRAMES AT ALL CUTOUTS (FRAMES TO BE 6) MALVERN ADA SINK BASE KITCHEN CABINET, MODEL NO. BSH36-MLGR (HERON GRAY) & MALVERN WALL KITCHEN CABINET, FILLED SOLID WITH MORTAR). PROVIDE THE APPROPRIATE CONCRETE LINEAL WHERE NECESSARY.
- 2. SECURITY DOORS TO BE FLUSH, HOLLOW METAL, SECURITY TYPE, CURRIES 847 SERIES W/ LITE (OR EQUIVALENT) UL LEVEL 3, CORES TO HAVE VERTICAL 18 GAUGE STEEL RIBS @ MAX. 6" OC. AND FILLED WITH MINERAL FIBER OR FIBERGLASS INSULATION.
- 3. STANDARD DOORS TO BE FLUSH, HOLLOW METAL, CURRIES 747 SERIES W/ LITE (OR EQUIVALENT), CORES TO HAVE VERTICAL 22 GAUGE STEEL RIBS @ MAX. 6" OC. AND FILLED WITH MINERAL FIBER OR FIBERGLASS INSULATION.
- ALL DOORS AND FRAMES SHALL BE 3 HOUR FIRE RATED.
- DOORS AND FRAMES TO BE FACTORY PRIMED; FIELD APPLY FINISH PAINT: 2 COATS OF SHERWIN-WILLIAMS GLOSS EXTERIOR ACRYLIC LATEX A-100 AND SEMI-GLOSS INTERIOR ACRYLIC LATEX SUPER PAINT OR APPROVED EQUIVALENT.

NOTE: ALL ITEMS SPECIFIED ARE OR APPROVED EQUIVALENT.

NO.	SIZE		SIZE		SIZE		GAUGE	FIRE RATING	HARDWARE SET NO.	REMARKS	
	WIDTH	HEIGHT	THICKNESS								
1	3'-0"	6'-8"	1 3/4"	HOLLOW METAL	14 GAUGE	-	1	CURRIES 747 SERIES OR EQUIVALENT			
2	3'-0"	6'-8"	1 3/4"	HOLLOW METAL	14 GAUGE	-	1	CURRIES 747 SERIES W/20"X20" VENT PANEL OR EQUIVALENT			
3	3'-0"	6'-8"	2"	HOLLOW METAL	12 GAUGE	_	FACTORY	SECURITY LEVEL 1 W/ TRUSSBILT FP—G3 CUFF PORT/FOOD PASS AND FOLGER ADAM 17 LATCH			
4	3'-0"	6'-8"	1 3/4"	HOLLOW METAL	UL LEVEL 3	_	1 W/ EXIT DEVICE	CURRIES 847 SERIES WITH 6"X36" LITE, UL LEVEL 3 OR EQUIVALENT			
⑤	3'-0"	6'-8"	1 3/4"	HOLLOW METAL	14 GAUGE	-	1 W/ EXIT DEVICE	CURRIES 747 SERIES WITH 6"X36" LITE OR EQUIVALENT			
6	3'-0"	6'-8"	1 3/4"	HOLLOW METAL	UL LEVEL 3	_	1	CURRIES 847 SERIES WITH 6"X36" LITE, UL LEVEL 3 OR EQUIVALENT			
Ø	3'-0"	6'-8"	1 3/8"	COMPOSITE			1	MANUFACTURED BY JELD-WEN OR EQUIVALENT			
8	3'-0"	6'-8"	1 3/4"	HOLLOW METAL	UL LEVEL 3	_	1	CURRIES 847 SERIES, UL LEVEL 3 OR EQUIVALENT			
(KF)											

Acoustical Suspended Ceiling System Schedule:

1 ALL CEILING TILES AND GRID WHERE INDICATED SHALL BE REPLACED WITH: ACOUSTICAL PANEL STANDARD - FS SS-S-118

TILES - ACOUSTIC MINERAL FIBER CEILING TILE, CIRRUS OPEN PLAN (4'X2' PANELS) BY ARMSTRONG MODEL NO. 556 OR EQUIVALENT METAL DIRECT-HUNG SUSPENSION SYSTEMS - DIRECT-HUNG SYSTEMS, ROLLED-FORMED FORM PREFINISHED COLD-ROLLED STEEL

SHEET, WITH HANGER WIRE, ATTACHMENT DEVICES AND EDGE MOLDINGS AND TRIM

NEW ACOUSTICAL SUSPENDED CEILING TO BE CONSTRUCTED WITHIN EXISTING AND NEW PROPOSED WALL LINES.

(2) LIGHTING - L.E.D. (SEE ELECTRICAL PLAN)

Flooring:

EXISTING TILED AREA OR PROPOSED RESTROOM(S), LOCKER ROOMS & PROCESSING ROOM/CORRIDOR(S)

EXCELON IMPERIAL TEXTURE V.C.T. 12"X12" COMMERCIAL TILES WITH VINYL WALL BASE BY ARMSTRONG OR EQUIVALENT. STANDARD COLOR AND TEXTURE TO BE SELECTED BY BOROUGH.

EXISTING CARPETED AREAS
COMMERCIAL GRADE NYLON CARPET WITH CARPET COVE WALL BASE BY MOHAWK OR SHAW OR EQUIVALENT. STYLE AND COLOR SIMILAR TO THE EXISTING TO BE SELECTED BY THE BOROUGH.

Wall Legend:

KEYED TO THIS SHEET ONLY PROPOSED 2"X4" WOOD FRAME WALL

PROPOSED C.M.U. WALL

PROPOSED 2"X6" WOOD FRAME WALL W/U.L. LEVEL 3 AND FIRRING

REPRODUCTION, ALTERATION AND AMENDMENT OF THIS PLAN SHALL BE PERFORMED ONLY BY KEY ENGINEERS, INC. AND SHALL BE PERFORMED UNDER THE ABSOLUTE DIRECTION OF THE LICENSED PROFESSIONAL WHOSE NAME AND SIGNATURE APPEARS HEREON.

Legend:

KEYED TO THIS DRAWING ONLY CONSTRUCT 2"X4" WOOD FRAME WALL W/R-13 INSULATION WITH PRIMED AND PAINTED 1/2" THICK DRYWALL ONE OR

CONSTRUCT 2"X4" WOOD FRAME WALL W/R-13 INSULATION WITH PRIMED AND PAINTED 5/8" THICK DRYWALL ONE OR BOTH SIDES

(2) CONSTRUCT C.M.U. WALL

CONSTRUCT 12 GAUGE STEEL PLATE TRUSSWALLS AND TRUSSDECK CEILING, COMPLETE, MANUFACTURED BY TRUSSBILT,

TOILET/URINAL PARTITION SYSTEM W/FLOOR TO CEILING PILASTERS TO BE MANUFACTURED BY GENERAL PARTITION, HIGH

DENSITY POLYMER 60 SERIES & FBS-7 OVER GALVANIZED STEEL FLOOR MOUNT WITH OVERHEAD BRACE AND COMPONENTS OR EQUIVALENT. STANDARD COLOR AND TEXTURE TO BE SELECTED BY OWNER.

(5) PERSONAL STORAGE LOCKER MODEL FPPL-242461 BY FASCO OR EQUIVALENT PERSONAL STORAGE LOCKER WITH BENCH MODEL FPPL-242478 BY FASCO OR EQUIVALENT

MODEL NO. W362415-MLGR BY HAMPTON BAY OR EQUIVALENT WITH WILSONART STRAIGHT LAMINATE COUNTERTOP WITH WATERFALL EDGE, BACKSPLASH, SIDE SPLASH ANDD END CAP, MODEL NO. 011312010495008 (PRALINE ANTICO) BY

HAMPTON BAY OR EQUIVALENT. 7 INSTALL TINTED 3M ULTRA SERIES SAFETY FILM OR EQUIVALENT

(8) CONSTRUCT 2" X 6" WOOD STUD WALL, 12" ON CENTER W/R-19 BATT INSULATION FOR SOUND REDUCTION PURPOSES, 5/8" THICK GYPSUM BOARD (BOTH SIDES), BULLET RESISTANT SHIELD (UL LEVEL 3) WITH JOINT REINFORCEMENT AND FIRRING (INSTALL BETWEEN STUDS), BOLT IN BULLET RESISTANT STEEL FRAME (UL LEVEL 3), BULLET RESISTANT GLAZING WINDOW (UL LEVEL 3), COUNTER WITH STAINLESS STEEL DEAL TRAY AND SPEAK THRU DEVICE (SEE SHEET 7 OF 11)

(9) CONSTRUCT 2" X 6" WOOD STUD WALL, 12" ON CENTER W/R-19 BATT INSULATION FOR SOUND REDUCTION PURPOSES, 1/2" THICK GYPSUM BOARD (BOTH SIDES), BULLET RESISTANT SHIELD (UL LEVEL 3) WITH JOINT REINFORCEMENT AND FIRRING (INSTALL BETWEEN STUDS), BOLT IN BULLET RESISTANT STEEL FRAME (UL LEVEL 3), BULLET RESISTANT GLAZING WINDOW (UL LEVEL 3) (SEE SHEET 8 OF 11)

(10) HEAVY DUTY RECESSED 4 PISTOL LOCKER MODEL NO. FL-708-4 BY FASCO OR EQUIVALENT

(11) MODULAR CABINET SYSTEM, MODEL NO. GS10806-2W BY HUSKY OR EQUIVALENT

(12) IMPRESSIONS NARROW - 16" TOWER WHITE WOOD CLOSET SYSTEM, MODEL NO. 558349 BY CLOSET MAID OR EQUIVALENT

REV. DATE: DRWN. CHKD. Main Floor Improvement Plan Police Department Renovations


At The Municipal Building 229 Trenton Avenue

Borough of Barrington Camden County, New Jersey


DATE: 05/15/23 DRAWN BY: T.D. CHKD. BY: SCALE: AS NO PROJECT No. 11-411BR1116 FIELD BOOK/PAGE: SHEET No. 3 OF 11

GREGORY BLASE FUSCO


PROFESSIONAL ENGINEER PA.PE No. 036608-E NJ PROFESSIONAL PLANNER No. 4076

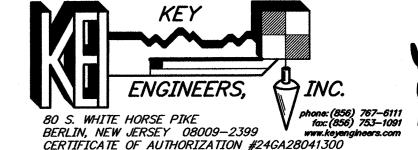



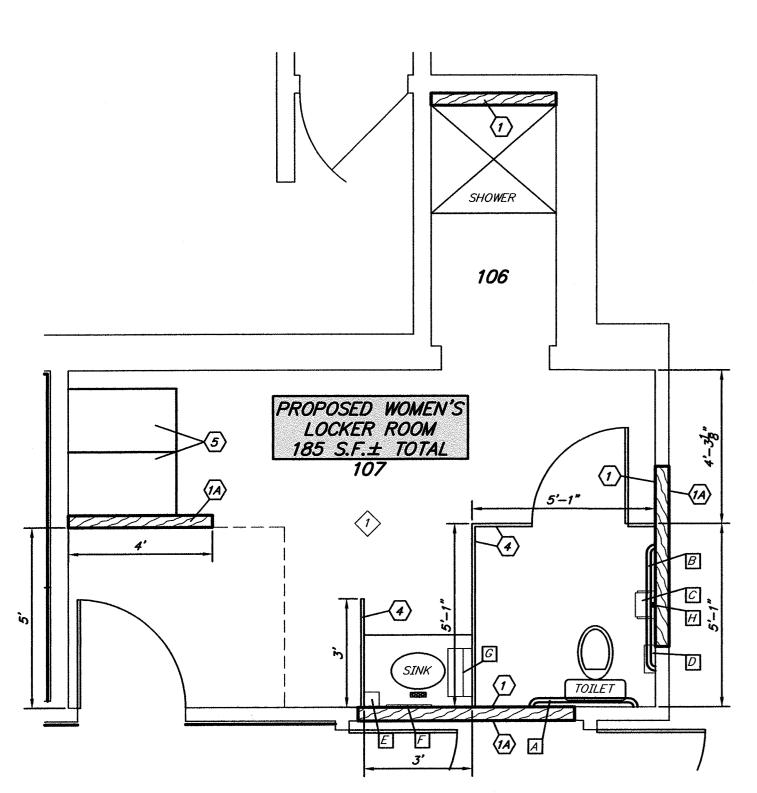


Proposed Women's Locker Room Detail scale: 3/8" = 1'

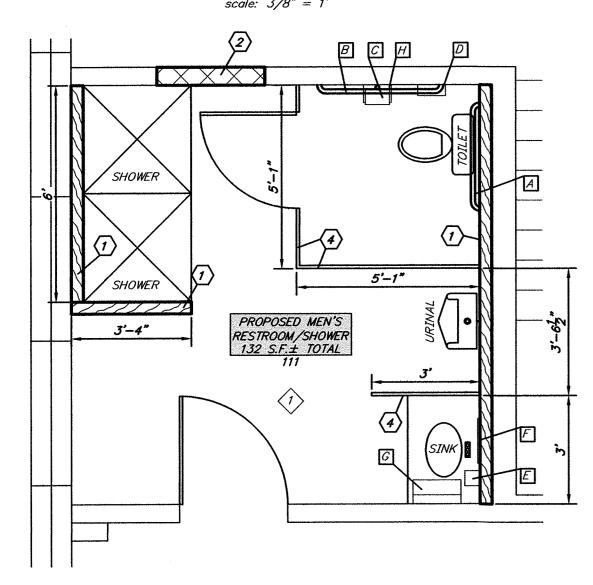

Proposed Men's Locker Room Restroom Detail

scale: 3/8" = 1'

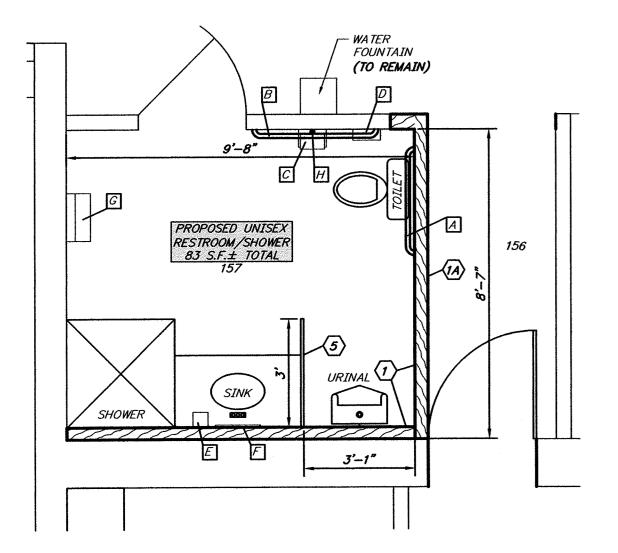

Proposed Unisex Restroom and Hallway Detail

scale: 3/8" = 1'

Legend:

KEYED TO THIS DRAWING ONLY (1) CONSTRUCT 2"X4" WOOD FRAME WALL W/R-13 INSULATION WITH PRIMED AND PAINTED 1/2" THICK DRYWALL ONE OR BOTH SIDES

CONSTRUCT 2"X4" WOOD FRAME WALL W/R-13 INSULATION WITH PRIMED AND PAINTED 5/8" THICK DRYWALL ONE OR BOTH SIDES

TOILET/URINAL PARTITION SYSTEM W/FLOOR TO CEILING PILASTERS TO BE MANUFACTURED BY GENERAL PARTITION, HIGH DENSITY POLYMER 60 SERIES & FBS-7 OVER GALVANIZED STEEL FLOOR MOUNT WITH OVERHEAD BRACE AND COMPONENTS OR EQUIVALENT. STANDARD COLOR AND TEXTURE TO BE SELECTED BY OWNER.

(5) PERSONAL STORAGE LOCKER MODEL FPPL-242461 BY FASCO OR EQUIVALENT

	RESTROOM ACCESSORY SCHEDULE		
ITEM	DESCRIPTION	MANUFACTURER	MODEL NUMBER
A	GRAB BAR	BOBRICK OR EQ.	B 6806 x 36"
В	GRAB BAR	BOBRICK OR EQ.	B 6806 x 42"
C	TOILET TISSUE DISPENSER	BOBRICK OR EQ.	B-2888
D	FEM. SAN. NAP. DISPOSAL	BOBRICK OR EQ.	B270
E	SOAP DISPENSER	BOBRICK OR EQ.	B-4112
F	MIRROR	BOBRICK OR EQ.	B-294-1830, 18"x30"
G	PAPER TOWEL DISPENSER & WASTE RECEPTACLE	BOBRICK OR EQ.	B-3944 (RECESSED)
Н	GRAB BAR	BOBRICK OR EQ.	B 6806 x 18" MIN.

ALL FIXTURES AND ACCESSORIES TO BE MOUNTED IN ACCORDANCE WITH CURRENT N.J. BARRIER FREE SUBCODE AND FEDERAL AMERICANS WITH DISABILITIES ACT REQUIREMENTS

STANDARD FRP, PEBBLED SURFACE 3/32" THICK AS MANUFACTURED BY MARLITE OR EQUIVALENT SHALL BE INSTALLED ON ALL BATHROOM WALLS. COLOR TO BE SELECTED BY THE BOROUGH.

SIGNS: PROVIDE WALL MOUNTED "MEN", "WOMEN" AND "UNISEX" IDENTIFICATION SIGNS MEETING REQUIREMENTS OF NJ BARRIER FREE SUBCODE AND FEDERAL A.D.A., INCLUDING LETTERING, FIGURE SYMBOLS, H.C. SYMBOLS, AND BRAILLE; CONSTRUCTION TO BE MATTE FINISH TRANSPARENT ACRYLIC FACE PANEL OVER TRANSPARENT ACRYLIC BACK PANEL WITH MIN. 4" SUBSURFACE COATS OF ACRYLIC ENAMEL (2 ON FACE PAN. & 2 ON BACK PAN.; HELVETICA LETTERS AND SYMBOLS TO BE MACHINE CUT FROM MATTE FINISH OPAQUE ACRYLIC, CHEMICALLY BONDED TO FACE: COLORS

SHALL BE BLUE WITH WHITE CORE; MOUNT TO WALL ADJACENT TO THE DOOR WITH VANDAL RESISTANT SCREWS. Acoustical Suspended Ceiling System Schedule:

1 ALL CEILING TILES AND GRID WHERE INDICATED SHALL BE REPLACED WITH: ACOUSTICAL PANEL STANDARD - FS SS-S-118 TILES - ACOUSTIC MINERAL FIBER CEILING TILE, CIRRUS OPEN PLAN (4'X2' PANELS) BY ARMSTRONG MODEL NO. 556 OR EQUIVALENT METAL DIRECT-HUNG SUSPENSION SYSTEMS - DIRECT-HUNG SYSTEMS, ROLLED-FORMED FORM PREFINISHED COLD-ROLLED STEEL SHEET, WITH HANGER WIRE, ATTACHMENT DEVICES AND EDGE MOLDINGS AND TRIM

NEW ACOUSTICAL SUSPENDED CEILING TO BE CONSTRUCTED WITHIN EXISTING AND NEW PROPOSED WALL LINES.

Flooring:

EXISTING TILED AREA OR PROPOSED RESTROOM(S), LOCKER ROOMS & PROCESSING ROOM/CORRIDOR(S) EXCELON IMPERIAL TEXTURE V.C.T. 12"X12" COMMERCIAL TILES WITH VINYL WALL BASE BY ARMSTRONG OR EQUIVALENT. STANDARD COLOR AND TEXTURE TO BE SELECTED BY BOROUGH.

Wall Legend:

KEYED TO THIS SHEET ONLY

PROPOSED 2"X4" WOOD FRAME WALL

PROPOSED C.M.U. WALL




DATE 8 30 23

GENERAL REVISIONS





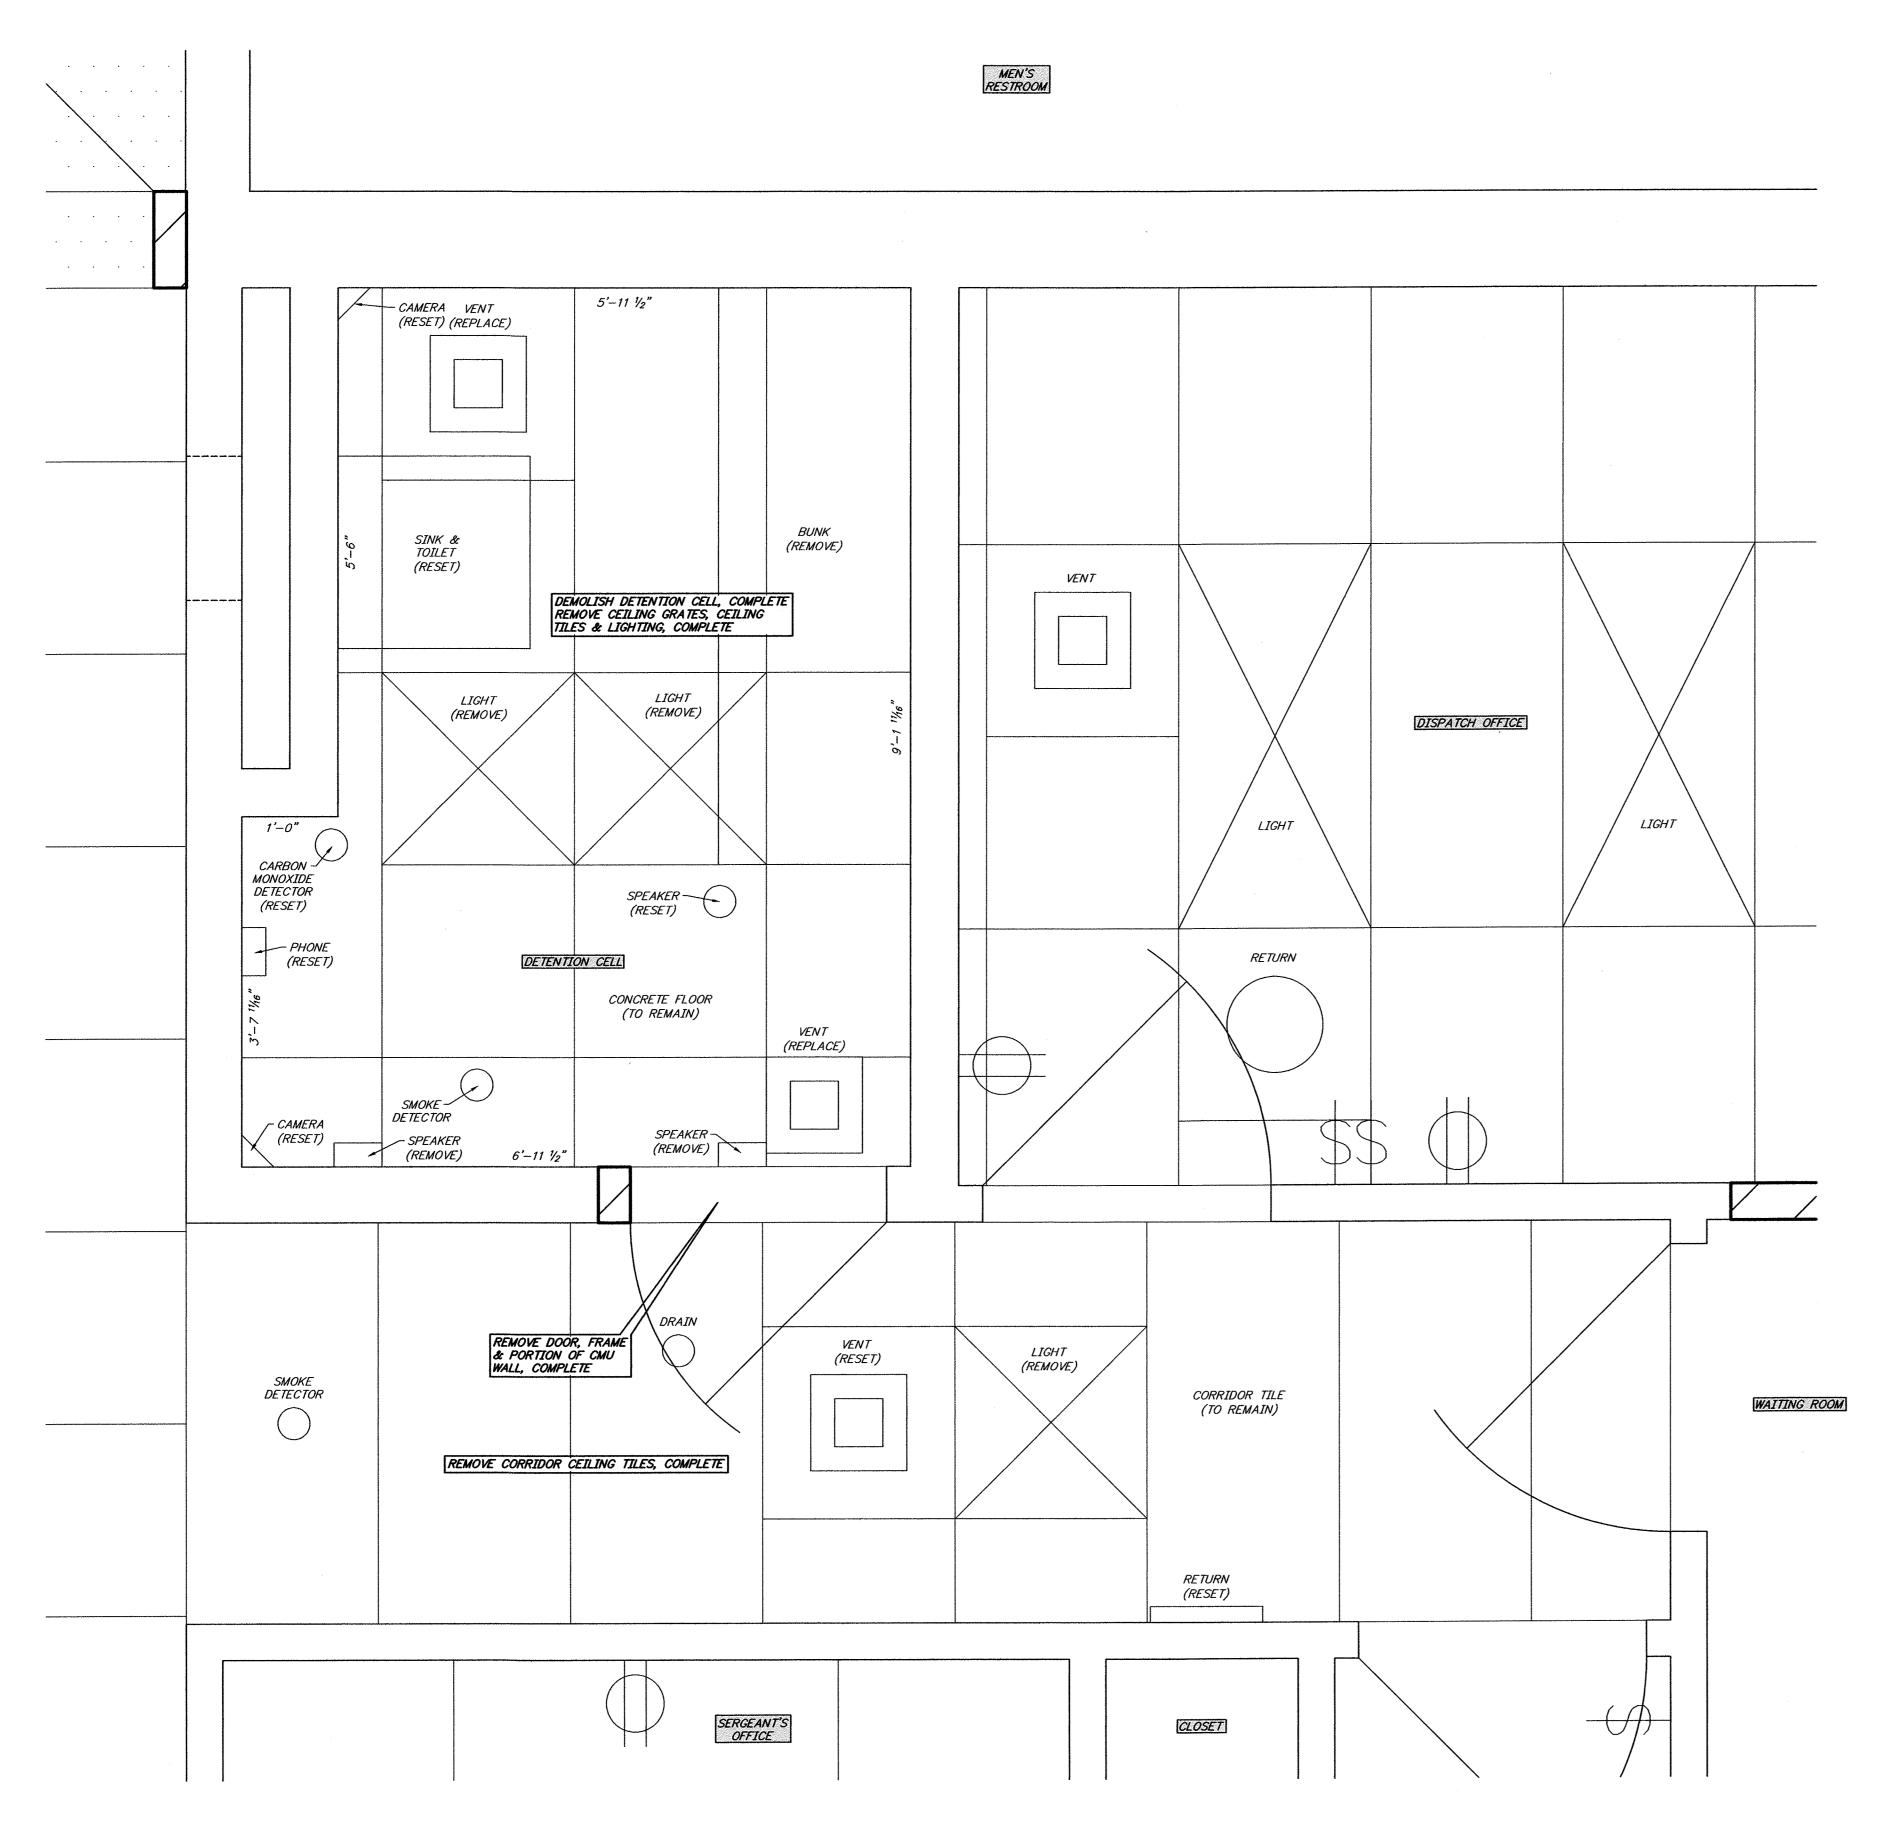


<u>Detention Cell Demolition Plan</u> scale: 1" = 1'

Demolition Notes:


- 1. ALL DEMOLITION MATERIALS SHALL BE PROPERLY AND LAWFULLY DISPOSED OF AT A LAWFUL FACILITY INCLUDING TRANSPORTATION AND DISPOSAL FEES. ALSO, ANY RECYCLABLE MATERIALS SHALL BE DISPOSED OF AT A RECYCLING FACILITY INCLUDING TRANSPORTATION AND DISPOSAL FEES AND THE TONNAGE MUST BE REPORTED TO THE BOROUGH CLERK AND/OR RECYCLING COORDINATOR.
- 2. ALL ASBESTOS CONTAINING MATERIAL (ACM) SHALL BE LAWFULLY REMOVED, CONTAINED AND DISPOSED OF AT A LAWFUL FACILITY.
- 3. ALL ITEMS SCHEDULED TO BE RESET SHALL BE CAREFULLY REMOVED AND STORED UNTIL THEY AREA RELOCATED. ANY ITEMS THAT ARE DAMAGED SHALL BE REPLACED BY THE CONTRACTOR AS HIS EXPENSE.

Wall Legend:

KEYED TO THIS SHEET ONLY

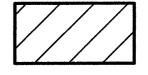

REMOVE WALLS AS NECESSARY TO CREATE OPENING FOR THE NEW DETENTION CELL DOOR

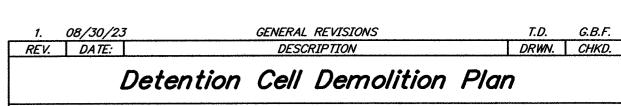


Police Department Renovations At The Municipal Building 229 Trenton Avenue


Borough of Barrington Camden County, New Jersey

DATE: 05/15/23 DRAWN BY: T.D. CHKD. BY: SCALE: 1" = 1' PROJECT No. 11-411BR1116 FIELD BOOK/PAGE: SHEET No. 5 OF 11 GREGORY BLASE FUSCO

PROFESSIONAL ENGINEER

NJPE No. 32853 PA.PE No. 036608–E NJ PROFESSIONAL PLANNER No. 4076

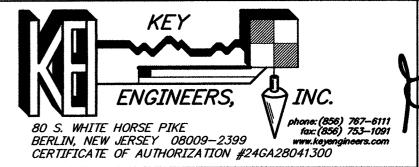

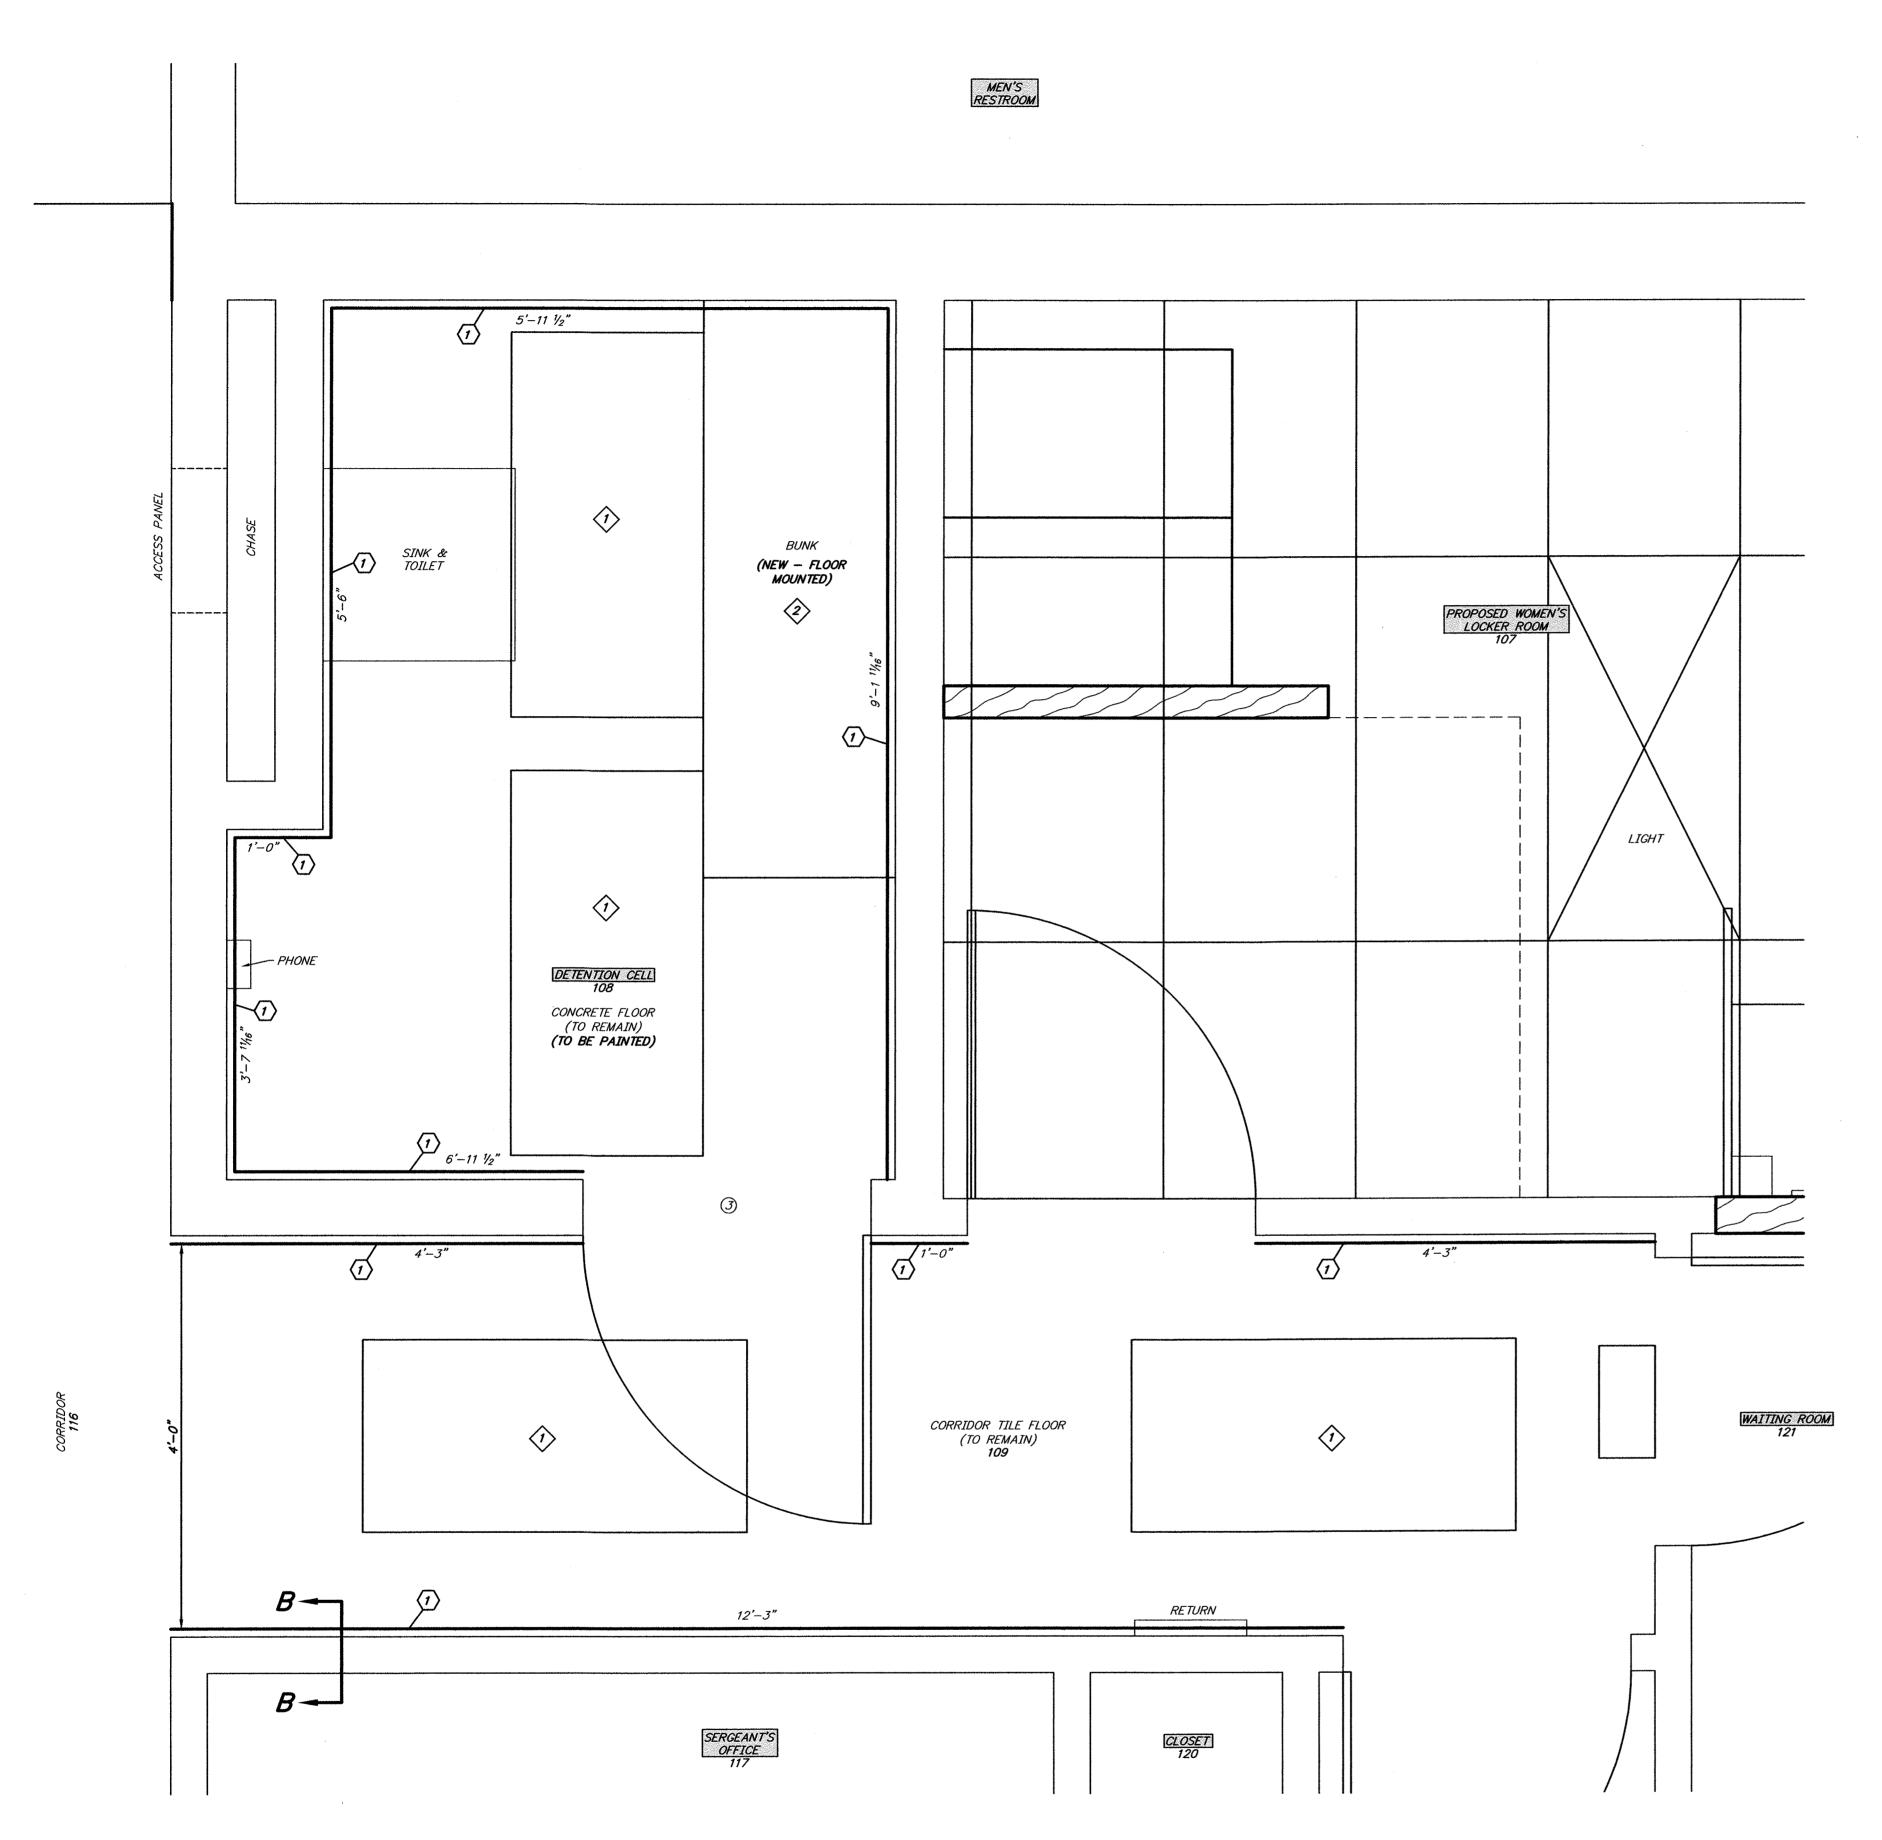

Detention Cell Improvement Plan
scale: 1" = 1'

Door & Frame Notes

- 1. FRAME TO BE MIN. 12 GA., GALVANIZED STEEL, W/WELDED CORNERS; PROVIDE MIN. 3 MASONRY JAMB ANCHORS PER JAMB: REINFORCE ALL AREAS TO RECEIVE HARDWARE: PROVIDE MORTAR BOXES, WELDED TO FRAMES AT ALL CUTOUTS (FRAMES TO BE FILLED SOLID WITH MORTAR).
- 2. DETENTION CELL DOOR TO BE FLUSH, HOLLOW METAL, SECURITY TYPE, SECURITY LEVEL 1 BY TRUSSBILT, LLC OR AMERICAN JAIL PRODUCTS, LLC W/TRUSSBILT, LLC FP-G3 CUFF PORT/FOOD PASS OR AMERICAN JAIL PRODUCTS, LLC No. 302 FOOD PASS AND FOLGER ADAM 80-4F LATCH, 10"X10" SECURITY VISION LITE (U.L. 3) AND CELL NUMBER SIGN
- 3. DOORS AND FRAMES TO BE FACTORY PRIMED; FIELD APPLY FINISH PAINT: 2 COATS OF SHERWIN—WILLIAMS GLOSS EXTERIOR ACRYLIC LATEX A—100 AND SEMI—GLOSS INTERIOR ACRYLIC LATEX SUPER PAINT OR APPROVED EQUIVALENT.


NO.		SIZE		MATERIAL	GAUGE	FIRE RATING	
	WIDTH	HEIGHT	THICKNESS				
3	3'-0"	6'-8"	2"	HOLLOW METAL	12 GAUGE MINIMUM	3 HR	

Legend KEYED TO THIS

- CONSTRUCT 12 GAUGE STEEL PLATE TRUSSWALLS AND TRUSSDECK CEILING, COMPLETE, MANUFACTURED BY TRUSSBILT, LLC OR 3/16" MILD STEEL PLATE WITH STIFFENERS, COMPLETE, MANUFACTURED BY AMERICAN JAIL PRODUCTS, LLC OR EQUIVALENT
- DOUBLE 2"X4" WOOD PLATE TO BE FASTENED TO BAR JOISTS ABOVE SUSPENDED CEILING WITH WOOD SUPPORT BRACKETS CONSTRUCTED BETWEEN BAR JOISTS
- LIGHTING L.E.D. (SEE ELECTRICAL PLAN)
- FLOOR MOUNTED SINGLE BUNK BY TRUSSBILT, LLC OR AMERICAN JAIL PRODUCTS, LLC OR EQUIVALENT W/DETENTION CELL MATTRESS, MODEL No. CR SAFEGUARD BIP (BUILT-IN-PILLOW) BY CHESTNUT RIDGE FOAM OR EQUIVALENT

General Notes:

- 1. ALL SCREWS SHALL BE TAMPER PROOF SNAKE EYES SPANNER OR TORX T-20 HEAD WITH CENTER PIN OR EQUIVALENT.
- 2. SMOKE DETECTORS/CARBON MONOXIDE GUARD SHALL BE STAINLESS STEEL, SURFACE MOUNTED MODEL No. STI-8230-SS MANUFACTURED BY SAFETY TECHNOLOGY INTERNATIONAL OR EQUIVALENT.
- 3. ALL ITEMS SPECIFIED ARE OR APPROVED EQUIVALENT.

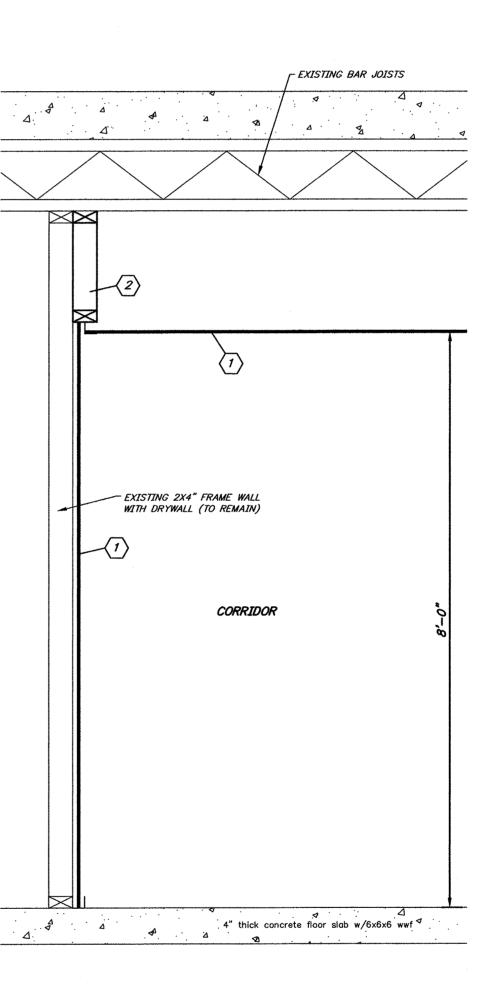

Trusswall Wall Section B-B scale: 1' = 3/4"

1. 08/30/23 GENERAL REVISIONS T.D. G.B.F.

REV. DATE: DESCRIPTION DRWN. CHKD.

Detention Cell Improvement Plan

Police Department Renovations
At The Municipal Building
229 Trenton Avenue

Borough of Barrington
Camden County, New Jersey


DATE: 05/15/23 DRAWN BY: T.D. CHKD. BY: SCALE: 1" = 1'
PROJECT No. 11-411BR1116 FIELD BOOK/PAGE: SHEET No. 6 OF 11


GREGORY BLASE FUSCO

PROFESSIONAL ENGINEER

NJPE No. 32853 PA.PE No. 036608-E

NJ PROFESSIONAL PLANNER No. 4076

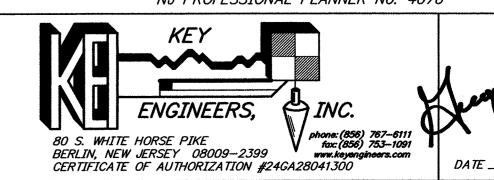

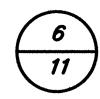



DEMOLITION:

- 1 DEMOLISH AND DISPOSE OF EXISTING WALL, WINDOWS AND DOORS
- TRIM AND REMOVE CARPETING
- SAWCUT AND REMOVE CONCRETE FLOOR SLAB

CARPENTRY:


CONSTRUCT 2" X 6" WALL DETAIL (SEE TYPICAL WALL SECTION DETAIL)

- 36" X 80" HOLLOW METAL DOOR, CURRIES 847 SERIES, U LEVEL 3 OR EQUIVALENT
- 36" X 80" HOLLOW METAL DOOR, CURRIES 847 SERIES WITH 6"X36" LITE, U LEVEL 3 OR EQUIVALENT


COUNTER WALL SECTION DETAIL:

- DOUBLE 2" X 6" PRESSURE TREATED WOOD PLATE ON CONTINUOUS SILL SEALER; FASTEN TO CONCRETE FLOOR WITH POWER ACTUATED FASTENERS
- 2" X 6" WOOD STUD WALL, 12" ON CENTER
- R-19 BATT INSULATION FOR SOUND REDUCTION PURPOSES
- 5/8" THICK GYPSUM BOARD (BOTH SIDES), FIRE RESISTANT BOARD AND MOLD RESISTANT BOARD
- BULLET RESISTANT SHIELD UL LEVEL 3 WITH JOINT REINFORCEMENT AND FIRRING (INSTALL BETWEEN STUDS AND 5/8" THICK GYPSUM BOARD (OFFICE SIDE)
- DOUBLE 2" X 6" WOOD PLATE TO BE FASTENED TO BAR JOINTS ABOVE SUSPENDED CEILING WITH WOOD SUPPORT BRACKETS CONSTRUCTED BETWEEN BAR JOINTS.
- CARPET COVE WALL BASE
- CARPETING (COMMERCIAL GRADE NYLON CARPET TO MATCH EXISTING)
- TRIM AND RECONSTRUCT EXISTING SUSPENDED CEILING FRAME WORK AND TILES TO MEET PROPOSED WALL LOCATION
- SUSPENDED CEILING FRAME WORK AND TILES W/2 L.E.D. 24" X 48" LIGHT FIXTURES (ENTIRE RESIDENT SIDE)
- CONCRETE FLOOR SLAB W/(4) #5 REBAR, 2'-4" WIDE X 10' THICK OVER 4" CLEAN COMPACTED CRUSHED STONE


PAINT ALL WALL SURFACES WITH ONE (1) PRIMER COAT AND TWO (2) FINISH COATS

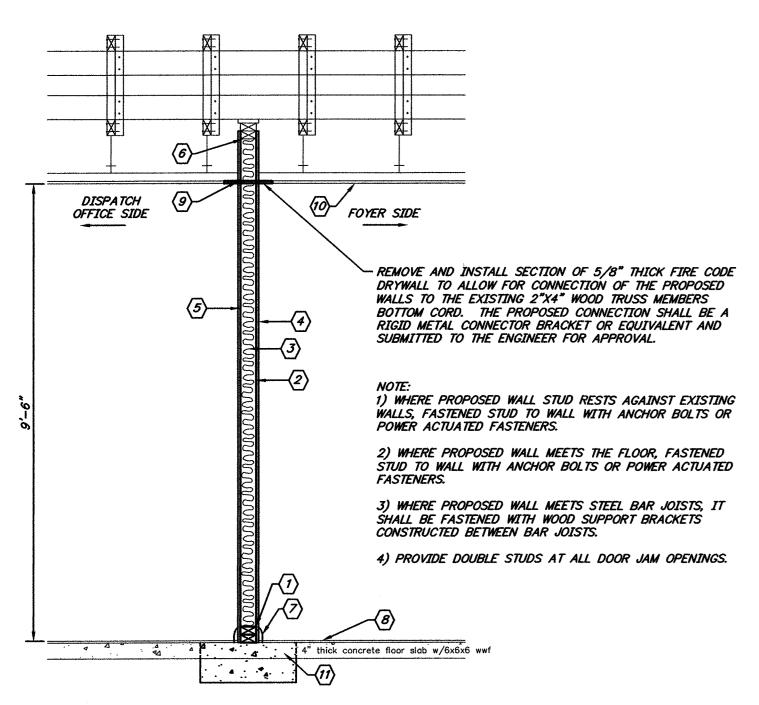


Typical Security Wall Section A-A Detail

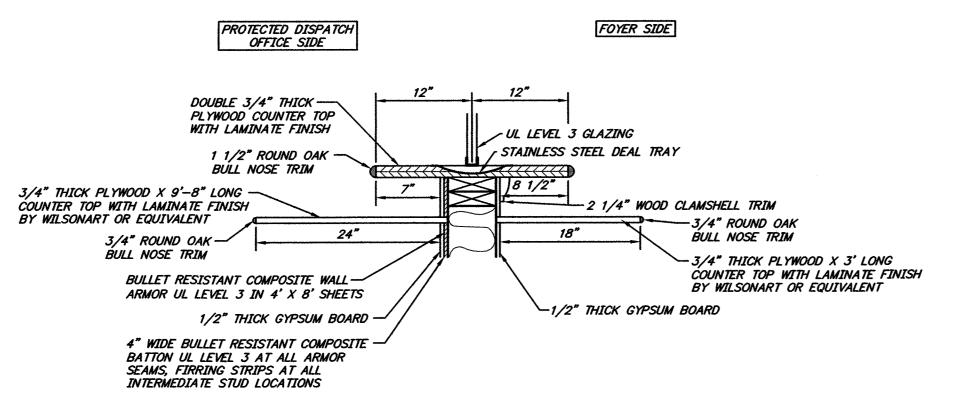


Typical Security Wall Counter Section Detail

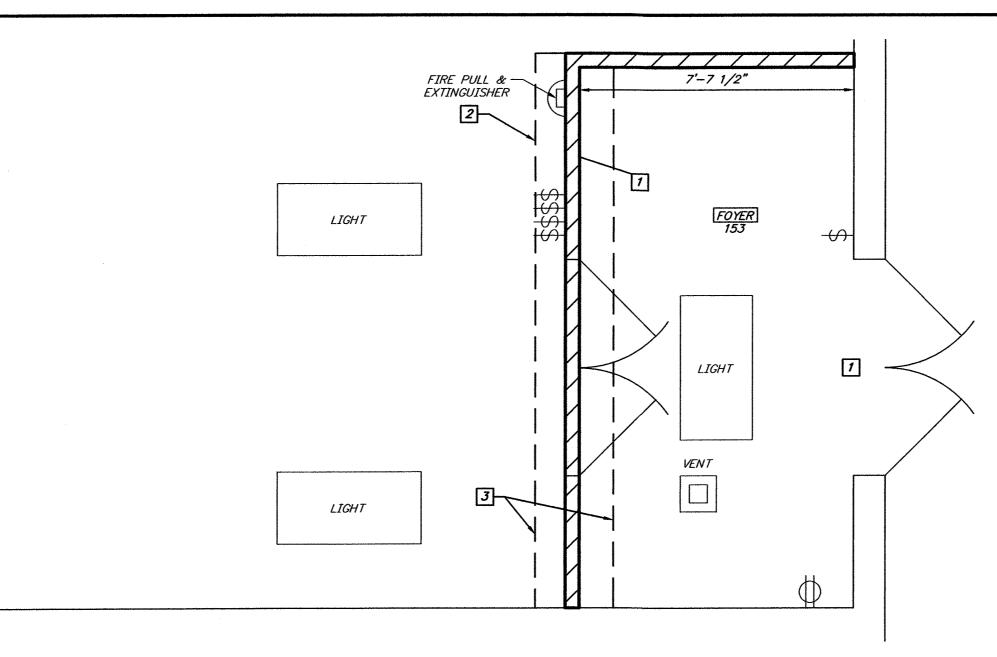


Security Wall Demolition Plan scale: 3/8" = 1'

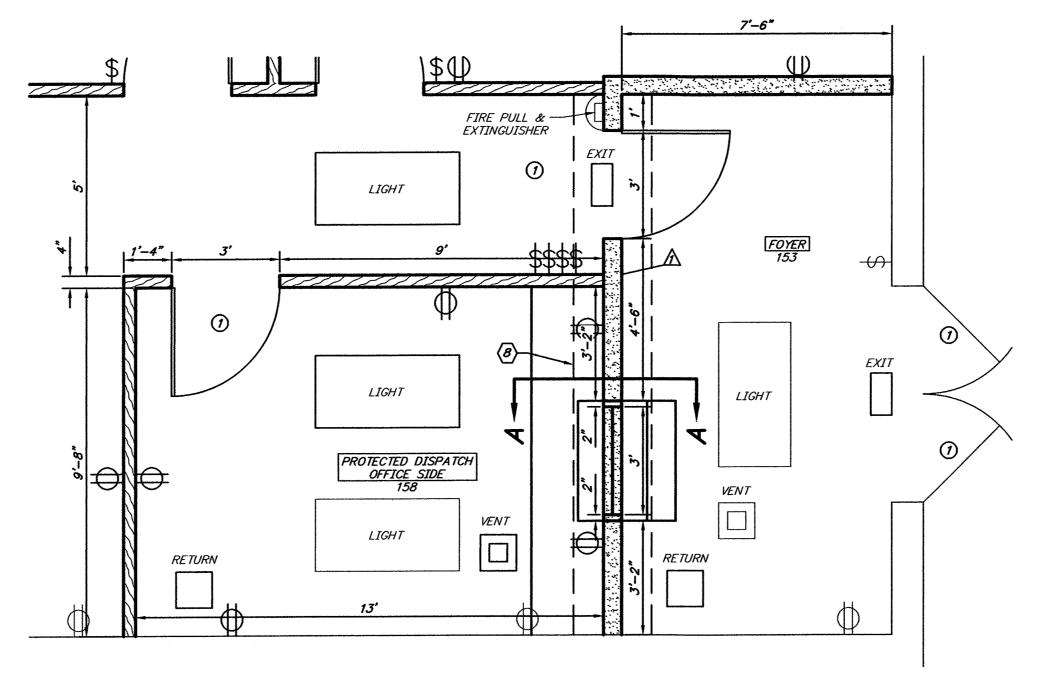

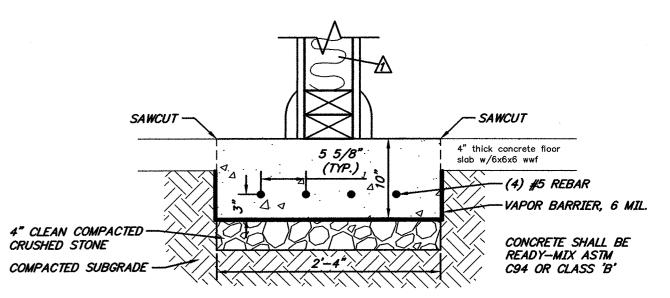


Security Wall Concrete Floor Slab Detail
Not to Scale

Security Wall Construction Plan

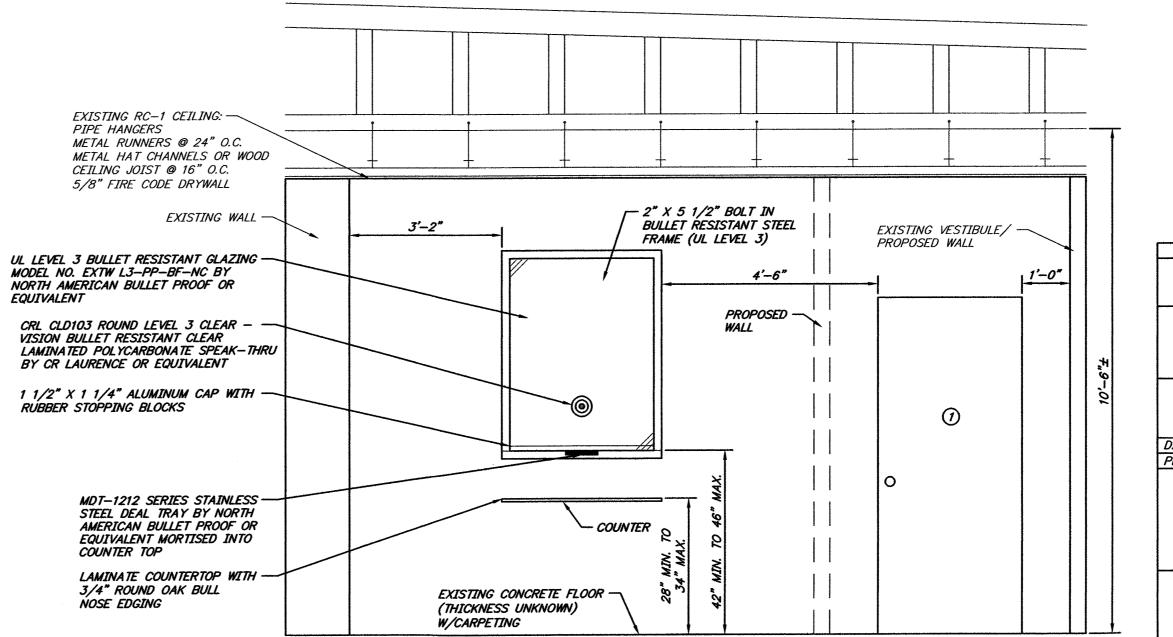

Security Wall Elevation

REPRODUCTION, ALTERATION AND AMENDMENT OF THIS PLAN SHALL BE PERFORMED ONLY BY KEY ENGINEERS, INC. AND SHALL BE PERFORMED UNDER THE ABSOLUTE DIRECTION OF THE LICENSED PROFESSIONAL WHOSE NAME AND SIGNATURE APPEARS HEREON.

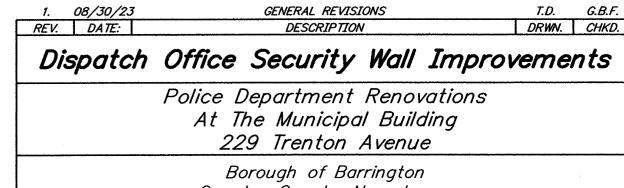

GENERAL REVISIONS

Camden County, New Jersey
 DATE: 05/15/23
 DRAWN BY: T.D.
 CHKD. BY:
 SCALE: AS NOTED

 PROJECT No. 11-411BR1116
 FIELD BOOK/PAGE:
 SHEET No. 7 OF 11

GREGORY BLASE FUSCO

PROFESSIONAL ENGINEER PA.PE No. 036608-E NJ PROFESSIONAL PLANNER No. 4076



Construction Notes:

DEMOLITION:

- DEMOLISH AND DISPOSE OF EXISTING WALL, WINDOWS AND DOORS
- REMOVE AND DISPOSE OF SUSPENDED CEILING (FRAME, TILES AND LIGHT FIXTURES)
- 3 SAWCUT AND REMOVE CONCRETE FLOOR SLAB

CARPENTRY:


- CONSTRUCT 2" X 6" WALL DETAIL (SEE TYPICAL WALL SECTION DETAIL)
- CONSTRUCT ACOUSTICAL SUSPENDED CEILING AND L.E.D. LIGHTING (SEE ELECTRICAL PLAN)

36" X 80" HOLLOW METAL DOOR, CURRIES 847 SERIES, U LEVEL 3 OR EQUIVALENT. TOTAL OF 1 UNIT.


COUNTER WALL SECTION DETAIL:

- DOUBLE 2" X 6" PRESSURE TREATED WOOD PLATE ON CONTINUOUS SILL SEALER; FASTEN TO CONCRETE FLOOR WITH POWER ACTUATED FASTENERS
- 2" X 6" WOOD STUD WALL, 12" ON CENTER
- R-19 BATT INSULATION FOR SOUND REDUCTION PURPOSES
- 5/8" THICK GYPSUM BOARD (BOTH SIDES), FIRE RESISTANT BOARD
- BULLET RESISTANT SHIELD UL LEVEL 3 WITH JOINT REINFORCEMENT AND FIRRING (INSTALL BETWEEN STUDS AND 5/8" THICK GYPSUM BOARD (OFFICE SIDE)
- DOUBLE 2" X 6" WOOD PLATE TO BE FASTENED TO BAR JOINTS ABOVE SUSPENDED CEILING WITH WOOD SUPPORT BRACKETS CONSTRUCTED BETWEEN BAR JOINTS.
- 4" HIGH VINYL COVE BASE MOLDING
- CARPETING (COMMERCIAL GRADE NYLON CARPET TO MATCH EXISTING)
- TRIM AND RECONSTRUCT EXISTING SUSPENDED CEILING FRAME WORK AND TILES TO MEET PROPOSED WALL LOCATION
- SUSPENDED CEILING FRAME WORK AND TILES W/2 L.E.D. 24" X 48" LIGHT FIXTURES (ENTIRE RESIDENT SIDE)
- CONCRETE FLOOR SLAB W/(4) #5 REBAR, 2'-4" WIDE X 10' THICK OVER 4" CLEAN COMPACTED CRUSHED


PAINT ALL WALL SURFACES WITH ONE (1) PRIMER COAT AND TWO (2) FINISH COATS

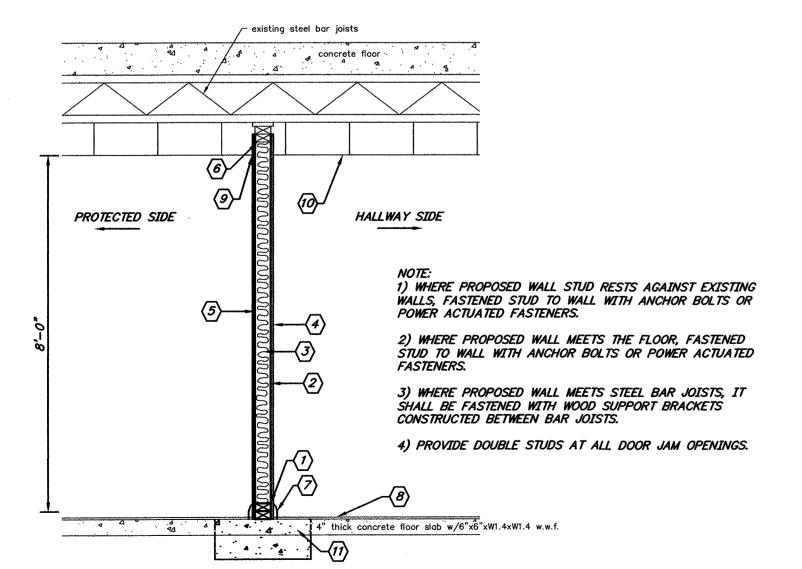


Typical Security Wall Section Detail

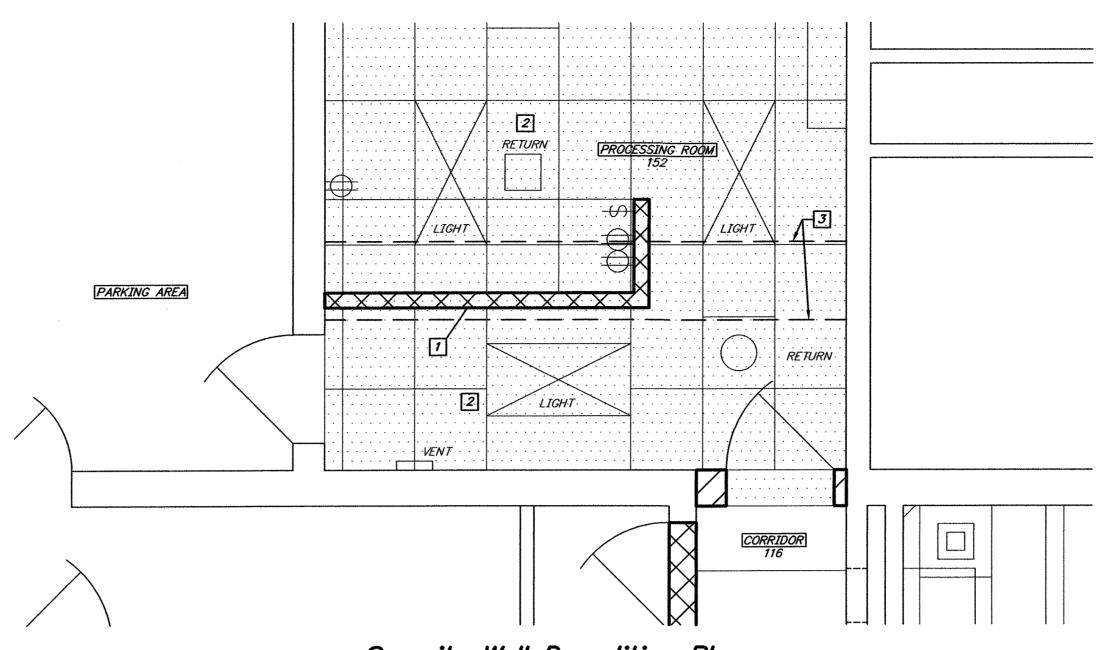

Security Wall Demolition Plan

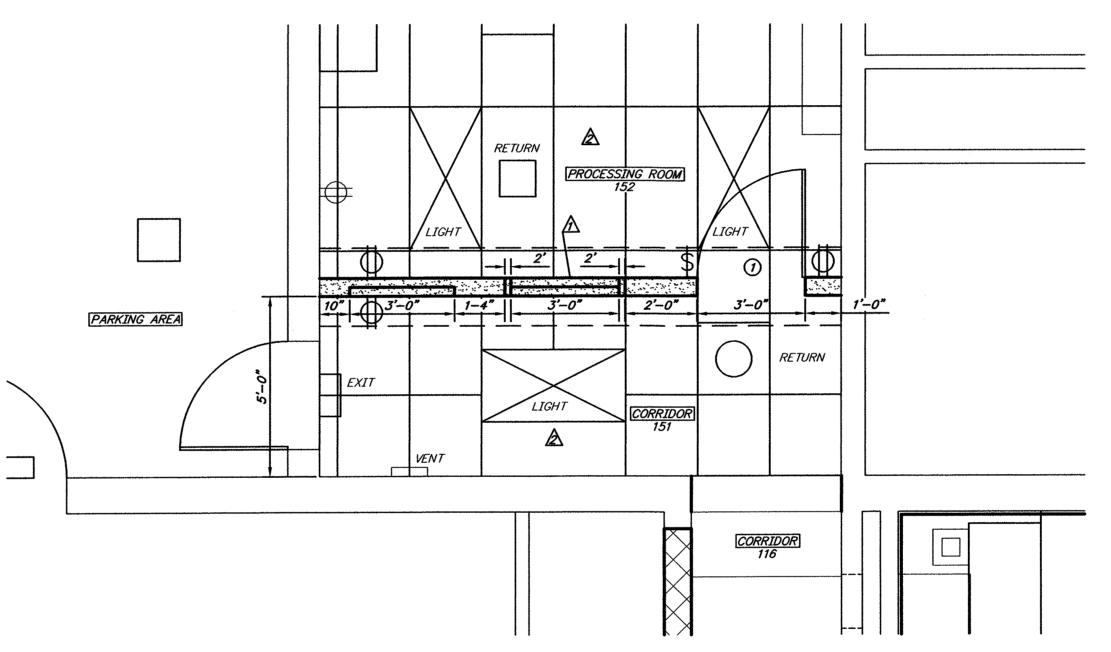

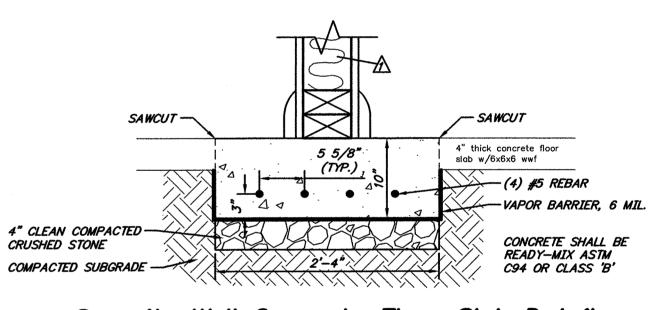

Security Wall Concrete Floor Slab Detail
Not to Scale

Security Wall Construction Plan
scale: 3/8" = 1'

CORRIDOR SIDE

-1/2" THICK GYPSUM BOARD

JUL LEVEL 3 GLAZING

Typical Security Wall Section Detail


PROTECTED PROCESSING ROOM SIDE

BULLET RESISTANT COMPOSITE WALL-

ARMOR UL LEVEL 3 IN 4' X 8' SHEETS

4" WIDE BULLET RESISTANT COMPOSITE BATTON UL LEVEL 3 AT ALL ARMOR SEAMS, FIRRING STRIPS AT ALL INTERMEDIATE STUD LOCATIONS

1/2" THICK GYPSUM BOARD

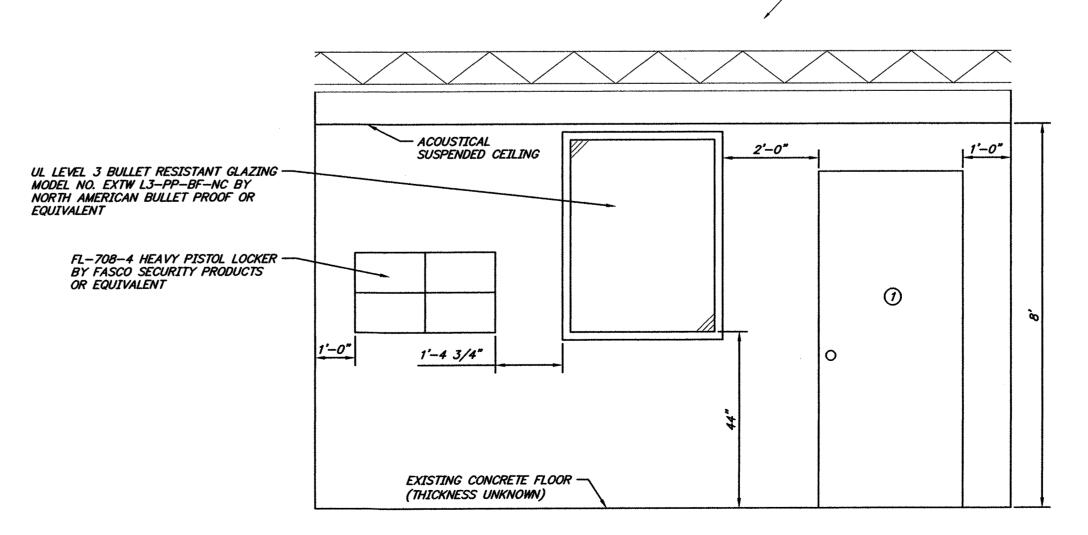

Security Wall Elevation


REPRODUCTION, ALTERATION AND AMENDMENT OF THIS PLAN SHALL BE PERFORMED ONLY BY KEY ENGINEERS, INC. AND SHALL BE PERFORMED UNDER THE ABSOLUTE DIRECTION OF THE LICENSED PROFESSIONAL WHOSE NAME AND SIGNATURE APPEARS HEREON.


1. 08/30/23 REV. DATE: GENERAL REVISIONS DRWN. CHKD. DESCRIPTION Processing Room Security Wall Improvements Police Department Renovations At The Municipal Building 229 Trenton Avenue Borough of Barrington Camden County, New Jersey
 DATE: 05/15/23
 DRAWN BY: T.D.
 CHKD. BY:
 SCALE: AS NOTED


 PROJECT No. 11-411BR1116
 FIELD BOOK/PAGE:
 SHEET No. 8 OF 11


> GREGORY BLASE FUSCO PROFESSIONAL ENGINEER PA.PE No. 036608-E

NJ PROFESSIONAL PLANNER No. 4076

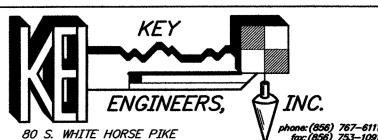

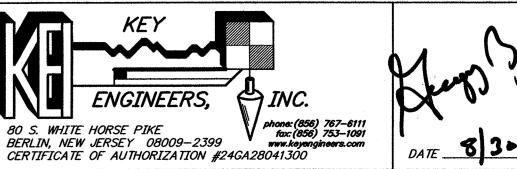

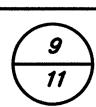

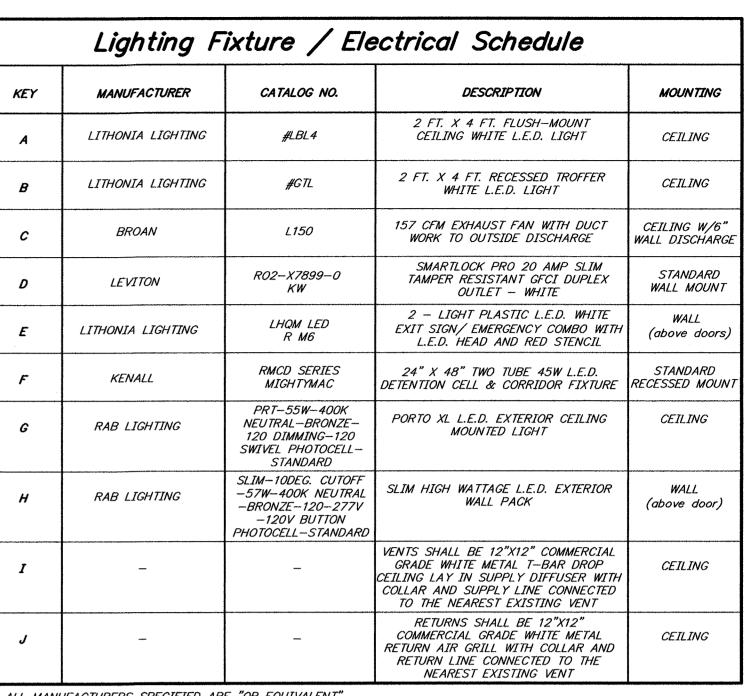

* ALL MANUFACTURERS SPECIFIED ARE "OR EQUIVALENT"

Notes:

- 1. ALL ELECTRICAL WORK SHALL BE IN STRICT ACCORDANCE WITH THE NATIONAL ELECTRICAL CODE (2005), THE NEW JERSEY UNIFORM CONSTRUCTION CODE, ICC/ANSI A.117-2003 AND LOCAL ORDINANCES.
- 2. ALL CONDUCTORS SHALL BE COPPER. ALUMINUM SHALL BE ACCEPTABLE FOR FEEDERS SIZES OF #2 OR LARGER. SIZES SHOWN ARE FOR COPPER CONDUCTORS, UNLESS OTHERWISE SHOWN.
- 3. ALL CIRCUITS SHALL BE MINIMUM WIRE SIZE OF #12 AWG THWN/THHN. ALL WIRING SHALL BE IN SURFACE MOUNTED METAL CONDUIT.
- 4. ELECTRICAL CONTRACTOR SHALL BALANCE THE LOADS IN THE PANEL TO PROVIDE THE MOST EVEN DISTRIBUTION PRACTICAL.
- 5. CONTRACTOR SHALL VERIFY ALL DIMENSIONS PRIOR TO BEGINNING WORK.
- 6. THE LICENSED ELECTRICAL CONTRACTOR SHALL SUBMIT AND OBTAIN AN ELECTRIC PERMIT. ALL PERMIT FEES SHALL BE WAIVED.

PROPOSED 20 AMP RECEPTACLE RELOCATED 20 AMP RECEPTACLE EXISTING 20 AMP RECEPTACLE PROPOSED SWITCH RELOCATED SWITCH EXISTING SWITCH

(EX.) TELEPHONE JACK (EX.)

ETHERNET JACK

PROPOSED EXHAUST FAN WITH DUCTWORK

LIGHT EXISTING LIGHT

<u>Legend:</u>

KEYED TO THIS SHEET ONLY

R LIGHT RELOCATED LIGHT

1. 08/30/23 REV. DATE:

GREGORY BLASE FUSCO PROFESSIONAL ENGINEER PA.PE No. 036608-E

GENERAL REVISIONS

Electrical Plan

Police Department Renovations

At The Municipal Building

229 Trenton Avenue


Borough of Barrington Camden County, New Jersey


 DATE: 05/15/23
 DRAWN BY: T.D.
 CHKD. BY:
 SCALE: 3/16" = 1'

 PROJECT No. 11-411BR1116
 FIELD BOOK/PAGE:
 SHEET No. 9 OF 11

DRWN. CHKD.



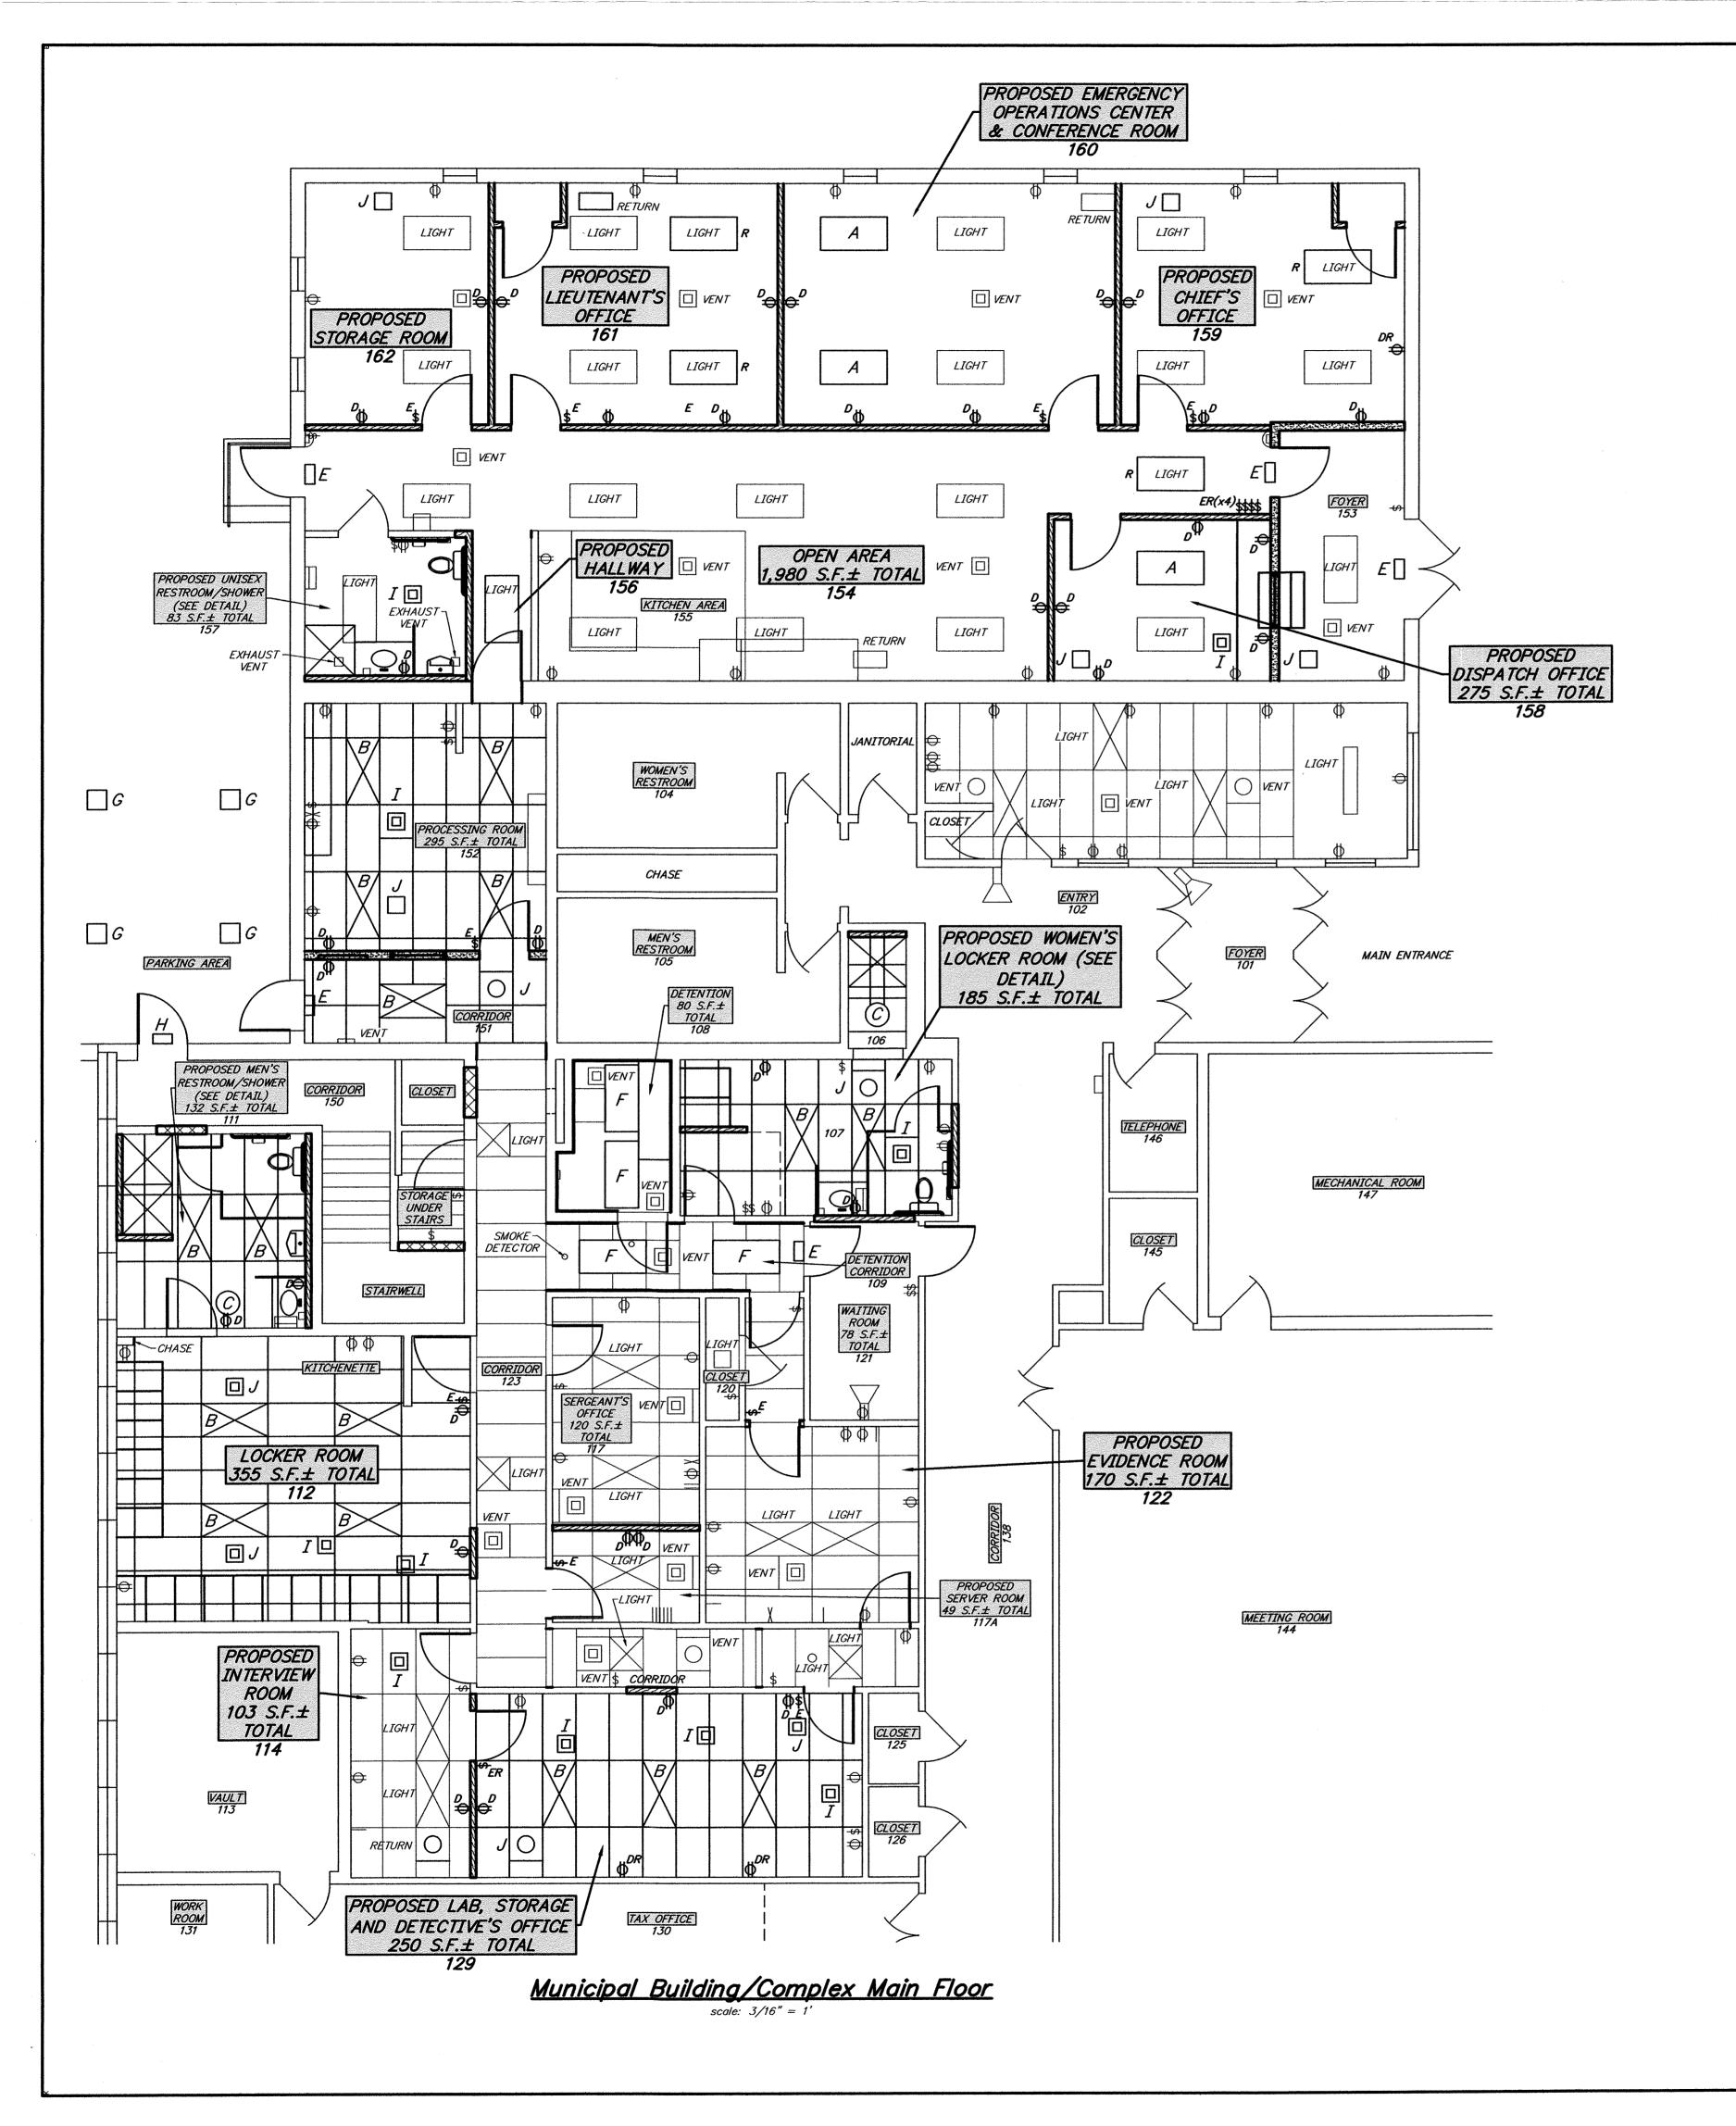


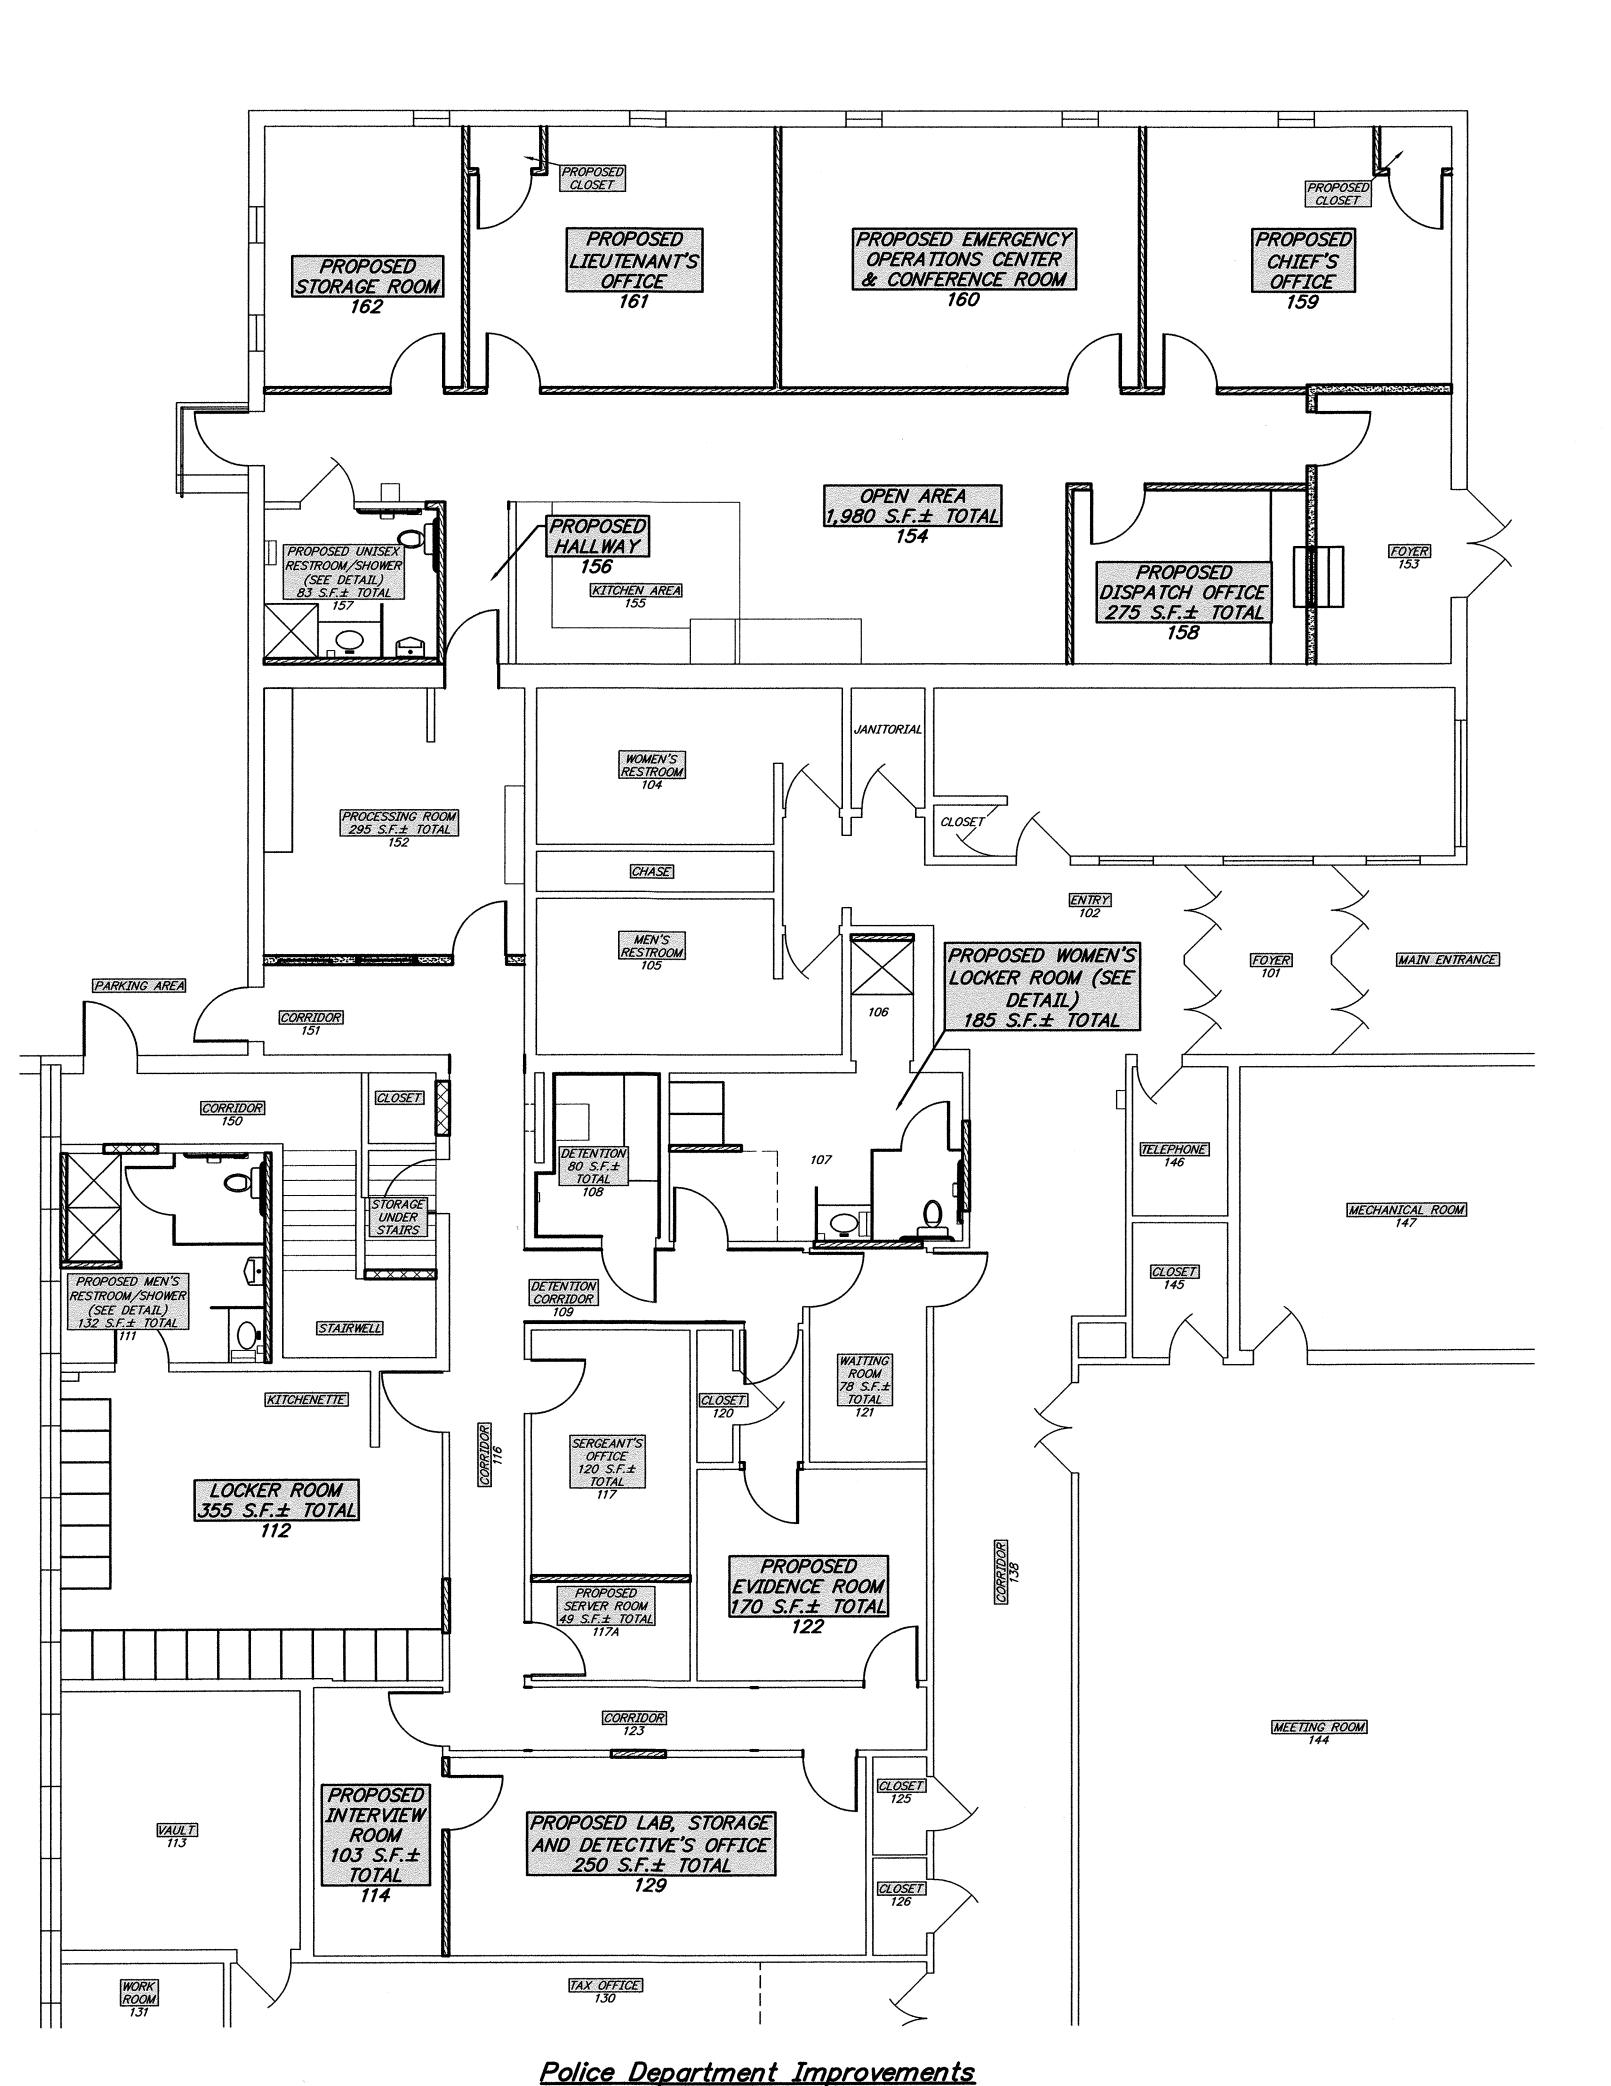


Police Department Improvements

Municipal Building/Complex Main Floor


scale: 3/16" = 1'

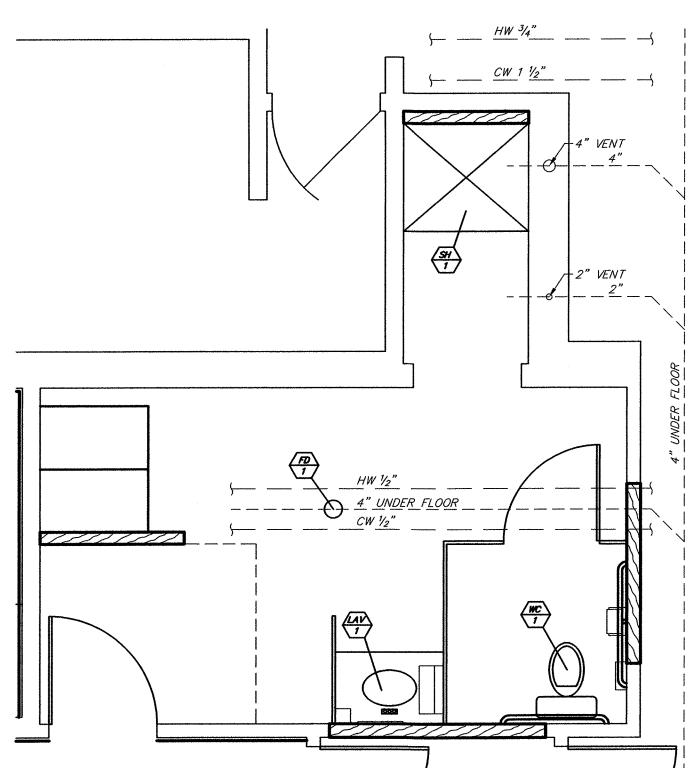

Proposed Women's Locker Room Detail scale: 3/8" = 1'

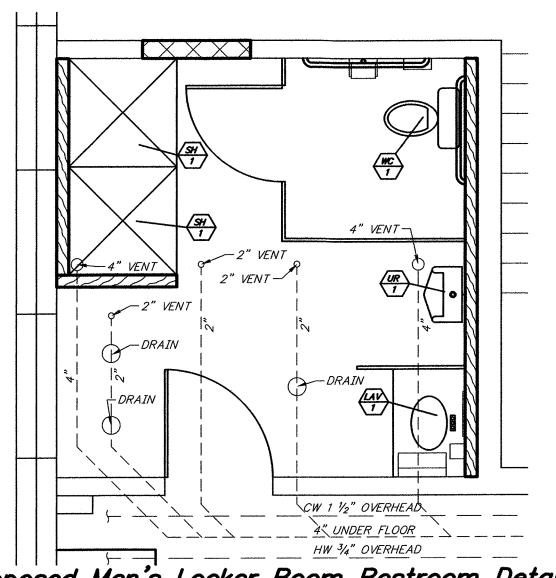

Proposed Men's Locker Room Restroom Detail

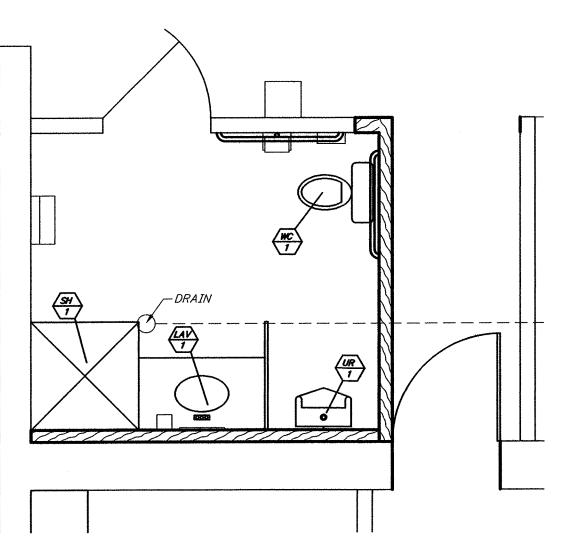



Proposed Unisex Restroom and Hallway Detail
scale: 3/8" = 1'


<u> General Notes - Plumbina</u>


- 1. INSTALL PLUMBING FIXTURES NOTED AS "EQUIPPED & INSTALLED FOR HANDICAPPED USE" TO BE FULLY ACCESSIBLE TO PHYSICALLY HANDICAPPED PERSONS. COMPLY WITH AMERICAN NATIONAL STANDARDS INSTITUTE (ANSI) PUBLICATION A117.1 -1992 "ACCESSIBLE & USEABLE BUILDINGS & FACILITIES" & / OR GOVERNING CODE. CONTRACTOR MUST VERIFY WATER PRESSURE TO INSURE FLUSH VALVES WILL OPERATE AT THIS SITE.
- 2. CLEAN ALL LINES BEFORE INSTALLATION: INSTALL FIXTURES COMPLETE WITH ALL RELATED TRAPS, TRIM, ETC. EXPOSED PIPING CHROME—PLATED. PROVIDE STOP VALVES IN ALL WATER LINES AT EACH FIXTURE: PROVIDE VACUUM BREAKERS ON ALL FLUSH VALVES IF REQUIRED.
- 3. THESE DRAWINGS ARE DIAGRAMMATIC & INDICATE THE GENERAL ARRANGEMENT OF SYSTEMS & WORK INCLUDED IN THE CONTRACT. FOR THE EXACT LOCATION & MOUNTING HEIGHT OF FIXTURES REFER TO FLOOR PLANS OR MANUFACTURERS SPECIFICATIONS. THE LICENSED PLUMBING CONTRACTOR SHALL PREPARE THE PLUMBING RISER DIAGRAM AND SUBMIT AND OBTAÎN A PLUMBING PERMIT. ALL PERMIT FEES SHALL BE WAIVED.
- 4. PLUMBING CONTRACTOR SHALL VERIFY ALL INVERTS PRIOR TO THE INSTALLATION OF WORK.
- 5. ALL HOT & COLD WATER LINES SHALL BE INSTALLED WITH 1" FIBERGLASS WITH ALL SERVICE JACKET.
- 6. ALL PIPING RUNS SHALL BE COORDINATED WITH THE WORK OF OTHER TRADES PRIOR TO THE INSTALLATION OF SAME.
- 7. PROVIDE STOP VALVES ON ALL WATER SUPPLY BRANCHES TO ALL FIXTURES.
- 8. PLUMBING CONTRACTOR SHALL PROVIDE FINAL CONNECTIONS TO ALL EQUIPMENT REQUIRING PLUMBING CONNECTION.
- 9. ALL PLUMBING WORK SHALL COMPLY WITH ALL APPLICABLE LOCAL, STATE & HEALTH CODES, & NATIONAL PLUMBING CODE. ALL MATERIALS, SANITARY PIPING, VENTS, AS APPROVED BY LOCAL AUTHORITIES.
- 10. REFER TO SPECIFICATIONS FOR DETAILED SPECIFICATIONS FOR PIPING, VALVES, WATER, SANITARY SEWER SERVICES AND THE PROVISIONS OF SAME.
- 11. THE EXISTING CONCRETE FLOOR SHALL BE REMOVED AND REPLACED AS NECESSARY TO CONNECT THE PROPOSED FIXTURE SANITARY SEWER SERVICES TO THE EXISTING SANITARY SEWER SERVICES.


<i></i>	ANTIAKT SEWEK SEKVI	CES TO THE EX	13/1/10 3/1/17	m ozman ozn	71020.						
			Plu	umbing Fi	xture Sch	edule					
FIXTURE	MANUFACTURER SERIES NUMBER		WA	TER CLOSET AND	URINAL						
		BOWL TYPE	OUTLET	FLUSH VALVE	SEAT .	CARRIER	ACCESSORIES AND FEATURES				
(WC)	AMERICAN STANDARD CADET 3 RIGHT HEIGHT MODEL 3377.128ST	FLOOR MOUNTED ELONGATED	FLOOR 3" FLUSH VALVE (POWER WASH)		AMER. STAND. ELONGATED HEAVY DUTY OPEN FRONT SEAT MODEL 5901.10055.020		EQUIPMENT & INSTALLATION FOR HANDICAP USE 1.28 GPF W.C., COLOR SHALL MATCH				
(UR)	AMERICAN STANDARD 1.0 GPF 6541.132	WALL-HUNG ELONGATED WASH OUT	BACK	SLOAN 1861XL	N/A	JAY R. SMITH	EQUIPMENT & INSTALLATION FOR HANDICAP USE 1.28 GPF W.C., COLOR SHALL MATCH				
	MANUFACTURER SERIES NUMBER		SIN	K / LAVATORY							
FIXTURE		BOWL TYPE	FAUCET	SUPPLY PIPE	TRAP	CARRIER	ACCESSORIES AND FEATURES				
(IAV)	ADA VANITY WITH SOLID SURFACE TOP PLBSE—SNK—ADA—SS BY PLAM CABINETS OR EQUIVALENT	INTEGRAL BOWL	AMER. STAND. FLEX w/ KEY 1340M.107 ANGLE STOP		CHROME PLATED BRASS		EQUIPMENT & INSTALLATION FOR HANDICAPPED USE METERED FAUCET WITH VP .5 GPM AREO. AMER. STAND. 7723.018 GRID DRAIN WITH 1 1/4" TAILPIECE				
ET TIOE	MANUFACTURER SERIES NUMBER		FLO	OOR DRAIN / ST	4007000070 440 57474050						
FIXTURE		MA TERIAL	TYPE	INLET	OUTLET	FREE AREA	ACCESSORIES AND FEATURES				
FD 1	JAY R. SMITH MFG. CO. 2005–A	NICKEL / BRONZE CAST IRON			3"	9 SQ. IN.	DUCO CAST IRON BODY & FLASHING COLLAR W/ NICKEL BRONZE STRAINER. SEEPAGE OPENINGS. PROVIDE TRAP PRIMER FOR EACH FLOOR DRAIN (1/2" C.W.)				
FIXTURE	MANUFACTURER SERIES NUMBER		CLE	AN OUT		40000000000 440 0747000					
PIATURE		MA TERIAL	SIZE				ACCESSORIES AND FEATURES				
$\langle \frac{\partial}{\partial t} \rangle$	JAY R. SMITH MFG. CO. 4021L	NICKEL / BRONZE	4"				MOUNT FLUSH W/ FLOOR				
ETVTIDE	MANUFACTURER		SHO	OWER							
FIXTURE	SERIES NUMBER										
(SF)	SHOWER SHALL BE CLASSIC 500 36" X 36" X 74" ALCOVE SHOWER KIT WITH SHOWER WALL AND SHOWER PAN IN HIGH GLOSS, FOUNDATIONS SINGLE—HANDLE I—SPRAY SHOWER IN CHROME AND LYNDALL 36"X64—3/4" SEMI—FRAMELESS CONTEMPORARY PIVOT SHOWER DOOR IN CHROME WITH 1/4" RAIN TEMPERED GLASS PANEL & CHROME HANDLE OR EQUIVALENT AND OATEY ROUND NO—CAULK WHITE P.V.C. SHOWER DRAIN WITH 4½" ROUND SNAP—IN STAINLESS STEEL DRAIN COVER OR EQUIVALENT										

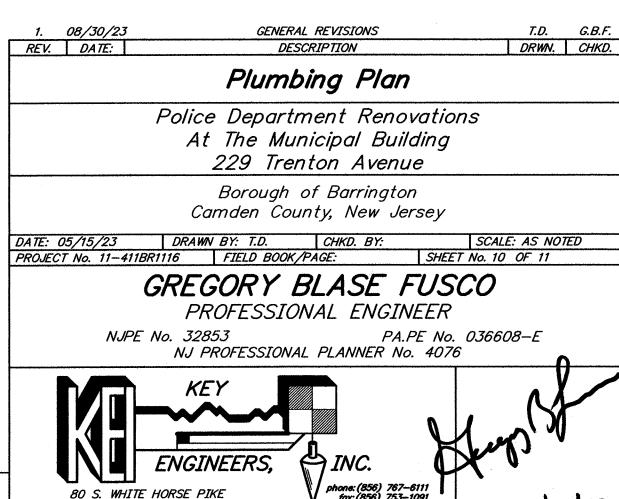

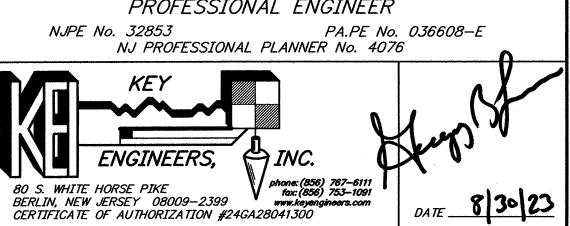

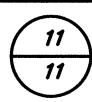


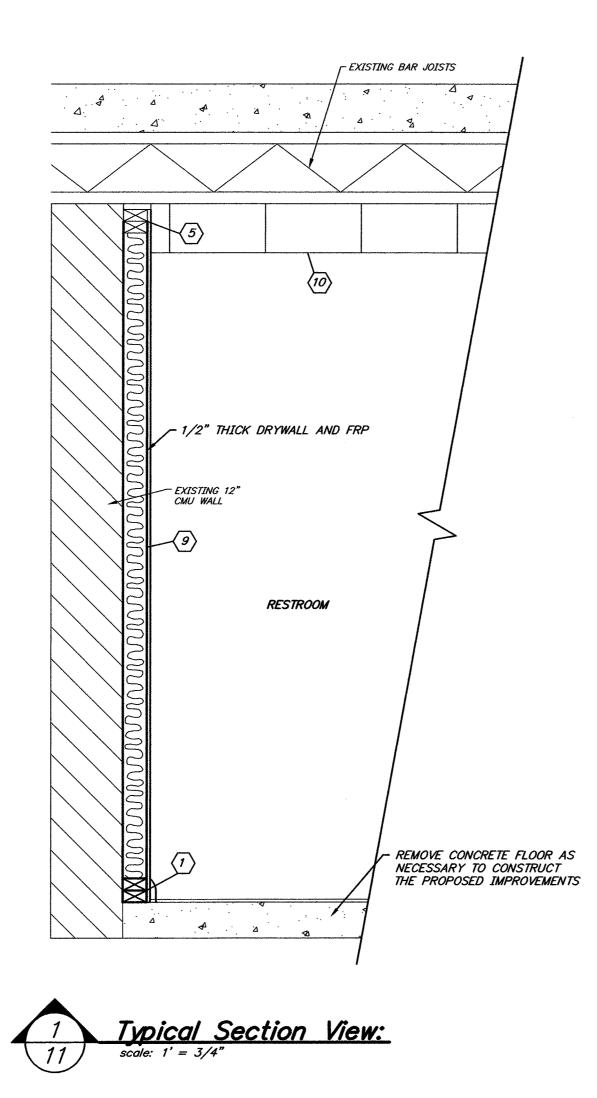

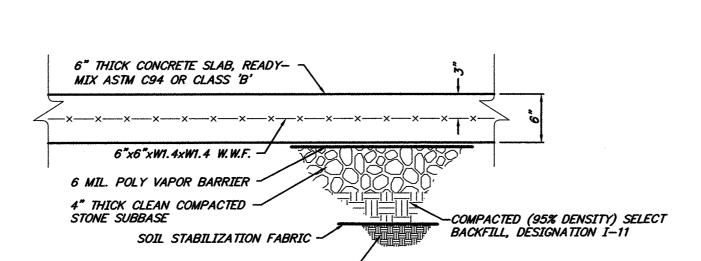


Typical Non-Structural Concrete Floor Section SCALE: 1" = 1'

VIRGIN SOIL

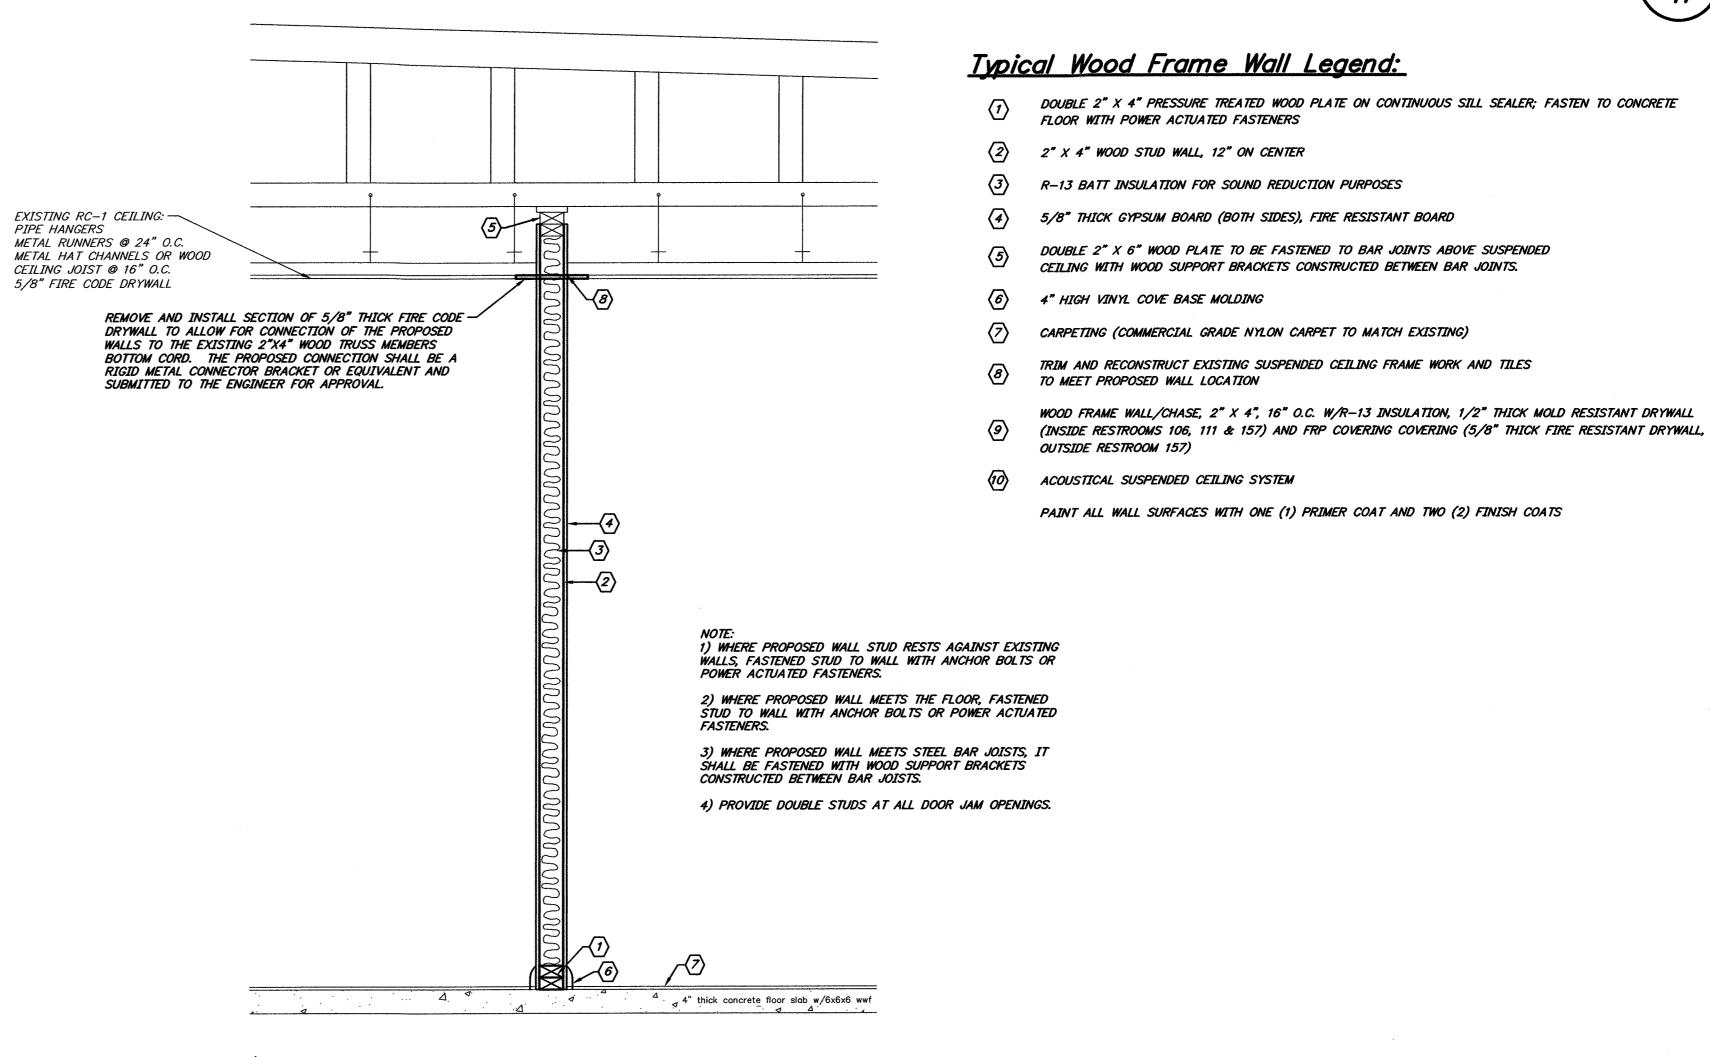

2 Typical Wood Frame Wall Section View:

11 scale: 1' = 3/4"

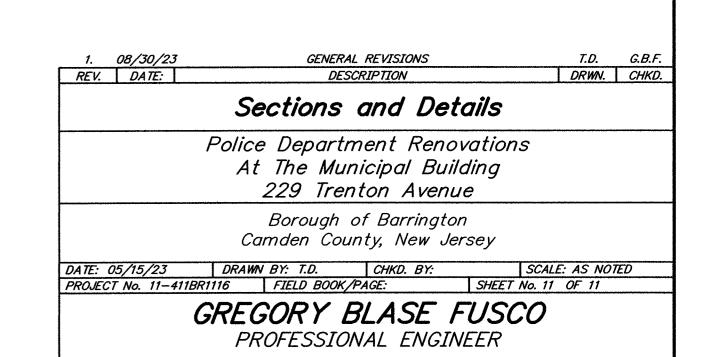

REPRODUCTION, ALTERATION AND AMENDMENT OF THIS PLAN
SHALL BE PERFORMED ONLY BY KEY ENGINEERS, INC. AND SHALL
BE PERFORMED UNDER THE ABSOLUTE DIRECTION OF THE LICENSED
PROFESSIONAL WHOSE NAME AND SIGNATURE APPEARS HEREON.

NJPE No. 32853

PA.PE No. 036608—E

NJ PROFESSIONAL PLANNER No. 4076

KEY

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CERTIFICATE OF AUTHORIZATION #24GA28041300

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