CAMDEN COUNTY COLLEGE

SMOKE TOWER STRUCTURE CAMDEN COUNTY FIRE ACADEMY AT THE REGIONAL EMERGENCY TRAINING CENTER

420 NORTH WOODBURY-TURNERSVILLE ROAD BLACKWOOD, NEW JERSEY 08012



304 White Horse Pike Haddon Heights, New Jersey 08035

Tel 856-546-8611 Fax 856-546-8612 www.BachDesignGroup.com

> SUPPLIERS, ETC, WITH COMPLETE BID PACKAGE, FAILURE TO DO SO WILL NOT PRECLUDE RESPONSIBILITY TO PROVIDE ALL WORK DESCRIBED IN THE "BID PACKAGE".

Index of Drawings:

- **COVER SHEET AND INDEX OF DRAWINGS**
- SITE PLAN, DETAILS AND QUANTITIES
- FOURTH FLOOR AND ROOF PLANS AND DETAILS
- **ELEVATIONS AND DETAILS**
- **ELEVATIONS AND DETAILS**
- **FOUNDATION PLAN FOUNDATION DETAILS**

FLOOR PLANS

- **ELECTRICAL COVER SHEET ELECTRICAL LOCATION PLAN**
 - **ELECTRICAL SINGLE LINE AND SCHEDULES**

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AMDEN

SM(CAMDEN (REGIONAL BACH ASSOCIATES, PC; AND OWNER SHALL INDEMNIFY AND HOI HARMLESS BACH ASSOCIATES, PC FROM ALL CLAIMS, DAMAGES, LOSSI AND EXPENSES ARISING OUT OF OR RESULTING THEREFROI

DATE

COVER SHEET AND INDEX OF DRAWINGS

DESIGNED BY: CCC2023-01 DRAWN BY: CHECKED BY:

C-1

APPLICABLE BUILDING CODES & GUIDELINES

2021 INTERNATIONAL BUILDING CODE - NEW JERSEY EDITION 2021 INTERNATIONAL MECHANICAL CODE 2021 INTERNATIONAL FUEL GAS CODE

USE GROUP: U (UTILITY AND MISCELLANEOUS)

2020 NATIONAL ELECTRIC CODE 2021 NATIONAL STANDARD PLUMBING CODE — NEW JERSEY EDITION 2017 ICC/ANSI A117.1



PROJECT LOCATION
SCALE: 1: 100'

GENERAL REQUIREMENTS

1. EXISTING CONDITIONS BASED UPON A FIELD SURVEY OF THE PROJECT SITE BY BACH ASSOCIATES, PC COMPLETED ON OR AROUND 02/24/24 UNDER THE SUPERVISION OF ANTHONY DIROSA, N.J.P.L.S. LICENSE No.

2. THE CONTRACTOR SHALL BE RESPONSIBLE FOR CHECKING AND VERIFYING EXISTING CONDITIONS, CAREFULLY STUDYING AND COMPARING THE CONTRACT DOCUMENTS PRIOR TO THE START OF CONSTRUCTION. ANY ERROR, INCONSISTENCY OR OMISSION SHALL BE BROUGHT TO THE ATTENTION OF THE ENGINEER IMMEDIATELY

3. LOCATION OF EXISTING UTILITIES ARE APPROXIMATE AND MUST BE VERIFIED IN THE FIELD PRIOR TO THE START OF CONSTRUCTION.

4. THE CONTRACTOR SHALL NOTIFY ALL UTILITY COMPANIES OPERATING WITHIN THE CONSTRUCTION AREA, AND AT HIS OWN EXPENSE, VERIFY THE LOCATION, SIZE, AND ELEVATIONS OF ANY UTILITIES PRIOR TO CONSTRUCTION.

5. THE CONTRACTOR SHALL NOTIFY UNDERGROUND LOCATION SERVICES AT 1-800-272-1000 AT LEAST 72 HOURS PRIOR TO COMMENCEMENT OF EXCAVATION WORK. ADDITIONALLY, SEE THE FOLLOWING NOTE FOR MARKOUTS ON PRIVATE PROPERTY, A.K.A. THE PROJECT SITE.

6. THE CONTRACTOR SHALL PROVIDE MARKOUTS OF ALL EXISTING UNDERGROUND UTILITIES AT THE PROJECT SITE PRIOR TO THE START OF EXCAVATION. IT SHOULD BE NOTED THE UTILITIES ARE ON PRIVATE PROPERTY AND WILL NOT BE LOCATED BY NJ ONE CALL. THE COST FOR THE MARKOUTS SHALL NOT BE MEASURED FOR PAYMENT BUT SHALL BE INCLUDED IN THE LUMP SUM COST OF THE PROPOSAL.

7. THE CONTRACTOR SHALL BE RESPONSIBLE FOR THE LOCATION AND PRESERVATION OF UNDERGROUND AND SURFACE UTILITIES AND STRUCTURES AT OR ADJACENT TO THE SITE OF CONSTRUCTION AND IT SHALL BE AT HIS OWN EXPENSE TO REPAIR OR REPLACE ANYTHING THAT HE DAMAGES.

8. CONTRACTOR SHALL COORDINATE ALL UTILITY RELOCATIONS AND INSTALLATIONS AS REQUIRED WITH THE APPLICABLE UTILITY COMPANIES. THE COST OF THIS COORDINATION SHALL BE INCLUDED IN THE LUMP SUM COST OF THE PROPOSAL

9. THE COST FOR THE CONTRACTOR TO CONSULT THE UTILITY COMPANIES AND CAREFULLY FIELD VERIFY THE LOCATION AND DEPTH OF THE UTILITIES SHALL BE INCLUDED IN THE LUMP SUM COST OF THE PROPOSAL.

10. DETAILS AND SECTIONS ON THE DRAWINGS ARE SHOWN AT SPECIFIC LOCATIONS AND ARE INTENDED TO SHOW GENERAL REQUIREMENTS THROUGHOUT. DETAILS NOTED "TYPICAL" IMPLY ALL CONDITIONS TREATED SIMILARLY, MODIFICATIONS TO BE MADE BY CONTRACTOR TO ACCOMMODATE SITE VARIATIONS.

11. ALL CONSTRUCTION MATERIALS, RESTORATION AND METHODS OF INSTALLATION SHALL CONFORM TO THE 2019 NJDOT STANDARD SPECIFICATIONS FOR ROAD AND BRIDGE CONSTRUCTION OR THE CONTRACT SPECIFICATIONS, WHICHEVER REQUIREMENTS ARE THE MOST STRINGENT.

12. ALL CONSTRUCTION DETAILS NOT SHOWN SHALL BE IN ACCORDANCE WITH N.J.D.O.T. STANDARDS AS DETAILED IN "STANDARD ROADWAY CONSTRUCTION CONTROL/BRIDGE CONSTRUCTION DETAILS" AND "ELECTRICAL BUREAU STANDARD DETAILS" AS APPLICABLE, INCLUDING ALL APPLICABLE BASELINE DOCUMENT CHANGES AND APPENDICES. THESE DETAILS MAY BE PURCHASED THROUGH THE N.J.D.O.T. PLANS AND SPECIFICATION DISTRIBUTION CENTER AT 1035 PARKWAY AVENUE, TRENTON, NJ 08625, (1-609-530-2098).

13. THE ENGINEER SHALL NOT BE RESPONSIBLE FOR THE SAFETY AND CONSTRUCTION PROCEDURES, TECHNIQUES, OR THE FAILURE OF THE CONTRACTOR TO CARRY OUT THE WORK IN ACCORDANCE WITH THE DRAWINGS, SPECIFICATIONS, OR THE REQUIRED CODES. THE CONTRACTOR SHALL PROTECT THE PUBLIC FROM WORK AREA DURING CONSTRUCTION AND NON-CONSTRUCTION HOURS.

14. INSPECTION OF OR FAILURE TO INSPECT ANY MATERIALS OR WORKMANSHIP BY THE OWNER SHALL IN NO WAY RELIEVE THE CONTRACTOR OF HIS RESPONSIBILITIES TO PERFORM THE WORK IN ACCORDANCE WITH APPLICABLE PLANS, SPECIFICATIONS, AND LAWS.

15. ROADWAYS AND PARKING AREAS SHALL BE SWEPT CLEAN AT THE END OF EACH WORKING DAY.

16. THE CONTRACTOR SHALL BE RESPONSIBLE FOR RESTORING STONE, PAVING, CURB, SIDEWALK, TOPSOILING, SODDING, FERTILIZING AND SEEDING AT ALL AREAS DISTURBED BY THE CONSTRUCTION ACTIVITIES. TO A CONDITION AT LEAST EQUAL TO THAT WHICH EXISTED PRIOR TO THE START OF CONSTRUCTION.

17. SEPARATE PAYMENT WILL NOT BE MADE FOR CONSTRUCTION LAYOUT, DUST CONTROL AND REMOVAL & DISPOSAL OF EXCESS OR UNWANTED MATERIAL OR DEBRIS. THE COST OF THIS WORK SHALL BE INCLUDED IN THE LUMP SUM COST OF THE PROPOSAL.

18. THE CONTRACTOR SHALL BE RESPONSIBLE FOR REMOVAL OF ALL EXCESS MILLING AND EXCAVATED MATERIAL FROM THE PROJECT SITE. THE COST OF THIS WORK SHALL BE INCLUDED IN THE LUMP SUM COST OF THE PROPOSAL

19. PAYMENT WILL NOT BE MADE FOR ANY OBSTRUCTION REMOVAL, SUCH AS CONCRETE CURB, TREES, TREE ROOTS, VEGETATION, GRASS, TIMBER, DEBRIS, BRUSH, ROCK, ETC. WHICH MAY INTERFERE WITH THE PROPOSED CONSTRUCTION. THE COST OF THIS WORK SHALL BE INCLUDED IN THE LUMP SUM COST OF THE

20. SEPARATE PAYMENT WILL NOT BE MADE FOR SAWCUTTING OF ANY NATURE. THE COST OF THIS WORK SHALL BE INCLUDED IN THE LUMP SUM COST OF THE PROPOSAL.

21. THE CONTRACTOR SHALL INSTALL AND MAINTAIN SOIL EROSION & SEDIMENT CONTROL MEASURES THROUGHOUT THE DURATION OF THE PROJECT. THE COST OF THIS WORK SHALL BE INCLUDED IN THE LUMP SUM COST OF THE PROPOSAL

22. PRIOR TO CONSTRUCTION OF ANY SUBBASE, BASE OR PAVEMENT COURSE, ALL SOFT OR YIELDING PORTIONS OF THE SUBGRADE WHICH DO NOT ATTAIN THE REQUIRED STABILITY WILL BE REMOVED AND REPLACED WITH BORROW EXCAVATION, SELECTED MATERIAL, DESIGNATION I-13.

23. THE CONTRACTOR SHALL USE EXCAVATED MATERIALS FOR BACKFILL UNLESS OTHERWISE DIRECTED BY THE ENGINEER.

24. ALL FILL SHALL BE PLACED IN 8" LAYERS AND THOROUGHLY COMPACTED TO THE SATISFACTION OF THE ENGINEER. IF BORROW FILL IS REQUIRED, IT SHALL BE SUBJECT TO THE APPROVAL OF THE ENGINEER.

25. ANY UNSUITABLE MATERIAL ON THE SITE SHALL BE REMOVED FROM THE SITE AND DISPOSED OF AT APPROPRIATE PLACES AT NO COST TO THE OWNER.


26. ALL GRATING, LIDS, VALVE BOXES, WELL CAPS, SERVICE CAPS, ETC., SHALL BE RAISED BY CONTRACTORS SO THAT AFFECTED ITEMS ARE FLUSH W/ FINAL PAVING.

27. ALL VALVE, VENT, ROOF DRAINS OR CURB STOP BOXES DAMAGED BY CONTRACTOR SHALL BE REPAIRED OR REPLACED IN-KIND AS DIRECTED BY THE ENGINEER.


28. CONTRACTOR SHALL REMOVE AND/OR RESET ANY EXISTING FEATURES AS REQUIRED FOR THE CONSTRUCTION OF THE IMPROVEMENTS SHOWN ON THESE PLANS. THE COST OF THIS WORK SHALL BE INCLUDED IN THE LUMP SUM COST OF THE PROPOSAL


29. ALL PROPOSED CONCRETE DRIVEWAY, SIDEWALK, AND CURB SHALL BE POURED SEPARATELY WITH THE APPROPRIATE EXPANSION JOINT MATERIAL AND NOT MONOLITHICALLY. PAYMENT FOR JOINT MATERIAL FOR ALL PROPOSED CURB, DRIVEWAY, AND SIDEWALK WILL NOT BE MADE BUT THE COST SHALL BE INCLUDED IN THE LUMP SUM COST OF THE PROPOSAL.

30. CONSTRUCTION ACTIVITIES WHICH CREATE OBNOXIOUS AND UNNECESSARY DUST, FUMES, ODORS, SMOKE, VIBRATION OR GLARE NOTICEABLE IN OCCUPIED BUILDINGS ON SITE AND ADJOINING PROPERTIES AND STREETS SHALL NOT BE PERMITTED. IN ADDITION, CONSTRUCTION ACTIVITIES WHICH RESULT IN DAMAGE TO TREES AND LANDSCAPING IN OCCUPIED BUILDING ON SITE OR ADJOINING PROPERTIES SHALL NOT BE

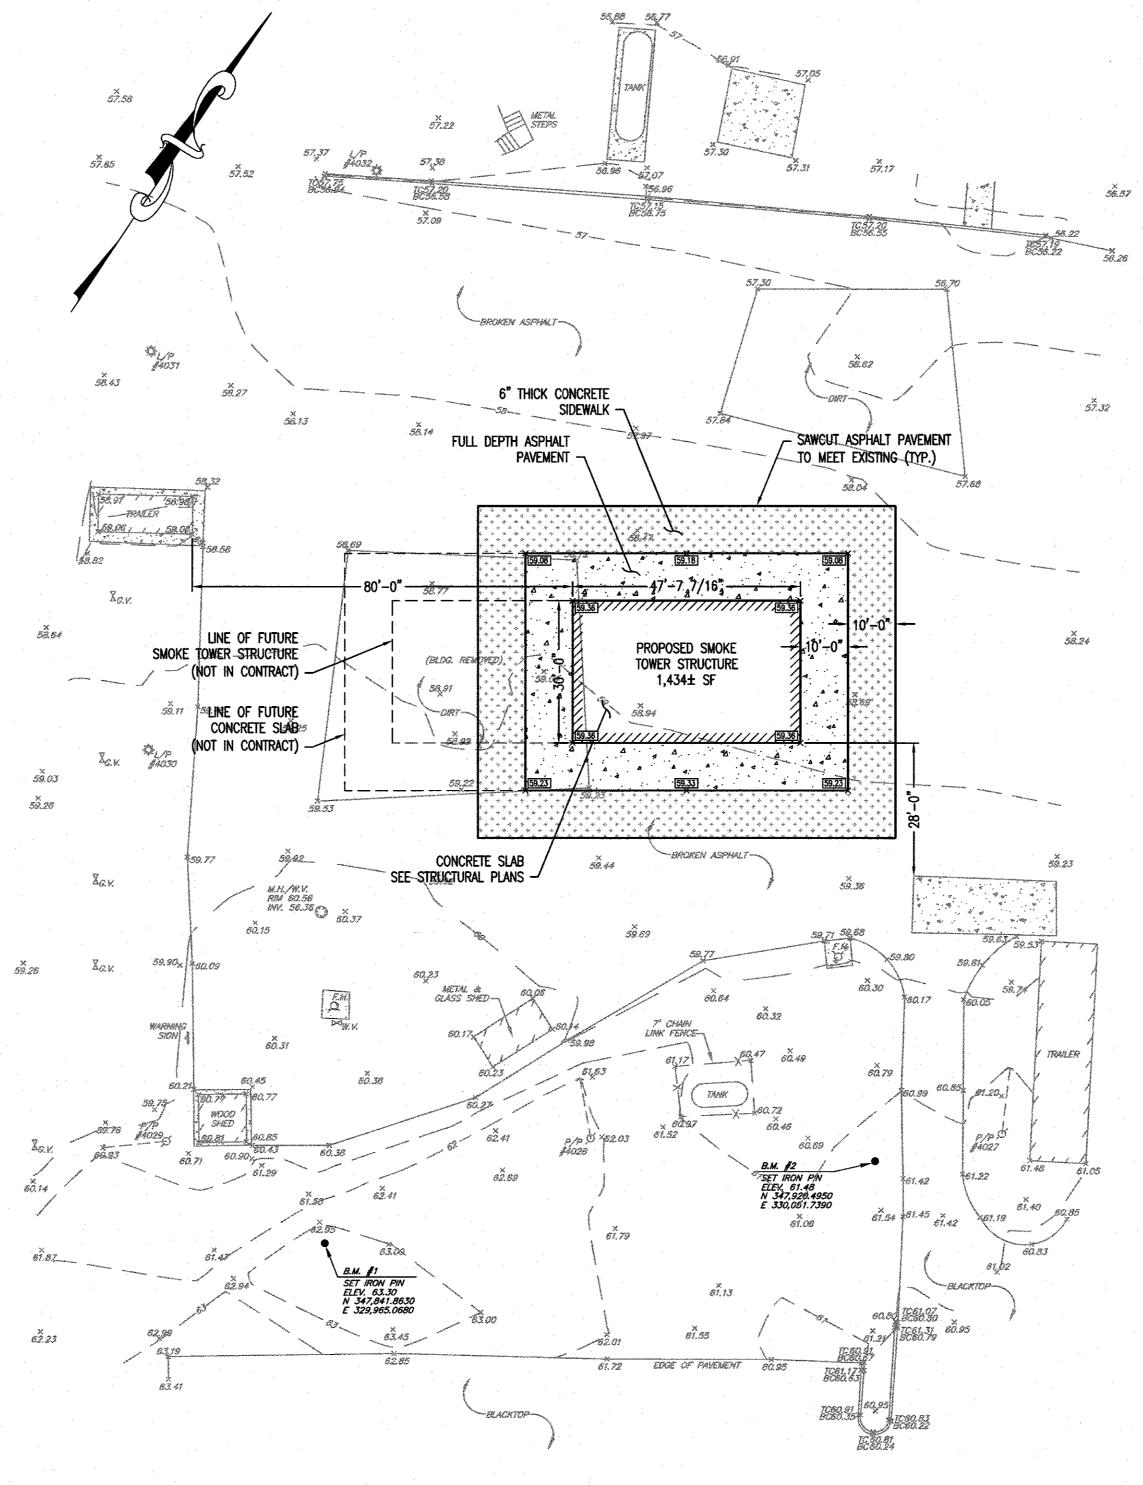


1 SITE PLAN
SCALE: 1: 20'

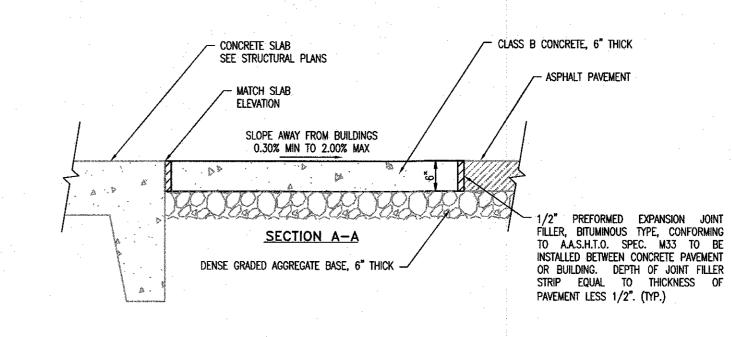

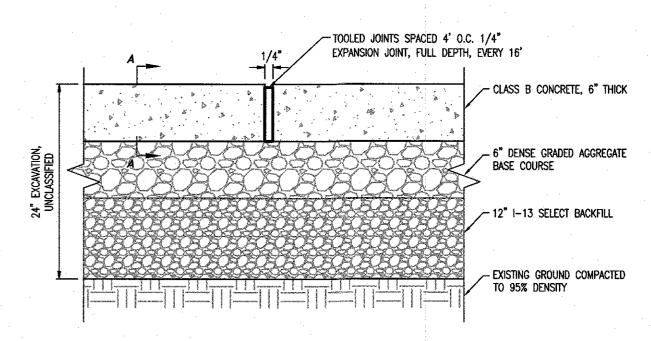

CONCRETE SIDEWALK AT BUILDING DETAIL SCALE: NTS

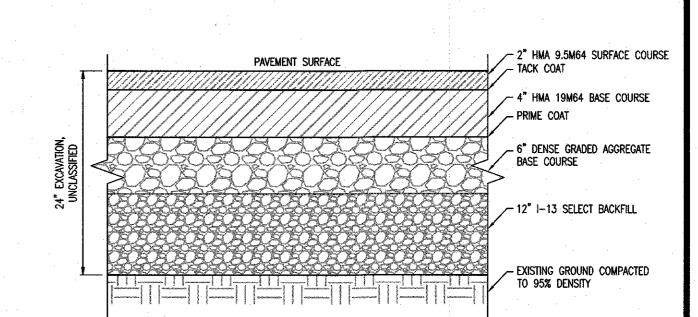

HOT MIX ASPHALT PAVEMENT DETAIL

NOTE:
CONTRACTOR REQUIRED TO EXCAVATE TO A DEPTH OF 24" (MINIMUM) AT ALL PROPOSED SITE IMPROVEMENT LOCATIONS. EXCAVATION SHALL NOT BE MEASURED FOR PAYMENT, BUT ALL COSTS ASSOCIATED WITH AND INCIDENTAL TO THE COMPLETION THEREOF SHALL BE INCLUDED UNDER THE LUMP SUM COST OF THE PROPOSAL.

NOTE:
ALL COSTS ASSOCIATED WITH AND INCIDENTAL TO THE COMPLETION OF SITE IMPROVEMENTS SHALL BE INCLUDED UNDER THE LUMP SUM COST OF THE PROPOSAL.

SITE IMPROVEMENTS SHALL GENERALLY CONSIST OF THE QUANTITIES AND CONTINGENCIES DESCRIBED IN THE "ESTIMATE OF QUANTITIES" TABLE, AND ALL LABOR AND MATERIALS INCIDENTAL TO AND REQUIRED FOR THE COMPLETION THEREOF.

SEE GEOTECHNNICAL ENGINEERING REPORT DATED 02/23/24 PREPARED BY DIGNEO ENGINEERING INCLUDED

IN THE PROJECT SPECIFICATIONS.

ESTIMATE OF QUANTITIES UNITS PLAN IF & WHERE CONTRACT QUANTITY DIRECTED QUANTITY 1 CLEARING SITE 2 DEWATERING EXCAVATION, UNCLASSIFIED 270 4 SOIL AGGREGATE, I-13 5 DENSE GRADED AGGREGATE BASE COURSE, 6" THICK SY 330 307 6 HOT MIX ASPHALT 19M64 BASE COURSE, 4" THICK 330 307 330 HOT MIX ASPHALT 9.5M64 SURFACE COURSE, 2"THICK 8 TACK COAT (IF & WHERE DIRECTED) 150 150 9 PRIME COAT (IF & WHERE DIRECTED) 10 CONCRETE SIDEWALK, 6" THICK SY 218 12 230

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NJ PROFESSIONAL ENGINEER No. 24GE04150700
NJ PROFESSIONAL PLANNER No. 33LI00555700
NJ REGISTERED ARCHITECT No. 21AI01487200

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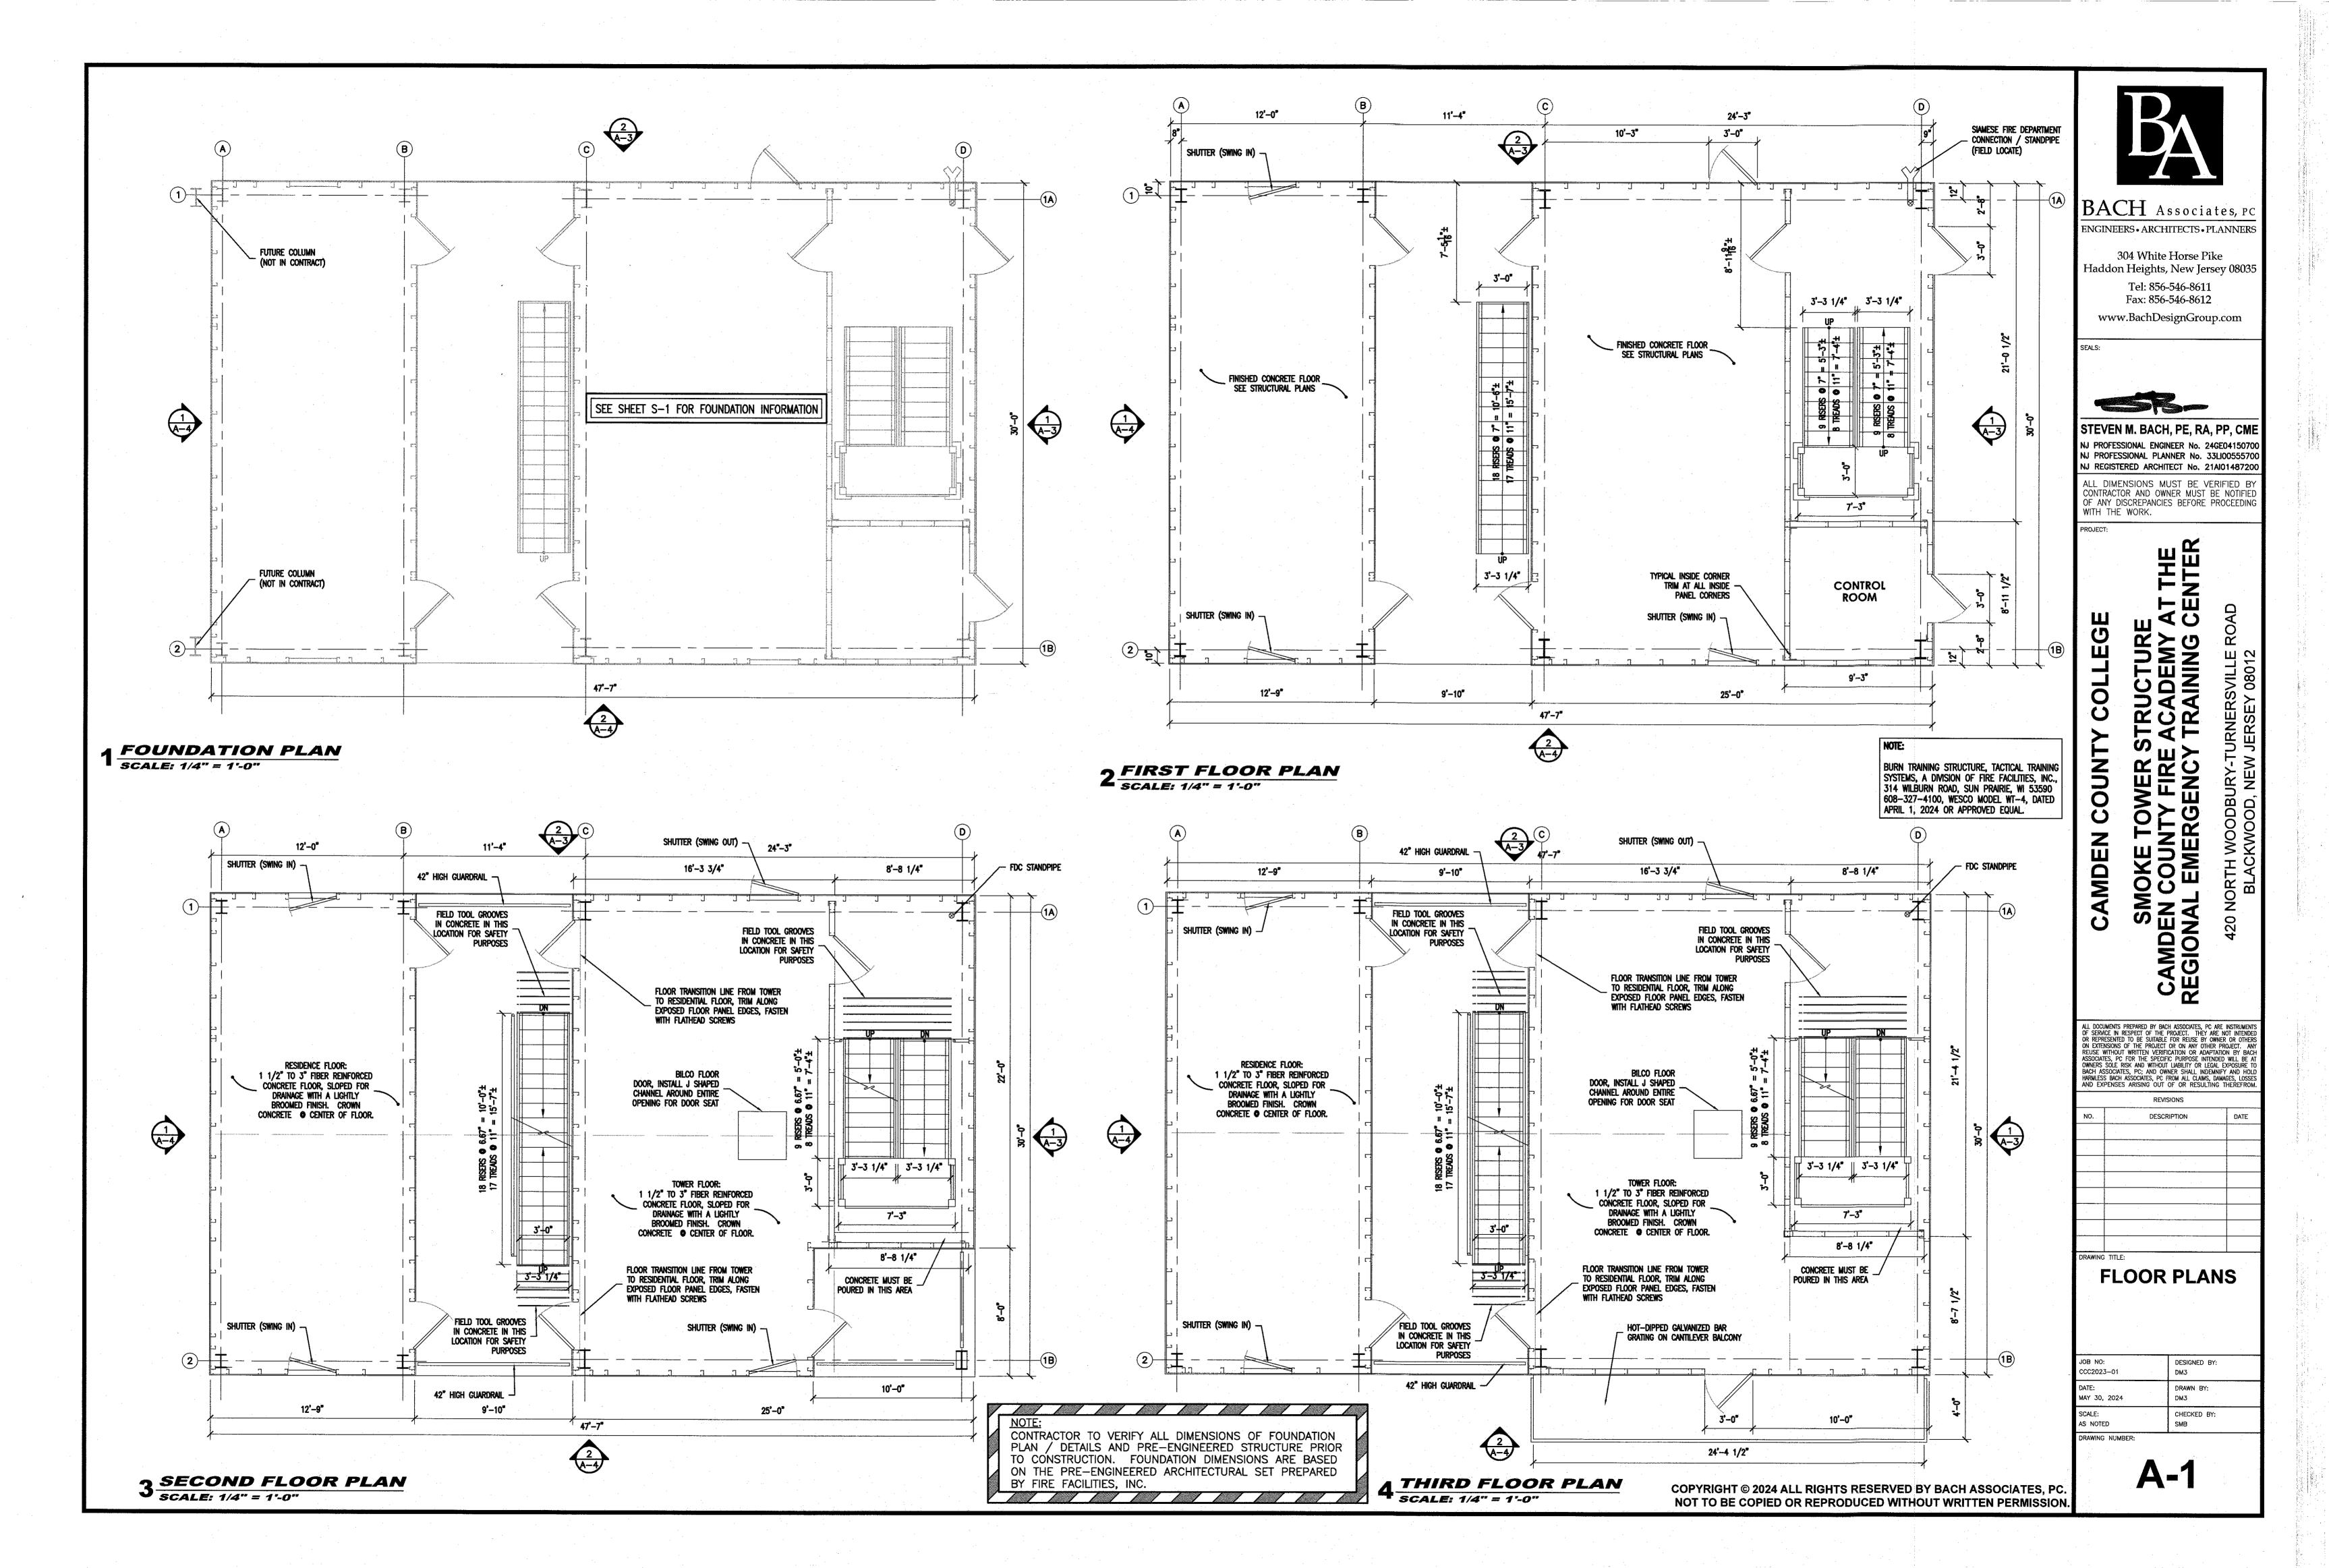
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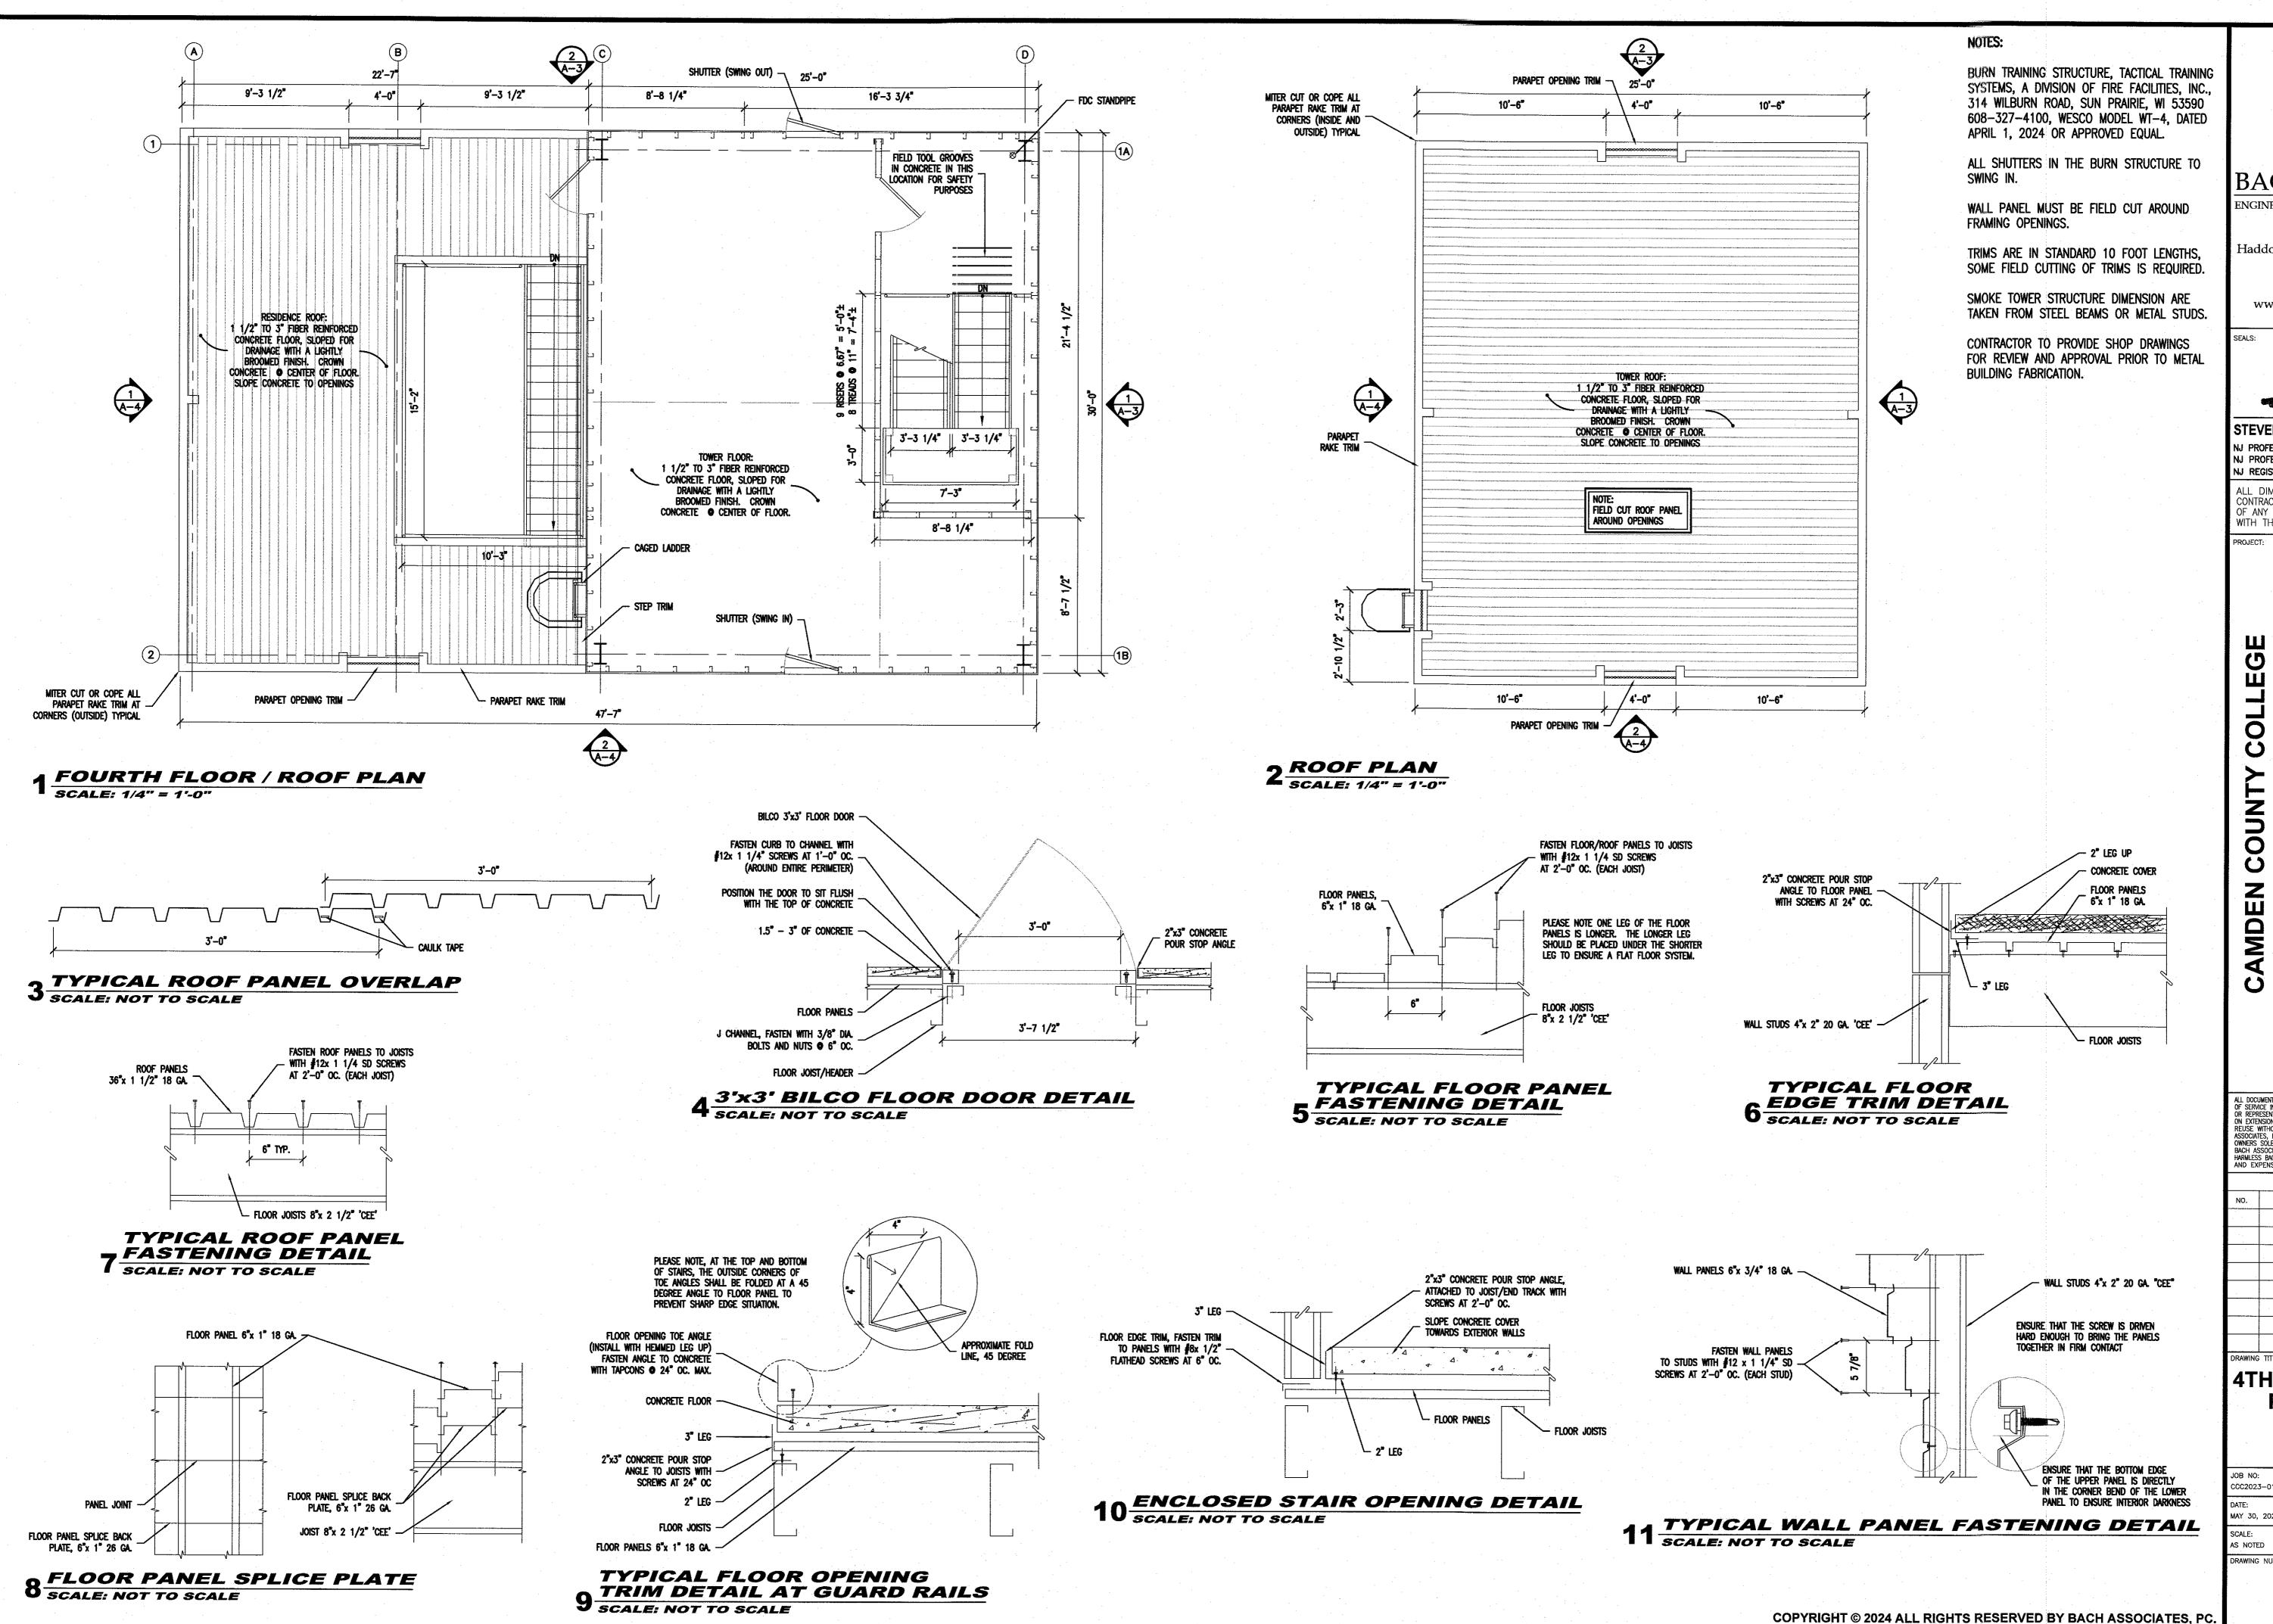
REVISIONS				
NO.	DESCRIPTION	DATE		
-				
DAMINO	TITLE.			

SITE PLAN, DETAILS AND QUANTITIES

JOB NO:	DESIGNED BY:
CCC2023-01	DM3
DATE:	DRAWN BY:
MAY 30, 2024	DM3
SCALE:	CHECKED BY:
AS NOTED	SMB
DRAWING NUMBER:	4.

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STEVEN M. BACH, PE, RA, PP, CME NJ PROFESSIONAL ENGINEER No. 24GE04150700 NJ PROFESSIONAL PLANNER No. 33LI0055570 NJ REGISTERED ARCHITECT No. 21AI01487200 ALL DIMENSIONS MUST BE VERIFIED E

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DESCRIPTION

4TH FLOOR, ROOF **PLANS AND DETAILS**

CCC2023-01 DM3 DRAWN BY: CHECKED BY: AS NOTED DRAWING NUMBER:

A-2

BURN TRAINING STRUCTURE, TACTICAL TRAINING SYSTEMS, A DIVISION OF FIRE FACILITIES, INC., 314 WILBURN ROAD, SUN PRAIRIE, WI 53590 608-327-4100, WESCO MODEL WT-4, DATED APRIL 1, 2024 OR APPROVED EQUAL.



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REVISIONS DATE DESCRIPTION

ELEVATIONS AND DETAILS

DESIGNED BY: CCC2023--01 DRAWN BY: CHECKED BY: AS NOTED DRAWING NUMBER:

A-3

PARAPET OPENING TRIM 10'-6" ROOF (CONCRETE) CORNER TRIM, TAPE CAULK
BETWEEN TRIMS AND CAULK
TO CREATE SEAL SHUTTER (SWING OUT) NOTCH TRIM PARAPET OPENING TRIM FOURTH FLOOR (CONCRETE) SHUTTER (SWING IN) THIRD FLOOR (CONCRETE) 42" HIGH GUARDRAIL CONCRETE POUR STOP ANGLE SHUTTER (SWING IN) (SWING OUT) SECOND FLOOR (CONCRETE) - RAKE TRIM SHUTTER (SWING IN) 3.4 TOP OF 4" CURB 47'-7" SIAMESE FIRE DEPARTMENT CONNECTION STANDPIPE SILL PANEL AROUND ENTIRE PERIMETER (TYPICAL) 2 RIGHT ELEVATION SCALE: 1/4" = 1'-0"

1 FRONT ELEVATION
SCALE: 1/4" = 1'-0"

WALL PANELS 6"x 3/4" 18 GA. —

FASTEN TRIM TO STUDS WITH
#12x 1 1/4" SD SCREWS —
AT 2'-0" OC. (EACH STUD)

CORNER TRIM

TRANSITION TRIM


WALL PANEL 3/4"x 6" 18 GA -ANGLE TRIM AND FASTEN WITH POP RIVETS • 18" OC. FASTEN TRIM TO PANEL WITH #12x 3/4" SD SCREWS • 6" OC. -(CENTER OF EACH PANEL)

WALL PANEL 3/4"x 6" 18 GA ANGLE TRIM AND FASTEN WITH POP RIVETS © 18" OC. FASTEN TRIM TO PANEL WITH #12x 3/4" SD SCREWS • 6" OC. — (CENTER OF EACH PANEL)

TYPICAL EXTERIOR

5 CORNER TRIM DETAIL
SCALE: NOT TO SCALE

4 CORNER TRIM DETAIL SCALE: NOT TO SCALE

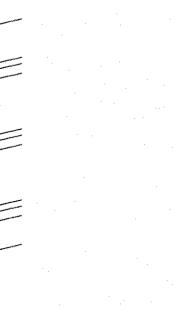

WALL PANEL SPLICE BACK PLACE, 6"x 3/4" 36 GA. WALL PANEL SPLICE BACK PLACE, 6"x 3/4" 36 GA. _ Wall studs 4"x 2" 20 Ga. "Cee" WALL PANEL 6"x 3/4" 18 GA.

6 WALL PANEL SPLICE PLATE SCALE: NOT TO SCALE

42" HIGH GUARDRAIL

30'-0"

WALL STUDS 4"x 2" 20 GA. "CEE"

STUD WALL TRACK 4"x 2"
20 GA CHANNEL

FOUNDATION ——

3 TYPICAL SILL DETAIL SCALE: NOT TO SCALE

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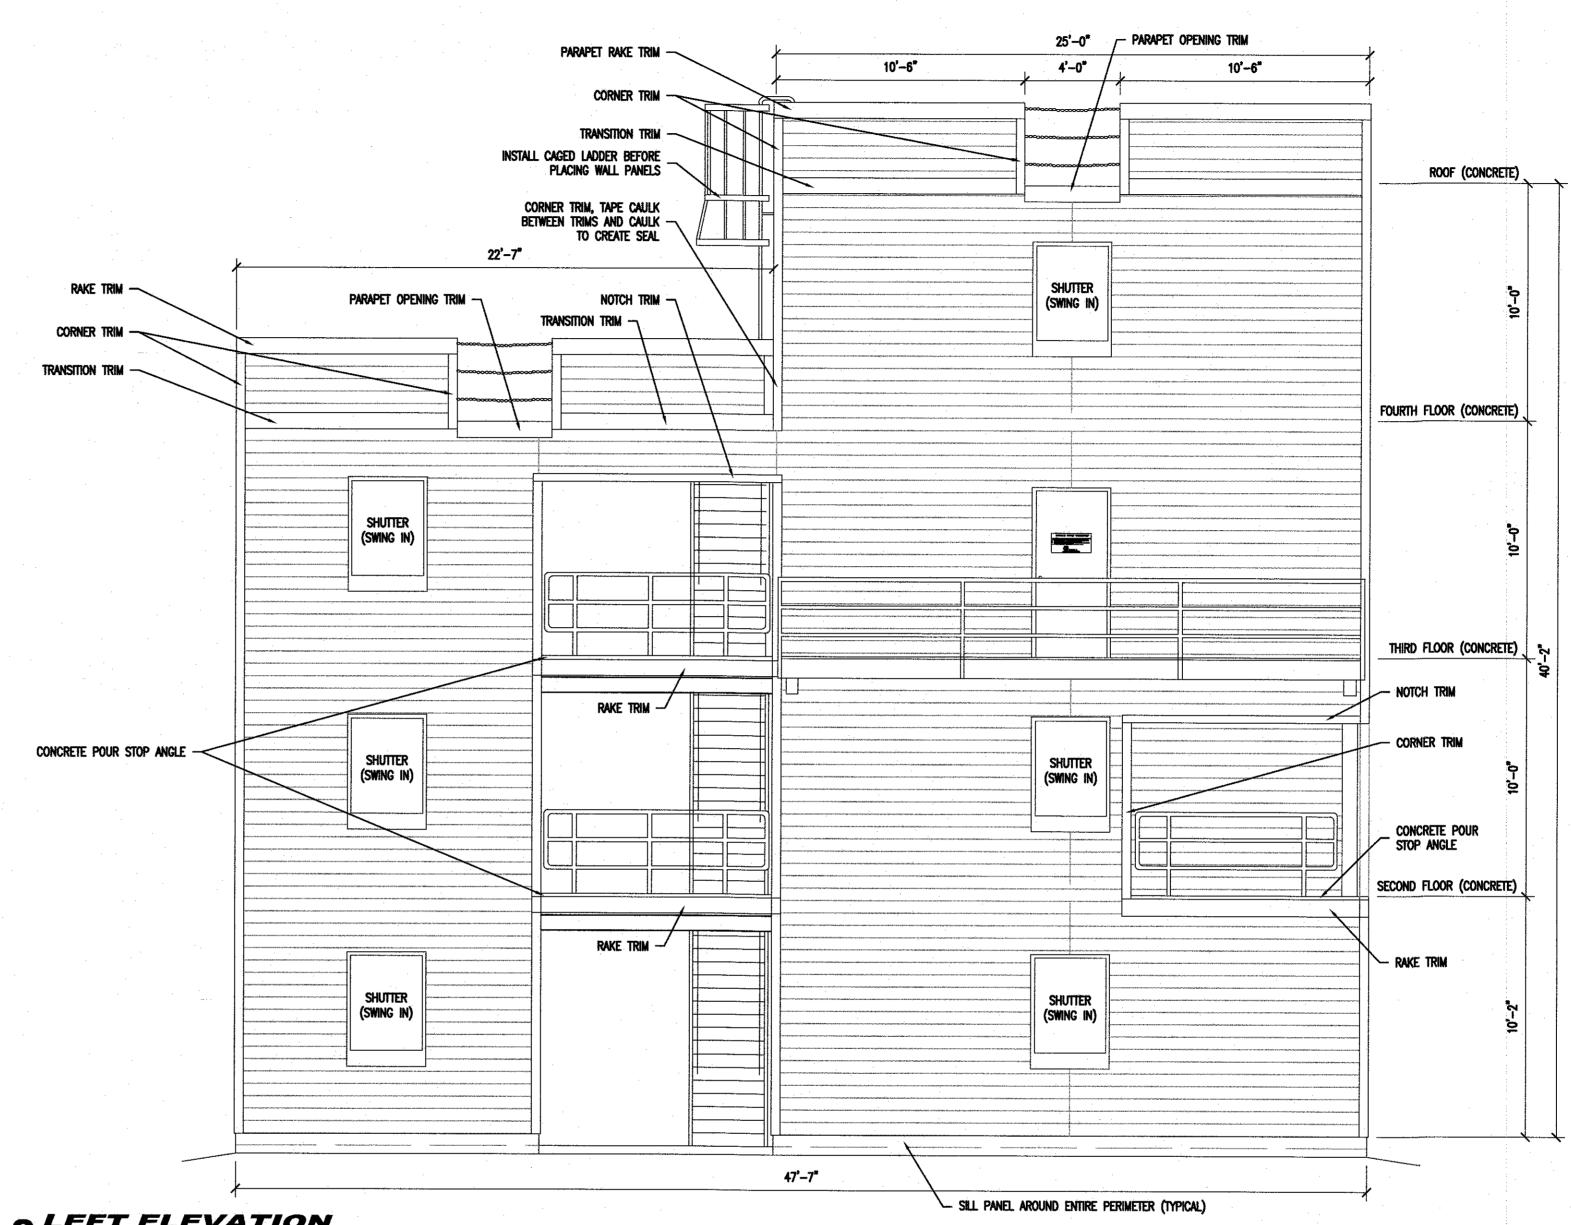
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ELEVATIONS AND DETAILS

JOB NO:
CCC2023—01


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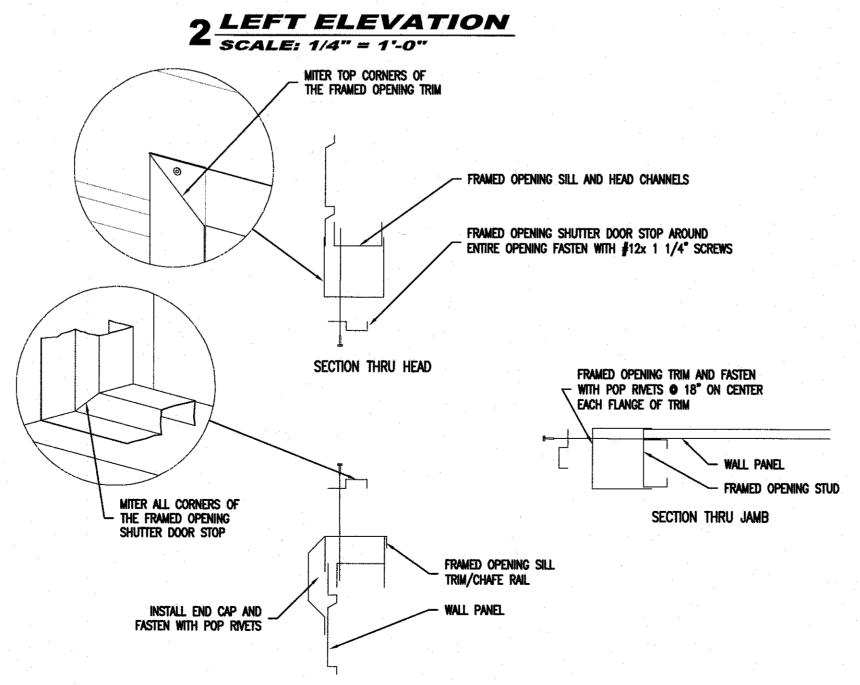


1 REAR ELEVATION

SCALE: 1/4" = 1'-0"



30'-0"

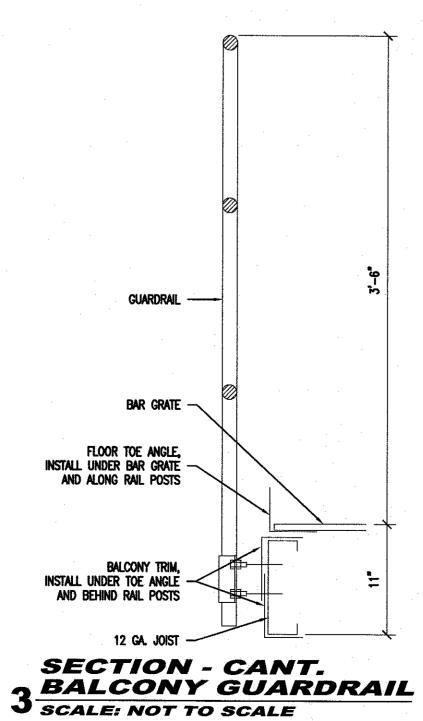

SECTION THRU SILL

4 STANDARD SHUTTER TRIM DETAILS

SCALE: NOT TO SCALE

FRAMED OPENING TRIM

FRAMED OPENING HEAD CHANNELS

FRAMED OPENING TRIM AND FASTEN
WITH POP RIVETS © 18" ON CENTER
EACH FLANGE OF TRIM

WALL PANEL

FRAMED OPENING STUD

SECTION THRU JAMB

5 TOWER SWING DOOR TRIM DETAILS

SCALE: NOT TO SCALE

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<u>GENERAL</u>

- 1. STRUCTURAL CONSTRUCTION DOCUMENTS SHALL BE USED WITH OTHER CONSTRUCTION DOCUMENTS, INCLUDING ARCHITECTURAL AND SITE DOCUMENTS COORDINATE WITH THESE DOCUMENTS FOR LOCATIONS AND DIMENSIONS NOT INDICATED ON THE STRUCTURAL DOCUMENTS.
- ALL DIMENSIONS AND CONDITIONS SHALL BE FIELD VERIFIED. THE ENGINEER SHALL BE NOTIFIED OF DISCREPANCIES PRIOR TO PROCEEDING WITH THE AFFECTED PORTION OF THE WORK.
- SECTIONS AND DETAILS SHOWN ON ANY STRUCTURAL DOCUMENTS SHALL BE CONSIDERED TYPICAL FOR SIMILAR CONDITIONS THAT DO NOT HAVE A SPECIFIC SECTION INDICATED, AND SHALL BE PROVIDED AT NO ADDITIONAL COST TO THE
- APPLICABLE FEDERAL, STATE AND MUNICIPAL REGULATIONS SHALL BE FOLLOWED, INCLUDING THE FEDERAL DEPARTMENT OF LABOR OSHA
- THE CONTRACTOR IS RESPONSIBLE FOR LIMITING THE AMOUNT OF CONSTRUCTION LOAD IMPOSED ON THE STRUCTURE. CONSTRUCTION LOADS SHALL NOT EXCEED THE SPECIFIED DESIGN LOADS. CONCRETE FOUNDATIONS SHALL NOT BE LOADED UNTIL THE CONCRETE HAS REACHED AT LEAST 75% OF THE SPECIFIED DESIGN COMPRESSIVE STRENGTH.
- IN THE ABSENCE OF SPECIFIC INSTRUCTIONS TO THE CONTRARY IN THE CONTRACT DOCUMENTS, THE TRADE PRACTICES THAT ARE DEFINED IN ANY CODE OF STANDARD PRACTICE SHALL GOVERN.

STRUCTURAL DESIGN CRITERIA

DESIGN LOADS ARE IN ACCORDANCE WITH THE 2021 INTERNATIONAL BUILDING CODE, NEW JERSEY EDITION, ASCE 7-16 AND LOCAL CODE. DESIGN DEAD LOADS

100 PSF

- 50 PSF FLOORS 50 PSF DESIGN LIVE LOADS 100 PSF
- FL00RS OCCUPANCY GROUP = U (UTILITY & MISCELLANEOUS)
- RISK CATEGORY = II
 - SNOW LOADING IS BASED ON THE FOLLOWING. GROUND SNOW LOAD (Pq) 20 PSF FLAT-ROOF SNOW LOAD (PF) 16.8 PSF SNOW EXPOSURE FACTOR (Ce) 1.0 SNOW LOAD IMPORTANCE FACTOR (I) 1.0
- SNOW THERMAL FACTOR (Ct) 1.2 WIND LOADING IS BASED ON THE FOLLOWING: ULTIMATE WIND SPEED (3 SEC GUST) 115 MPH 89.1 MPH NOMINAL WIND SPEED
- WIND IMPORTANCE FACTOR 1.0 WIND EXPOSURE SEISMIC LOADING IS BASED ON THE FOLLOWING:
 - SEISMIC IMPORTANCE FACTOR 1.0 SPECTRAL RESPONSE ACCEL. (9s) 0.170q SPECTRAL RESPONSE ACCEL. (S1) 0.046q SITE CLASS (PRESUMED) SPECTRAL RESPONSE COEFF. (Sds) 0.181 SPECTRAL RESPONSE COEFF. (Sd1) 0.073 SEISMIC DESIGN CATEGORY

FOUNDATIONS

- FOUNDATIONS HAVE BEEN DESIGNED BASED UPON THE GEOTECHNICAL ENGINEERING REPORT PREPARED BY DIGNEO ENGINEERING, DATED FEBRUARY 23, 2024. SPREAD FOOTINGS SHALL BEAR ON UNDISTURBED SOIL OR COMPACTED STRUCTURAL
- FILL HAVING A MINIMUM SAFE BEARING CAPACITY OF 3,000 PSF. THE BOTTOMS OF EXTERIOR FOOTINGS SHALL BE 36 IN. MINIMUM BELOW FINISHED
- EDGES OF FOOTINGS SHALL NOT BE PLACED AT A GREATER THAN 1 (VERTICAL) TO 2 (HORIZ) SLOPE WITH RESPECT TO ANY ADJACENT FOOTING OR EXCAVATION. FOUNDATION CONCRETE SHALL BE NORMAL WEIGHT HAVING A MINIMUM 28 DAY
- SPREAD FOOTINGS & PIERS 3000 PSI SLAB-ON-GRADE (EXTERIOR) 4500 PSI, 0.45 W/C MAX.
- 6. PROVIDE 6% (±1") AIR-ENTRAINMENT IN ALL CONCRETE.

DESIGN COMPRESSIVE STRENGTH AS FOLLOWS:


FOUNDATION SUBGRADE PREPARATION REQUIREMENTS 1. THE BUILDING SITE SHALL BE STRIPPED OF ANY TOPSOIL, ORGANIC MATTER,

- VEGETATION, FILL MATERIALS, AND OTHERWISE UNSUITABLE OR SOFT SUBGRADE MATERIALS. EXCAVATION SHALL EXTEND A MINIMUM OF 24 INCHES BELOW GRADE, AS INDICATED
- IN THE GEOTECHNICAL ENGINEERING REPORT PROVIDED IN THE SPECIFICATIONS BOOK. THESE UNSUITABLE MATERIALS SHALL BE EXCAVATED DOWN TO RESIDUAL SOIL ELEVATIONS, UNDER THE DIRECTION OF THE APPROVED INSPECTION AGENCY, AND THE EXCAVATION BACKFILLED WITH COMPACTED STRUCTURAL FILL. SOIL BEARING CAPACITY SHALL BE VERIFIED BY THE APPROVED INSPECTION AGENCY PRIOR TO
- BACKFILLING EXCAVATIONS. COMPACTED STRUCTURAL FILL SHALL CONSIST OF ML OR BETTER MATERIAL (ASTM D2487-11) WITH A MAXIMUM PARTICLE SIZE OF 3 INCHES, AND SHALL BE PLACED ON APPROVED SUBGRADE IN LIFTS NOT EXCEEDING 8 INCHES IN LOOSE THICKNESS, AND SHALL BE COMPACTED TO AT LEAST 98% OF THE MAX. DRY DENSITY ACCORDING TO ASTM D698, STANDARD PROCTOR.
- AT SLAB-ON-GRADE AREAS, FOLLOWING STRIPPING, THE SUBGRADES SHALL BE PROOFROLLED WITH A LOADED TANDEM AXLE DUMP TRUCK OR TEN-TON ROLLER UNDER OBSERVATION OF THE APPROVED INSPECTION AGENCY. AREAS WHICH EXHIBIT EXCESSIVE PUMPING OR WEAVING AS DETERMINED BY THE APPROVED INSPECTION
- AGENCY SHALL BE REMOVED AND REPLACED WITH NEW COMPACTED STRUCTURAL FILL. COMPACTED FILL SHALL BE USED TO RAISE EXISTING GRADES TO THE PROPOSED NEW ELEVATION, WHERE REQUIRED. A 4 INCH WASHED GRAVEL OR CRUSHED STONE DRAINAGE LAYER CORRESPONDING TO AASHTO SIZE NO. 57 AGGREGATE SHALL BE USED BENEATH THE SLAB-ON-GRADE.

CONCRETE REINFORCING

FOLLOWS:

- REINFORCED CONCRETE CONSTRUCTION SHALL CONFORM TO ACI 318-14. CONCRETE REINFORCING SHALL CONFORM TO THE FOLLOWING DESIGNATIONS: ASTM A615, GRADE 60 DEFORMED BARS
- WELDED WIRE FABRIC ASTM A185 LAP DEFORMED BARS 40 DIA., UNO. PROVIDE CORNER AND L BARS AT CORNERS AND INTERSECTIONS. REINFORCING INDICATED AS CONTINUOUS SHALL BE LAPPED. HOOKS SHALL BE STANDARD HOOKS, UNO. LAP WELDED WIRE FABRIC SUCH THAT THE OVERLAP OF THE OUTERMOST CROSS-WIRES OF EACH ADJOINING SHEET IS NOT LESS THAN THE SPACING OF THE CROSS-WIRES PLUS TWO IN., UNO.
- CONCRETE PROTECTION FOR REINFORCEMENT: CONCRETE CAST AGAINST AND PERMANENTLY EXPOSED TO EARTH: 3 IN. CONCRETE EXPOSED TO EARTH OR WEATHER:
- NO. 6 THROUGH NO. 18 BARS: NO. 5 BAR AND SMALLER: 1-1/2 IN. 5. REINFORCING FOR SLABS ON GRADE, WHERE NOT OTHERWISE SPECIFIED, SHALL BE AS
- REINFORCING BARS: SEE FOUNDATION AND TYPICAL DETAILS. AT SLAB BLOCKOUT AND RE-ENTRANT CORNERS, PROVIDE 2-#4 X 4'-0" DIAGONALS. MIRE MESH: 6x6-W2.1 x W2.1 WMF. REINFORCING SHALL BE SUPPORTED AT
- MID-DEPTH OF SLAB. DETAILING OF CONCRETE REINFORCING AND ACCESSORIES SHALL CONFORM TO ACI DETAILING MANUAL SP-66, AND WITH ACI 315, MANUAL OF STANDARD PRACTICE FOR DETAILING REINFORCED CONCRETE STRUCTURES.

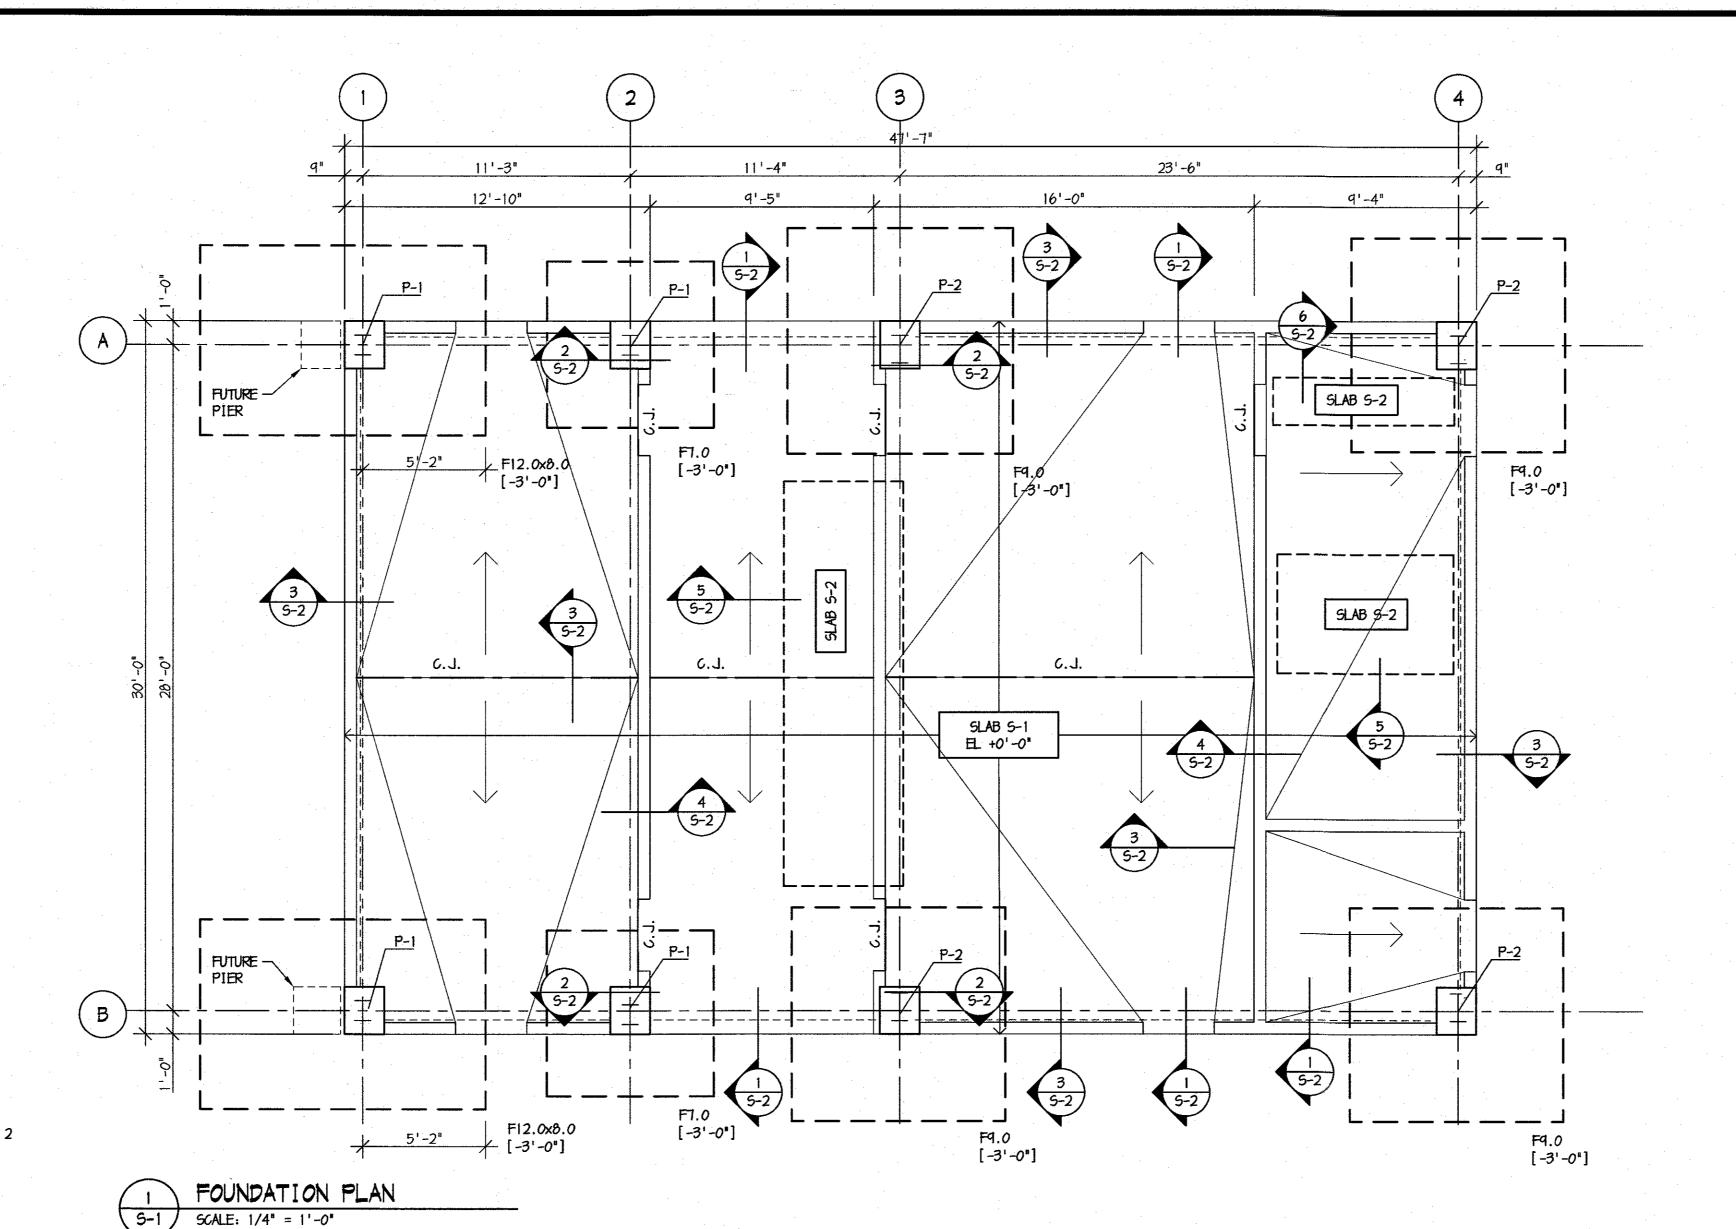

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> 304 White Horse Pike Haddon Heights, New Jersey 08035 Tel: 856-546-8611

INDICATES TOP OF CONCRETE SLAB [-#'-#"] INDICATES TOP OF FOOTING 3. FOUNDATION MEMBERS SHALL BE AT THE FOLLOWING ELEVATIONS, UNO: SLABS = +0'-0"

FOOTINGS = -3'-0"PIERS = +0'-4"CURBS = +0'-4"

4. FOUNDATION MEMBERS ARE DESIGNATED AS FOLLOWS: FOOTING MARK - SEE SCHEDULE.

ELEVATIONS ARE NOTED FROM REF EL 0'-0 AS FOLLOWS:

- PROVIDE (2) #4 x 4'-0" DIAGONAL BARS AT ALL RE-ENTRANT SLAB-ON-GRADE CORNERS, SEE DETAIL 5/5-2.

SLAB SCHEDULE

SLAB 5-1: 6" CONC. SLAB ON GRADE W/ 6x6-W2.9xW2.9 WINF ON 4" COMPACTED GRANULAR BASE

SLAB 5-2: 8" CONC. SLAB ON GRADE W/ 6x6-N2.9xN2.9 WHE TOP & #4 @ 12" o/c BOTTOM EA WAY ON 4" COMPACTED GRANULAR BASE

CONCRETE PIER SCHEDULE			
MARK	SIZE	REINFORCING	
P-1	20"×24"	(6)#6 VERT. #3 TIES € 12" o/c	
P-2	20"×24"	(6)#6 VERT. #3 TIES @ 12" o/c	

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COLUMN FOOTING SCHEDULE			
MARK	SIZE	REINFORCING	
F1.0	7'-0" x 7'-0" x 1'-6"	7-#6 BOT. EN	
F9.0	9'-0" x 9'-0" x 2'-0"	9-#7 BOT. EW	
F12.0x8.0	12'-0" × 8'-0" × 2'-0"	8-#7 BOT. LW 12-#7 BOT. SW	

FOUNDATION PLAN NOTES

FLOOR SLAB + 0'-0" IS REFERENCED RELATIVE TO ELEVATION 60.0'. Fax: 856-546-8612 www.BachDesignGroup.com

Brian D. McGlade, PE NJ PE # 34227

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DRAWING	TITLE:	
	FOUNDATION	1

PLAN

APRIL 23, 2024 CHECKED BY: AS NOTED

TYPICAL DETAILS

- TYPICAL DETAILS APPLY AT ALL APPROPRIATE LOCATIONS.
- 2. TYPICAL DETAILS ARE GENERALLY NOT OUT ON THE PLANS. 3. CONTRACTOR IS RESPONSIBLE FOR COORDINATING ALL TYPICAL DETAIL APPLICATIONS.


SUBMITTALS


- 1. CONCRETE FOUNDATIONS & SLABS: CONCRETE MIX DESIGNS FOR STRENGTHS INDICATED
- 2. PRE-ENGINEERED METAL BUILDING: DETAILED SHOP DRAWINGS AND STRUCTURAL CALCULATIONS PREPARED BY A PROFESSIONAL ENGINEER LICENSED IN NEW JERSEY

<u>DESIGN COLUMN LOADS</u> FROM METAL BUILDING MANUFACTURER

CONCRETE REINFORCING SHOP DRAWINGS

- 1. 40 FOOT TALL TOWER COLUMNS: 6RAYITY = 250 KIPS
- UPLIFT = 10 KIPS LATERAL = 19 KIPS
- 2. 30 FOOT TALL RESIDENCE COLUMNS: 6RAVITY = 145 KIPSUPLIFT = 4 KIPS LATERAL = 12 KIPS
- 3. FOUNDATION DESIGN IS BASED UPON THE LOADS SHOWN ABOVE. FOUNDATION DESIGN WILL BE REVIEWED FOLLOWING SUBMISSION OF METAL BUILDING SHOP DRAWINGS TO DETERMINE IF ANY REVISIONS TO THE DESIGN ARE REQUIRED.

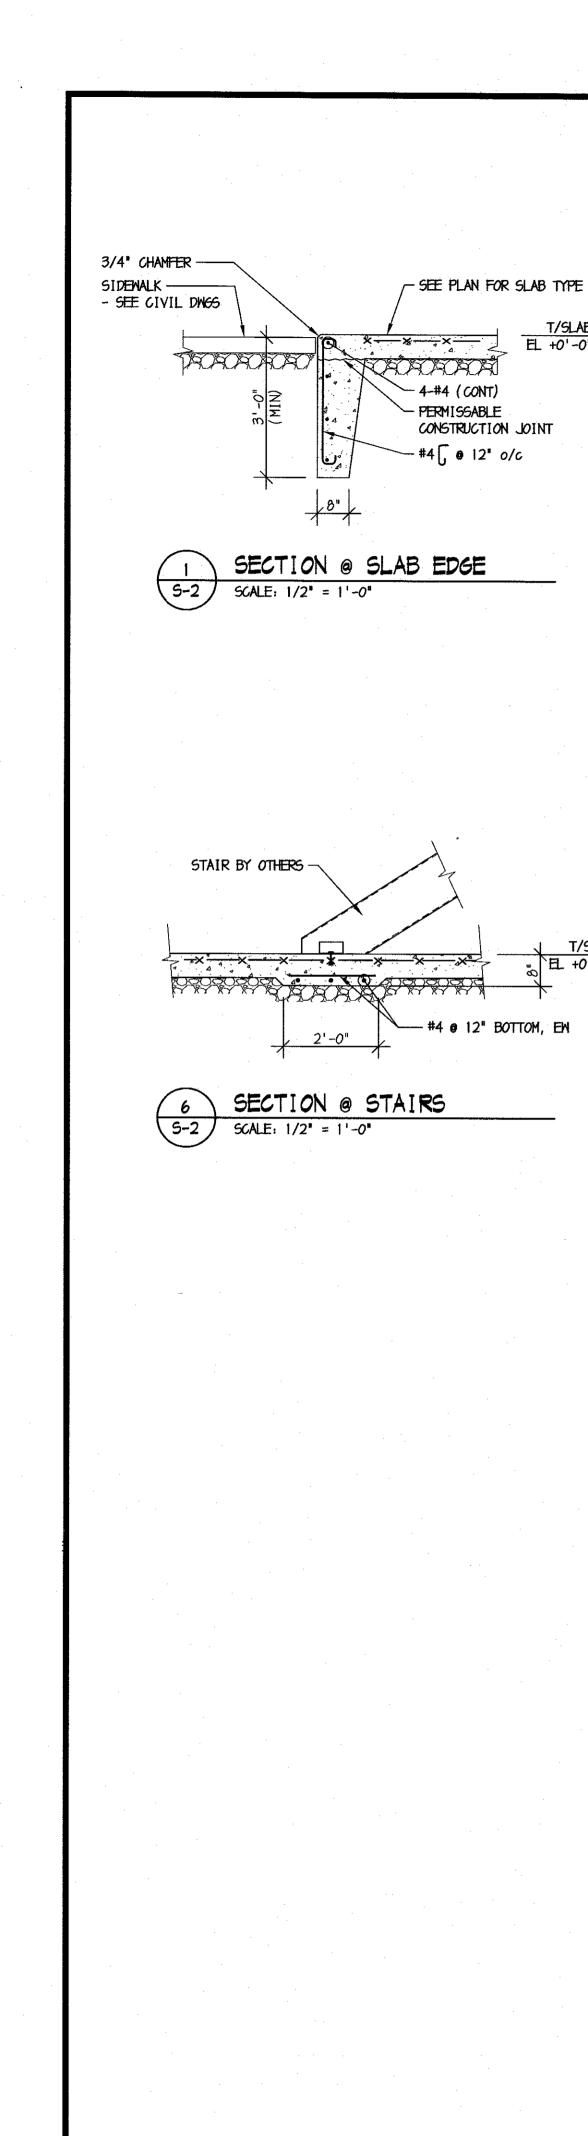

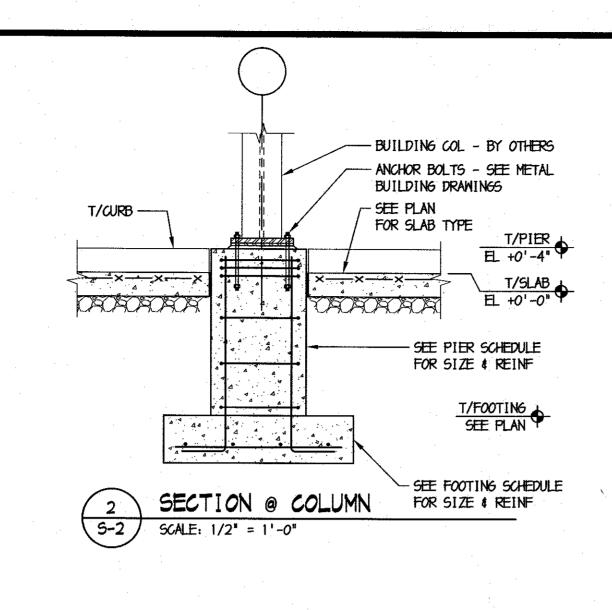

-x-x-x-x-x-x-x-

(5-2) SCALE: 1/2" = 1'-0"

SLAB CONTROL JOINT DETAIL

LEAVE GROOVE -

FILL GROOVE -

SLAB REINF —— DISCONT. INUOUS

w/ SEALANT

OPEN

- 1/8" WIDE x 1/4th SLAB


PERMANENT 24 6A 6ALV PREFORMED STRIP w/

REMOVABLE PLASTIC CAP

- SLAB REINF DISCONT. INUOUS

DEPTH SANCUT. CUT JOINTS AS SOON AS SAW WILL NOT


DISLODGE AGGREGATE IN SLAB

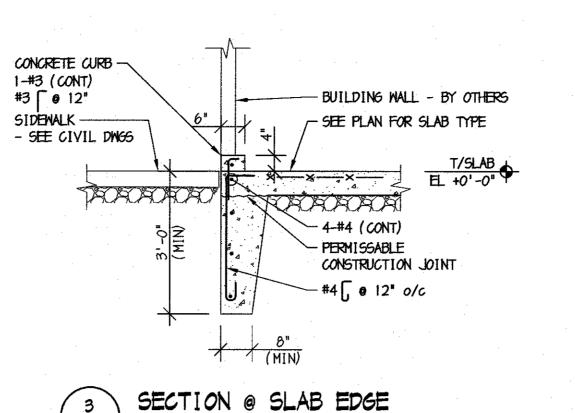


SLAB REINFORCING DETAILS


SCALE: 1/2" = 1'-0"


SCALE: 1/2" = 1'-0"

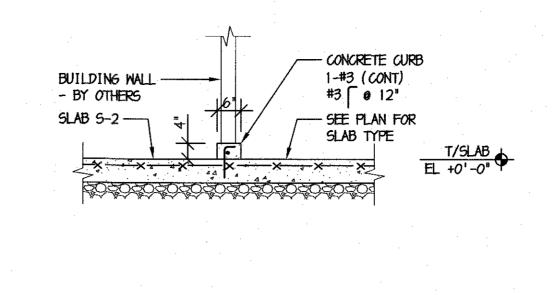

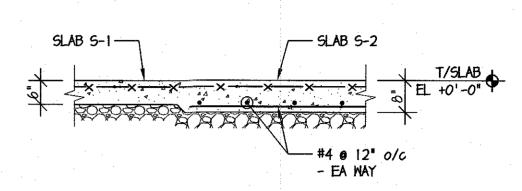



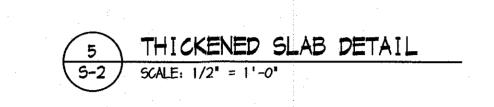

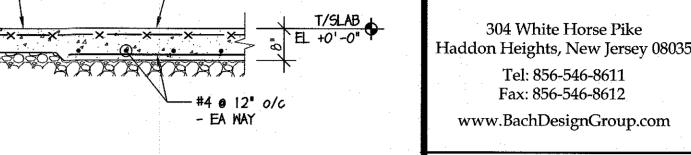

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420 NORTH WOOD BLACKWOOI

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DETAILS

ELECTRICAL SYMBOLS SCHEDULE ELECTRICAL DEVICES COMMUNICATIONS POWER DISTRIB. THIS IS A COMPLETE LIST OF ELECTRICAL SYMBOLS FOR REFERENCE ONLY. SINGLE-POLE DOUBLE-POLE 3-WAY AND 4-WAY SWITCHES SYMBOLS SHOWN HERE MAY OR MAY NOT SURFACE MTD PANELBOARD TELEPHONE OUTLET BE USED ON THIS PROJECT. FLUSH MTD PANELBOARD SINGLE POLE SWITCH - WEATHERPROOF WALL MTD TELE OUTLET GENERAL SYMBOLS DUAL LEVEL SWITCHING INSIDE/OUTSIDE LAMP CONTROL DATA OUTLET 277/480V PANEL KEY-LOCK SWITCH KEY NOTE INDICATOR COMBINATION TELE/DATA OUTLET 120/208V PANEL COMBINATION TELE/DATA OUTLET AT LIGHTED-HANDLE SWITCH EQUIPMENT INDICATOR MOTOR CONNECTION TELE/DATA OUTLET FLUSH FLOOR MOUNTED CENTER-OFF DOUBLE-POLE SWITCH SCHEDULED ITEM INDICATOR DISCONNECT SWITCH EXPLOSION-PROOF SWITCH COMBINATION POWER & TELE/DATA OUTLET DRAWING REVISION INDICATOR MAGNETIC STARTER FLUSH FLOOR MOUNTED LOCAL WALL DIMMER SWITCH COMBINATION STARTER/DISCONNECT TELE/DATA CONDUIT STUB-UP CONDUIT AND WIRING LOW-VOLTAGE SWITCH POWER COMPANY METER MANUAL TOGGLE SWITCH WITH THERMAL OVERLOAD BRANCH CIRCUIT RUN CONCEALED C. T. CABINET FIRE ALARM SYSTEM EMERGENCY POWER-OFF SWITCH BRANCH CIRCUIT RUN UNDER FLOOR JUNCTION BOX - CEILING MOUNTED TIMECLOCK BRANCH CIRCUIT UP OR DOWN JUNCTION BOX - FLOOR MOUNTED MANUAL PULL STATION **PHOTOCELL** \mathbb{Z} HORN AND FLASHING LIGHT HOME RUN TO PANEL 2A CKTS 1, 3, & 5 POWER SYSTEMS RELAY W/ NUMBER AND TYPE OF POLES AS INDICATED CHIME AND FLASHING LIGHT EMERGENCY ONLY BRANCH CIRCUIT TRANSFORMER FIRE ALARM BELL SINGLE RECEPTACLE NIGHT LIGHT BRANCH CIRCUIT ATS AUTOMATIC TRANSFER SWITCH FLASHING LIGHT DUPLEX RECEPTACLE LOW VOLTAGE CIRCUIT EM GEN EMERGENCY GENERATOR DOUBLE DUPLEX RECEPTACLE FIRE ALARM SPEAKER - CEILING MTD POWER DISTRIBUTION UNIT DUPLEX SPLIT WIRED WITH BOTTOM OUTLET ON WALL SWITCH FIRE ALARM SPEAKER - WALL MTD CABLE TRAY UNINTERRUPTABLE POWER SOURCE COMBINATION SPEAKER/FLASHING LIGHT SAFETY TYPE DUPLEX RECEPTACLE INDICATES CONNECTION TO EXISTING TVSS TRANSIENT VOLTAGE SURGE SUPPRESSOR IONIZATION TYPE SMOKE DETECTOR ISOLATED GROUND TYPE DUPLEX RECEPTACLE PLUGMOLD - SEE PLAN FOR LENGTH AUTOMATIC TEMPERATURE CONTROL ISOLATED GROUND TYPE WITH SURGE SUPRESSION PHOTOELECTRIC TYPE SMOKE DETECTOR DUPLEX FOR ELECTRIC WATER COOLER COORDINATE LOCATION WITH SUPPLIER THERMAL TYPE DETECTOR GROUNDING AND LIGHTNING PROTECTION SOUND SYSTEM IONIZATION TYPE MTD TO DUCT GFI DUPLEX RECEPTACLE GROUND CONDUCTOR RUN CONCEALED IONIZATION TYPE MTD IN PLENUM SPEAKER - CEILING MTD FLUSH RECEPTACLE WITH WEATHERPROOF COVER GROUND CONDUCTOR RUN UNDER FLOOR THERMAL TYPE MTD TO DUCT SPEAKER - CEILING MTD SURFACE EXPLOSION-PROOF RECEPTACLE THERMITE WELD TO BLDG OR EQUIP REMOTE TEST SWITCH FLUSH-FLOOR MTD RECEPTACLE THERMITE WELD OF GROUND CONDUCTORS PHOTOELECTRIC TYPE W/ RELAY PEDESTAL-FLOOR MTD RECEPTACLE BONDING PLATE OR CLAMP CONNECTION AUTOMATIC DOOR PEDESTAL-COUNTER MTD RECEPTACLE CONNECTION TO AIR TERMINAL FOR TAMPER SWITCH LIGHTNING PROTECTION **⇔** α∟ CEILING MTD RECEPTACLE MOTION DETECTOR H-HEAD MTD C-CEILING MTD THERMITE WELD TO GROUND ROD PRESSURE SWITCH FOR DRY TYPE SYSTEM **CLOCK RECEPTACLE** PUSH PLATE GROUND ROD TRIODE REMOTE TROUBLE BELL SPECIAL PURPOSE RECEPTACLE — SIZE & TYPE AS INDICATED OR SCHEDULED KEY SWITCH ELECTROMAGNETIC SHUTTER HOLDER LIGHTING POWER RESET DROP CORD ELECTROMAGNETIC DOOR HOLDER DOOR MOUNTED SAFETY INTERLOCK POWER FEED AT MOVABLE PARTITION FIRE ALARM SYSTEM ACTIVATED DOOR CLOSER RED SIGNAL LIGHT ELECTRIC STRIKE INDICATES OUTLET TO BE MOUNTED 8" ABOVE COUNTER HEIGHT. TYPICAL UNLESS NOTED OTHERWISE 2X4 FIXTURE FIREMANS TELEPHONE JACK PUSH BUTTON 2X2 FIXTURE CONTROL ZAM **QCCUPANCY SENSOR** 1X4 FIXTURE MONITOR ZAM QCCUPANCY SENSOR-CEILING MOUNTED OR DOOR OPENING SECURITY SYSTEM FLUORESCENT STRIPLIGHT FIRE ALARM CONTROL PANEL PENDANT TUBE FIXTURE FIRE ALARM COMMAND CENTER CARD ACCESS STATION TELEVISION / VIDEO SYSTEM RECESSED DOWNLIGHT FIRE ALARM ANNUNCIATOR DOOR ALARM SWITCH W/ ELEC HINGE TELEVISION OUTLET WALL WASHER FTR FIRE ALARM PUNCH TAPE RECORDER SECURITY CHIME TELEVISION OUTLET W/ RECEPTACLE WALL MTD FIXTURE FDGP FIRE ALARM DATA GATHERING PANEL KEY BY-PASS SW. FOR DOOR POSITION SW. TV CAMERA OUTLET W/ RECEPTACLE POLE MTD FIXTURE FSCP FIRE SUPPRESSION CONTROL PANEL SECURITY SYSTEM MOTION DETECTOR CEILING MTD EXIT SIGN W/ ARROWS AS INDICATED FIRE, SMOKE OR FIRE/SMOKE DAMPER SECURITY TV CAMERA WALL MTD EXIT SIGN W/ ARROWS AS INDICATED SECURITY SYSTEM CONSOLE LIGHTING TRACK — LENGTH OF TRACK AND NO. OF FIXTURES AS INDICATED ON PLAN. EML ELECTROMAGNETIC LOCK INDICATES NIGHT LIGHT REMOTE RELEASE EMERGENCY BATTERY PACK W/ NUMBER OF HEADS AS INDICATED. ELECTRIC HINGE 0'-0" ELECTRIC STRIKE EMERGENCY LIGHTING REMOTE HEADS

EMERGENCY BATTERY PACK

KEY SWITCH

ELECTRICAL **ABBREVIATIONS**

CONVENIENC	E ABBREVIATIONS IS PROVIDED FOR CE ONLY, ITEMS LISTED HERE MAY OR E USED ON THIS PROJECT.		
1/C A/C ABV AC AFF AFG AHU ATS ALT ARCH AUTO AVG	SINGLE CONDUCTOR AIR CONDITIONER AMPS ABOVE ALTERNATING CURRENT ABOVE FINISHED FLOOR ABOVE FINISHED FLOOR ABOVE FINISHED GRADE AIR HANDLING UNIT AUTOMATIC TRANSFER SWITCH ALTERNATE ARCHITECTURAL AUTOMATIC AVERAGE	INCL INST INSUL JB JC JT KVA KW LTG LV LVR	INCLUDE INSTANTANEOUS INSULATION JUNCTION BOX JANITOR'S CLOSET JOINT KILOVOLT AMPERE KILOWATT LIGHTING LOW VOLTAGE LOUVER
BKR BLDG BLW BTM C CT CAP CFM CIRC CKT	BREAKER BUILDING BELOW BOTTOM CONDUIT CURRENT TRANSFORMER CAPACITY CUBIC FEET/MINUTE CIRCULATING CIRCUIT	MAX MC MCB MCC MECH MFR MH MIN MISC MLO MTD MTG	MAXIMUM MECHANICAL CONTRACTOR MAIN CIRCUIT BREAKER MOTOR CONTROL CENTER MECHANICAL MANUFACTURER MANHOLE MINIMUM MISCELLANEOUS MAIN LUGS ONLY MOUNTED MOUNTING
CLG CONC CONN CONST CONT CONTR CPU CU	CEILING CONCRETE CONNECTION CONSTRUCTION CONTINUOUS CONTRACTOR CENTRAL PROCESSING UNIT COPPER	NIC NO NTS OC OH OPNG	NOT IN CONTRACT NUMBER NOT TO SCALE ON CENTER OVERHEAD OPENING
DED DET DIAM DIM DISC DIV DN DPR DWG	DEDICATED DETAIL DIAMETER DIMENSION DISCONNECT DIVISION DOWN DAMPER DRAWING	PC PEND PLBG PNL PRESS SW PS PT	PLUMBING CONTRACTOR PENDANT PLUMBING PANEL PRESSURE SWITCH PULL SWITCH POTENTIAL TRANSFORMER
EA EC ELEC ELEV EM	EACH ELECTRICAL CONTRACTOR ELECTRICAL ELECTRICAL ELECTRICAL ELECTRICAL EMERGENCY ONLY	REC REC'S RECEPT REQD RM	RECESSED RECEPTACLES RECEPTACLE REQUIRED ROOM
EM GEN ENCL EQUIP EWC EXH EXIST EXT	EMERGENCY GENERATOR ENCLOSURE EQUIOMENT ELECTRIC WATER COOLER EXHAUST EXISTING EXTERIOR FURNISHED & INSTALLED	SECT SIM SQ FT STD STL STOR STRUCT SURF SUSP CLG SW	SECTION SIMILAR SQUARE FEET STANDARD STEEL STORAGE STRUCTURAL SURFACE SUSPENDED CEILING SWITCH
FACP FBO FP FPC FIN FIXT FLR FLUOR FU	FIRE ALARM CONTROL PANEL FURNISHED BY OTHERS FIRE PROTECTION FIRE PROTECTION CONTRACTOR FINISH FIXTURE FLOOR FLUORESCENT FUSE	TELE TEMP TERM T-STAT TV TYP UG	TELEPHONE TEMPERATURE TERMINAL THERMOSTAT TELEVISON TYPICAL
GA GC GFI GRD	GAUGE GENERAL CONTRACTOR GROUND FAULT INTERRUPTER GROUND	UH UV VDT VERT	UNDERGROUND UNIT HEATER UNIT VENTILATOR VISUAL DISPLAY TERMINAL VERTICAL
Horiz HP HT HTG HV HWH	HORIZONTAL HORSEPOWER HEIGHT HEATING HIGH VOLTAGE HOT WATER	W/ WP WT	VOLUME WITH WEATHERPROOF WEIGHT
HZ	HERTZ	XFMR	TRANSFORMER

MOUNTING HEIGHTS ELEVATION

BATTERY LIGHTING UNITS & REMOTE WALL MOUNTED LIGHT HEADS (OR 1'-0" BELOW FINISHED CEILING TO TOP OF UNIT) PENDANT HUNG & INDUSTRIAL STRIP FIXTURES CENTERED ABY. WINDOW — WARNING & SIGNALING FIXTURES. OR 6" BELOW FINISHED CEILING, WHICHEVER IS LOWER, FIRE ALARM SIGNAL DEVICES & ILLUMINATED FIRE SIGNALS. TOP OF FLUSH & SURFACE MOUNTED ELECTRICAL LIGHTING OR POWER PANELBOARDS & TELEPHONE CABINETS. TOP OF BACK-MOUNTED WALL EXIT FIXTURES. (NOT MOUNTED ABV. DOORS) TOP OF HIGHEST ELECTRICAL SAFETY DISCONNECT SWITCHES, MAGNETIC STARTERS, & CONTACTORS. WALL MOUNTED INTERCOM, NURSE CALL STATIONS, CLOCK CONTROL PANEL, WALL MOUNTED TELEPHONE & PAY STATIONS. (3'-6" AT HANDICAP LOCATIONS-VERIFY EXACT HEIGHT PRIOR TO ROUGH-IN) 4'-0" WALL MOUNTED WIREMOLD, LIGHTING SWITCHES, MANUAL MOTOR STARTERS, THERMOSTATS, FIRE ALARM PULL STATIONS & G.F.I. RECEPTACLES IN TOILET ROOMS OR FOR SEPARATE SINKS 3'-6" — MANUAL FIRE ALARMS ELECTRICAL RECEPTACLES WITHIN MECHANICAL SPACES, ELECTRICAL & ELEVATOR ROOMS. ELECTRICAL RECEPTACLES, TELEPHONE OUTLETS COMPUTER OUTLETS, INTERCOM OUTLETS FOR DESKS FINISHED FLOOR

> MOUNTING HEIGHT NOTES: MOUNTING HEIGHTS TO CENTER OF OUTLETS UNLESS OTHERWISE NOTED. IN MASONRY CONSTRUCTION, HEIGHTS SHALL BE USED FOR REFERENCE TO NEAREST BLOCK OR BRICK COURSING. THE ABOVE MOUNTING HEIGHTS SHALL BE ADHERED TO UNLESS SPECIFICALLY NOTED OR DETAILED OTHERWISE ON THE DRAWINGS OR SPECIFICATIONS. A + BESIDE A DEVICE INDICATES THAT A DEVICE IS MOUNTED ABOVE A COUNTER OR CASEWORK. COORDINATE WITH ARCHITECTURAL DWGS. & CASEWORK CONTRACTOR.

> > BHG Consulting, Inc. 1812 South 22nd Street Philadelphia, PA 19145 Phone: 215.755.9318 Fax: 215.755.9319


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STEVEN M. BACH, PE, RA, PP, CME NJ PROFESSIONAL ENGINEER No. 24GE0415070 NJ PROFESSIONAL PLANNER No. 33LI0055570 NJ REGISTERED ARCHITECT No. 21AI01487200

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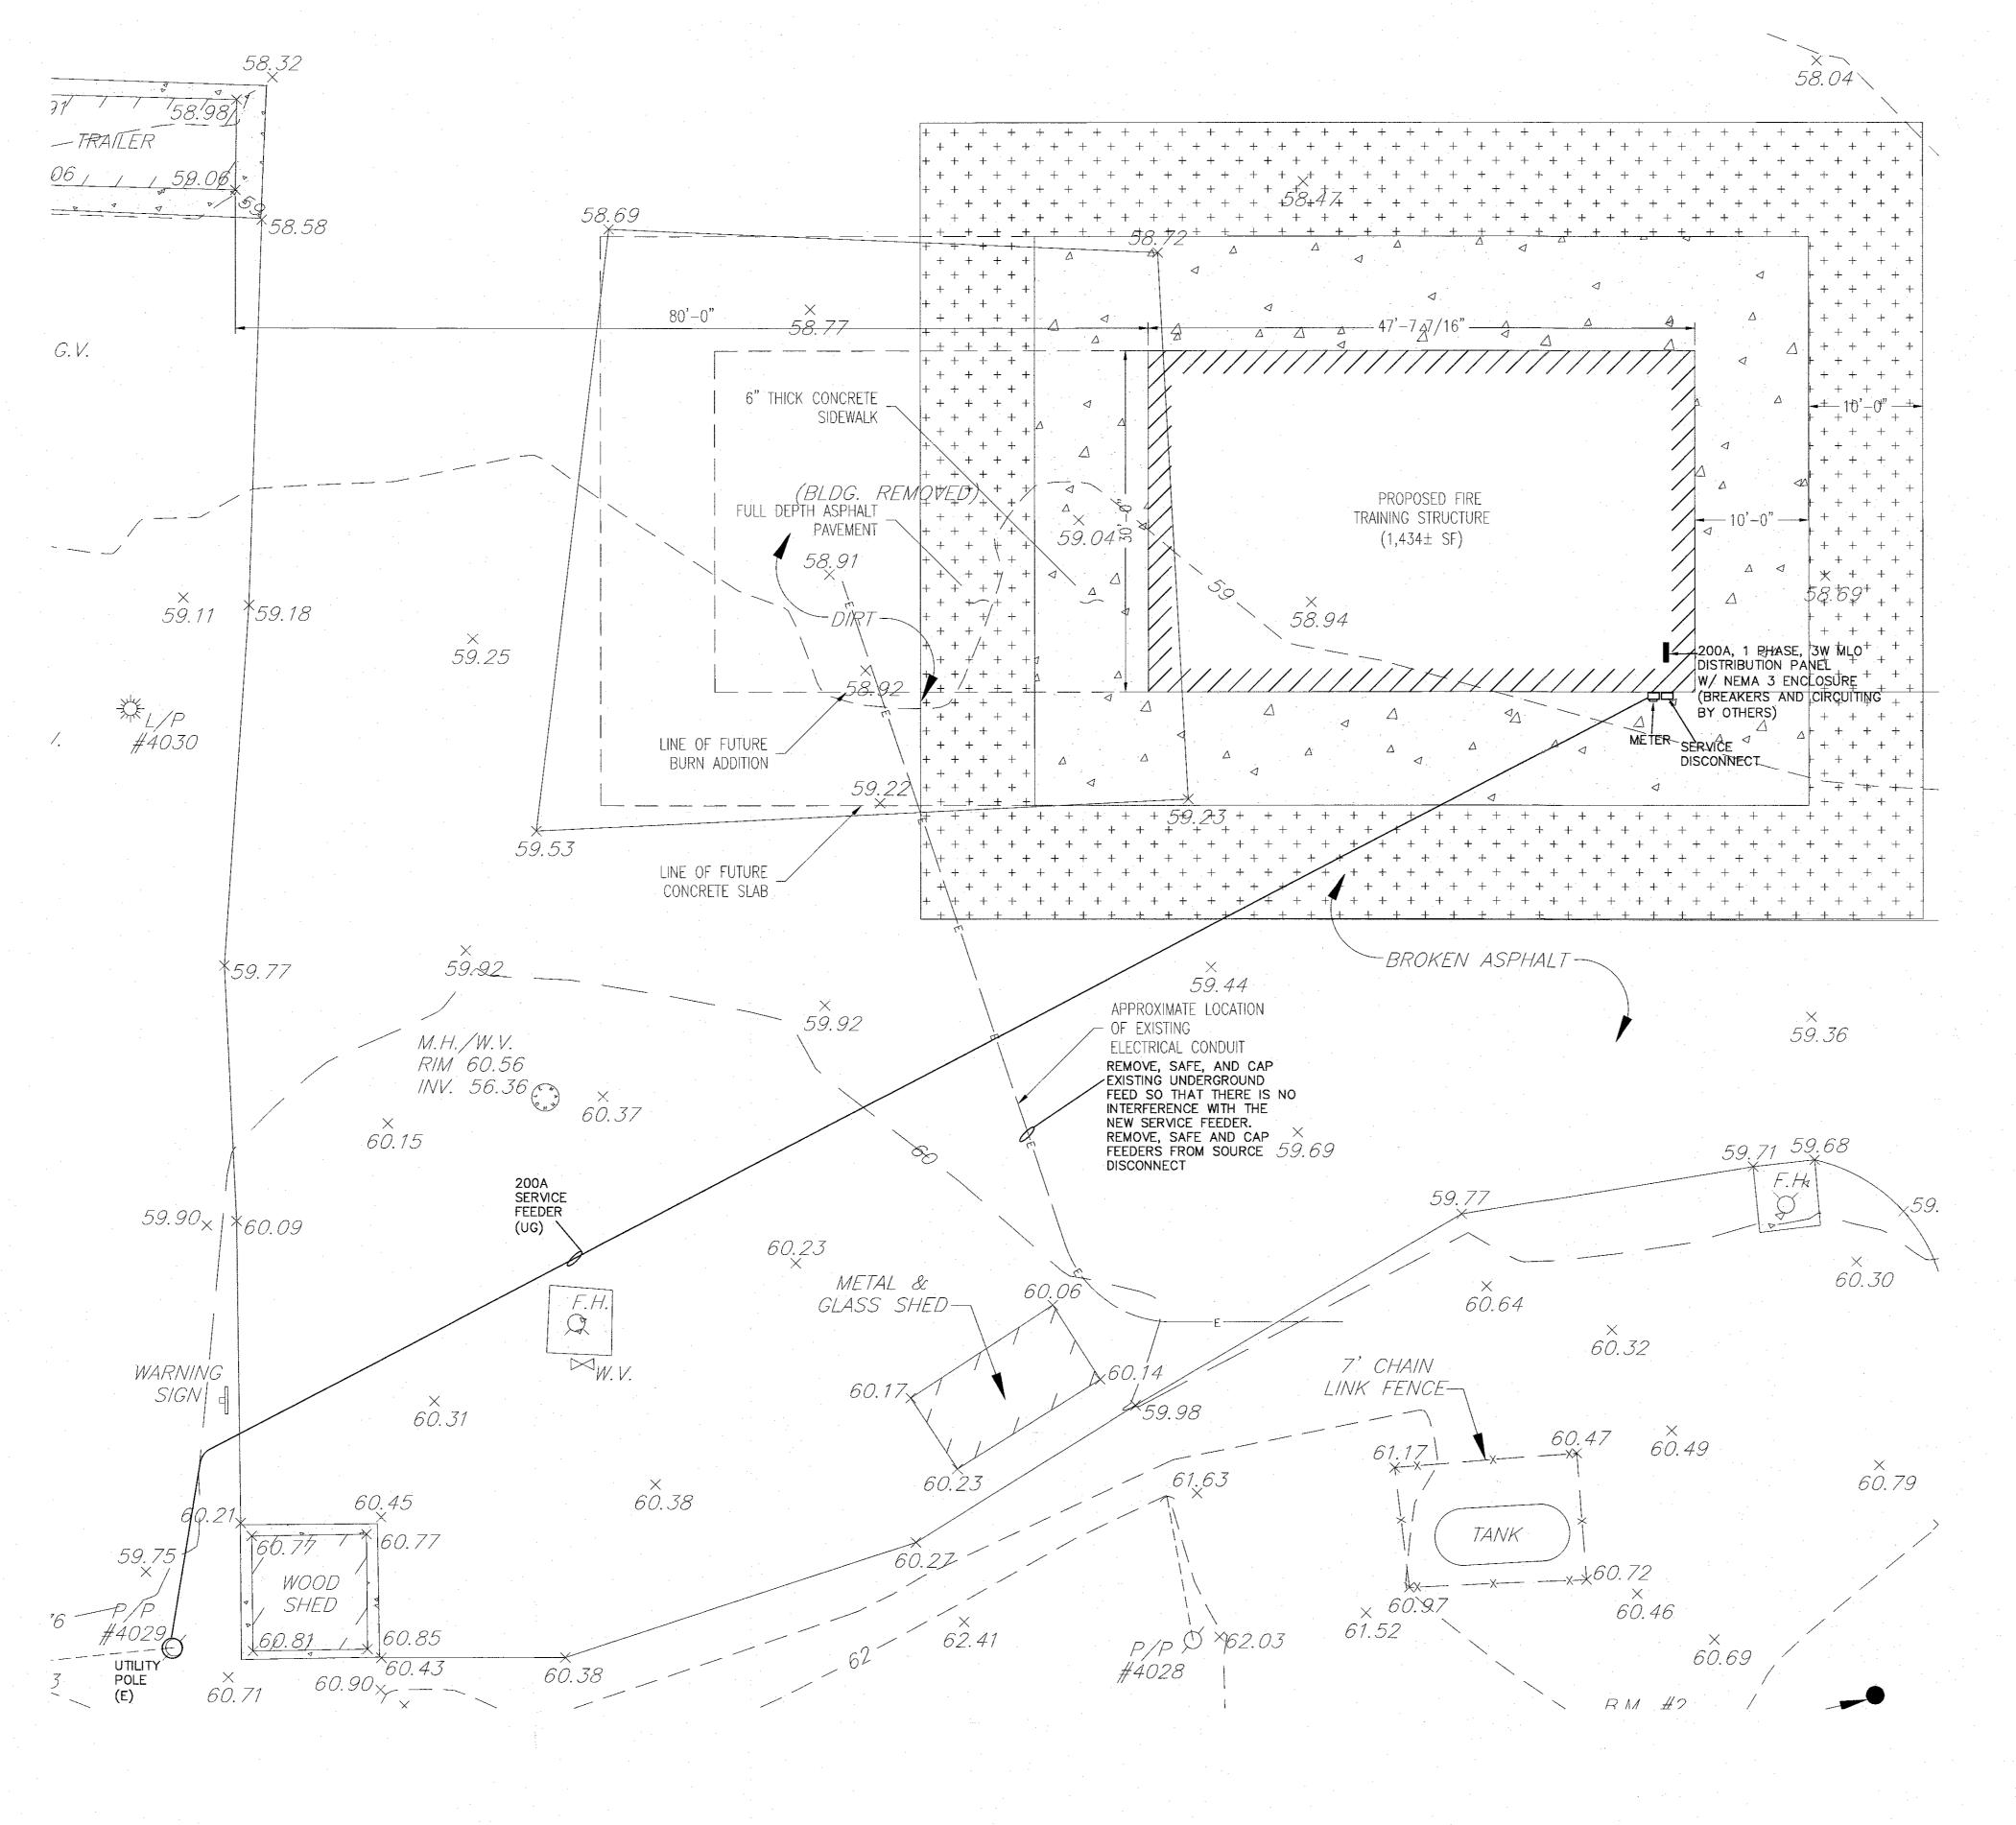
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OWNERS BACH AS HARMLESS	SOLE RISK AND WITHOUT LIABILITY OR LEGAL E SOCIATES, PC; AND OWNER SHALL INDEMNIFY S BACH ASSOCIATES, PC FROM ALL CLAIMS, DAMA PENSES ARISING OUT OF OR RESULTING T	KPOSURE T ' AND HOL GES, LOSSE
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ELECTRICAL POWER PLAN

E-1.0 SCALE: 1/4" = 1'-0"

GENERAL REQUIREMENTS FOR ELECTRICAL WORK

1. CONTRACTOR SHALL PROVIDE LABOR, MATERIAL, EQUIPMENT AND SERVICES FOR THE PROPER INSTALLATION AND OPERATION OF THE ELECTRICAL WORK AS INDICATED ON THE DRAWINGS AND AS SPECIFIED.

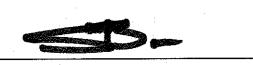2. LABOR, MATERIAL, EQUIPMENT AND SERVICE OBVIOUSLY NECESSARY FOR THE PROPER INSTALLATION AND OPERATION OF ELECTRICAL SYSTEMS, ALTHOUGH NOT SPECIFICALLY MENTIONED OR SHOWN, SHALL

3. ELECTRICAL WORK SHALL CONFORM TO THE LATEST EDITIONS OF THE NATIONAL ELECTRIC CODE AND APPLICABLE LAWS, CODES AND REGULATIONS OF MUNICIPAL, COUNTY, STATE, FEDERAL AUTHORITIES, UTILITY COMPANIES, INSURANCE AGENCIES AND OTHER AUTHORITIES HAVING JURISDICTION OVER THE WORK. IN CASE OF CONFLICT BETWEEN THE DRAWINGS AND SPECIFICATIONS AND THE CODES, THE HIGHEST STANDARD SHALL APPLY. ELECTRICAL CONTRACTOR SHALL SATISFY CODE REQUIREMENTS AS A MINIMUM STANDARD WITHOUT ANY EXTRA COST TO OWNER OR THE LICENSEE.

CONTRACTOR AND ALL EMPLOYEES SHALL FAMILIARIZE THEMSELVES WITH OWNERS, STATE, LOCAL AND FEDERAL CONSTRUCTION SAFETY GUIDELINES PRIOR TO THE COMMENCEMENT OF WORK.

4. OBTAIN, PAY FOR AND DELIVER PERMITS AND CERTIFICATES OF INSPECTION AS REQUIRED BY THE AUTHORITIES HAVING JURISDICTION. DELIVER CERTIFICATES TO THE OWNER PRIOR TO FINAL ACCEPTANCE OF THE WORK. AN ELECTRICAL INSPECTION CERTIFICATE, FOR EACH CLASS OF WORK REQUIRING INSPECTION, MUST BE SUBMITTED PRIOR TO OR WITH THE FINAL PAYMENT INVOICE. CONTRACTOR MUST MAKE APPLICATION FOR THE INSPECTION, COORDINATE SAME, AND PAY THE REQUIRED INSPECTION FEE.

5. BEFORE SUBMITTING HIS BID, TRADE CONTRACTOR SHALL VERIFY EXISTING CONDITIONS IN THE FIELD. FAILURE TO DO SO SHALL NOT RELIEVE TRADE CONTRACTOR OF HIS OBLIGATION TO PAY FOR COSTS THAT MAY BE INCURRED DUE TO CONDITIONS THAT MAY AFFECT THE COST OF INSTALLING HIS WORK. THE ELECTRICAL CONTRACTOR SHALL THOROUGHLY EXAMINE ALL AREAS WHERE EQUIPMENT, CONDUIT, AND WIRING WILL BE INSTALLED AND WILL REPORT ANY CONDITION THAT, IN HIS OPINION, PREVENTS THE PROPER INSTALLATION OF THE ELECTRICAL WORK.

6. DRAWINGS ARE DIAGRAMMATIC, SMALL SCALE AND INDICATE THE GENERAL ARRANGEMENT OF SYSTEMS AND WORK INCLUDED. HOWEVER, CERTAIN RACEWAYS, BENDS, FITTINGS, BOXES, SYSTEM COMPONENTS, APPURTENANCES AND RELATED SPECIALTIES ARE NOT SHOWN, BUT SHALL BE PROVIDED TO INSURE A COMPLETE INSTALLATION.

7. CONSULT THE DRAWINGS FOR EXACT LOCATION OF FIXTURES AND EQUIPMENT. WHERE SAME ARE NOT DEFINITELY LOCATED, OBTAIN THIS INFORMATION FROM THE ARCHITECT/ENGINEER.

8. INCIDENTAL ACCESSORIES NECESSARY TO MAKE THE WORK COMPLETE AND READY FOR OPERATION, EVEN IF NOT PARTICULARLY SPECIFIED OR SHOWN, SHALL BE PROVIDED WITHOUT ADDITIONAL EXPENSE. MINOR DETAILS NOT USUALLY SHOWN OR SPECIFIED, BUT MANIFESTLY NECESSARY FOR THE PROPER INSTALLATION AND OPERATION OF THE VARIOUS SYSTEMS, SHALL BE INCLUDED IN THE WORK, THE SAME AS IF SPECIFIED OR SHOWN ON THE DRAWINGS. NO SUCH DEPARTURES SHALL BE MADE

9. NO CONSIDERATION OR ALLOWANCE SHALL BE GRANTED FOR ALLEGED MISUNDERSTANDING OF MATERIALS AND EQUIPMENT TO BE FURNISHED FOR WORK TO BE ACCOMPLISHED.

WITHOUT PRIOR WRITTEN REVIEW.

10. THE ELECTRICAL CONTRACTOR SHALL UNCONDITIONALLY WARRANT ALL WORK TO BE FREE OF DEFECTS IN MATERIAL AND WORKMANSHIP FOR A PERIOD OF ONE (1) YEAR FROM THE DATE OF FINAL ACCEPTANCE BY OWNER WILL REPAIR OR REPLACE ANY DEFECTIVE WORK PROMPTLY AND WITHOUT CHARGE AND RESTORE ANY OTHER EXISTING WORK DAMAGED IN THE COURSE OF REPAIRING DEFECTIVE MATERIALS AND WORKMANSHIP.

11. MATERIAL AND EQUIPMENT IN THE WORK SHALL BE NEW, FIRST GRADE, FIRST CLASS, THE BEST OF THEIR RESPECTIVE KINDS, APPROPRIATE FOR THE APPLICATION AND ENVIRONMENT. EQUIPMENT AND MATERIALS SHALL CONFORM WITH APPROPRIATE PROVISIONS OF CSA, ULC, NEC, ASTM, UL, ETL, NEMA, ANSI, AS APPLICABLE TO EACH INDIVIDUAL UNIT OR ASSEMBLY.

12. EQUIPMENT OR APPARATUS FOR ANY ONE SYSTEM SHALL BE THE PRODUCT OF ONE MANUFACTURER. THE TERM "MANUFACTURER" SHALL BE UNDERSTOOD AS APPLYING TO A COMPANY OF ESTABLISHED REPUTATION IN THE MANUFACTURE OF A PARTICULAR PIECE OF EQUIPMENT OR APPARATUS FROM PRODUCTS OF HIS OWN MAKE OR OTHERS, AND WHO ASSUMES FULL RESPONSIBILITY FOR PRODUCTS USED IN SUCH EQUIPMENT OR APPARATUS. THE MANUFACTURER MUST SUBMIT EVIDENCE OF FIVE (5) YEARS OR MORE MANUFACTURING EXPERIENCE IN THE PRODUCTION OF THESE PRODUCTS.

13. MATERIAL OR EQUIPMENT SPECIFIED BY MANUFACTURER, BRAND NAME, TYPE, OR CATALOG NUMBER ARE DESIGNED TO ESTABLISH STANDARDS OF DESIRED QUALITY, STYLE, PERFORMANCE, ELECTRICAL, MECHANICAL AND PHYSICAL CHARACTERISTICS, AND DIMENSIONS.

14. WHERE CABLE PASSES THROUGH FIRE RATED STRUCTURES PROVIDE FIREPROOF FITTINGS.15. RACEWAYS SHALL BE CONCEALED IN THE CONSTRUCTION EXCEPT AS OTHERWISE SPECIFIED OR

16. WHERE CONDUIT TERMINATES IN A CABINET, BOX OR AUXILIARY GUTTER, THE CONDUCTORS SHALL BE PROVIDED BY AN INSULATING BUSHING. LOCKNUTS SHALL BE PROVIDED BOTH INSIDE AND OUTSIDE THE ENCLOSURE.

17. A PULL WIRE SHALL BE INSTALLED IN EMPTY RACEWAYS. PULL WIRE SHALL BE 200 POUND TEST NYLON. BOTH ENDS SHALL BE IDENTIFIED BY MEANS OF LABELS OR TAGS, READING "PULL WIRE" AND GIVING THE ORIGINATION AND TERMINATION POINTS.

18. GENERALLY, WIRING (OTHER THAN EMERGENCY) SHALL BE DONE WITH INSULATED COPPER CONDUCTORS IN CONTINUOUSLY GROUNDED METAL CONDUIT (EMT). CONDUCTORS AND RACEWAYS SHALL BE FIRST GRADE, INSTALLED CONCEALED IN THE CONSTRUCTION EXCEPT IN MECHANICAL OR ELECTRICAL SPACES, OPEN CONSTRUCTION AREAS OR WHERE SHOWN ON THE DRAWINGS.

EMERGENCY WIRING SHALL BE DONE WITH INSULATED COPPER CONDUCTORS IN CONTINUOUSLY GROUNDED METAL CONDUIT (EMT), SEPARATE FROM ALL OTHER WIRING AND RACEWAYS. CONDUCTORS AND RACEWAYS SHALL BE FIRST GRADE, INSTALLED CONCEALED IN THE CONSTRUCTION EXCEPT IN MECHANICAL OR ELECTRICAL SPACES, OPEN CONSTRUCTION AREAS OR WHERE SHOWN ON THE

19. MC CABLING MAY BE USED FOR CONCEALED BRANCH CIRCUIT WIRING ABOVE SUSPENDED CEILING AND INSIDE INTERIOR HOLLOW WALLS AND PARTITIONS. ALL HOME RUNS SHALL BE INSTALLED IN METAL CONDUIT (EMT) FROM CIRCUIT BREAKER PANELS TO EACH AREA.

20. RACEWAYS SHALL BE SUPPORTED TO COMPLY WITH NEC.

21. WHERE TELE/DATA OUTLETS ARE SHOWN, PROVIDE A SINGLE GANG BOX WITH BLANK PLATE AND

22. NO "THROUGH-WALL" BOXES SHALL BE PERMITTED. WHERE DRAWINGS INDICATE BOXES BACK-TO-BACK, OR SIMILAR LOCATIONS, SUCH BOXES SHALL BE INSTALLED SEPARATELY, SPACED MINIMUM SIX INCHES APART HORIZONTALLY.

CONDUIT (1" DIA. MINIMUM) WITH PULL STRING UP TO CEILING SPACE ABOVE.

23. FOR CONDUITS OR CABLES THAT PENETRATE FIRE RATED WALLS, FLOORS, PARTITIONS, OR SLABS, FILL AND SEAL SPACES BETWEEN THE CONDUITS OR CABLES AND THE SLEEVE WITH 2-PART INTUMESCENT FOAM SEALANT CREATING A FIRE STOP EQUAL TO OR EXCEEDING FIRE RATING OF CONSTRUCTION MATERIAL BEING PENETRATED. FIRE SEALANT SHALL PREVENT SPREAD OF FLAME, SMOKE, AIR AND WATER THROUGH THE SLEEVE AND SHALL PASS 3 HOUR TEST PER ASTMA E814 AND UL 1479. FIRE SEALANT SHALL BE INSTALLED IN ACCORDANCE WITH MANUFACTURER'S WRITTEN

24. ALL CONDUITS AND FLEXIBLE METAL CONDUIT SHALL CONTAIN A GROUNDING CONDUCTOR. CONDUITS ARE NOT TO BE USED AS A GROUNDING CONDUCTOR.

25. ALL BRANCH CIRCUIT WIRING SUPPLYING NEW RECEPTACLES AND LIGHTING BEING INSTALLED SHALL BE #12 COPPER CONDUCTORS MINIMUM.

26. ALL NEW DEVICES AND RACEWAYS SHALL BE SPECIFICATION GRADE. NEW RECEPTACLE, SWITCH AND OTHER DEVICES AND COVER PLATES COLORS SHALL BE DETERMINED BY ARCHITECT. EMERGENCY RECEPTACLES SHALL BE RED WITH RED COVER PLATE, PERMANENTLY LABELED WITH PANEL BOARD AND BRANCH CIRCUIT NUMBER SUPPLYING RECEPTACLE.

27. IF REQUIRED, CONTRACTOR SHALL SUPPLY AND INSTALL ADDITIONAL BRANCH CIRCUITS (BREAKERS, RACEWAYS, WIRING, ETC..) AS REQUIRED TO COMPLETE THE PROJECT. CIRCUITS SHALL BE FED FROM

28. ALL ELECTRICAL EQUIPMENT SHALL BE LABELED TO COMPLY WITH OSHA AND ANSI/ASME A13.1—2007 STANDARDS FOR THE IDENTIFICATION OF SYSTEMS. THE MARKINGS MUST IDENTIFY THE EQUIPMENT, IT'S ORIGIN AND VOLTAGE OF THE CONTENTS. ALL EQUIPMENT SHALL BE IDENTIFIED USING PHENOLIC NAMEPLATES AND LABELED IN ACCORDANCE WITH THE NOMENCLATURE USED ON THE DRAWINGS AND MUST BE COMPATIBLE WITH THE MIMS SYSTEM.

29. ALL SYSTEMS WIRING INCLUDING LOW VOLTAGE CONTROLS, FIRE ALARM, NURSE CALL, CCTV AND TELE/DATA SHALL BE INSTALLED IN CONDUIT AND/OR CABLE TRAY/DUCT SYSTEM AND SHALL BE SUPPORTED TO COMPLY WITH THE N.E.C.

30. CONTRACTOR SHALL PROVIDE AND AFFIX ARC FLASH WARNING LABELS (PER N.E.C. 110.16) AND AVAILABLE FAULT CURRENT LABELS (PER N.E.C. 110.24) TO ALL PANEL BOARDS.

31. CONTRACTOR SHALL PROVIDE TO OWNER A DETAILED AS-BUILT DRAWING OF THE WORK PERFORMED. THIS PLAN SHALL INDICATE THE BRANCH CIRCUITS SUPPLYING EACH LIGHT AND DEVICE ASSOCIATED WITH THE WORK PERFORMED ON THIS PROJECT.

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TEVEN M. BACH, PE, RA, PP, CME

NJ PROFESSIONAL ENGINEER No. 24GE04150700 NJ PROFESSIONAL PLANNER No. 33LI00555700 NJ REGISTERED ARCHITECT No. 21AI01487200

ALL DIMENSIONS MUST BE VERIFIED BY CONTRACTOR AND OWNER MUST BE NOTIFIED OF ANY DISCREPANCIES BEFORE PROCEEDING WITH THE WORK.

PROJECT:

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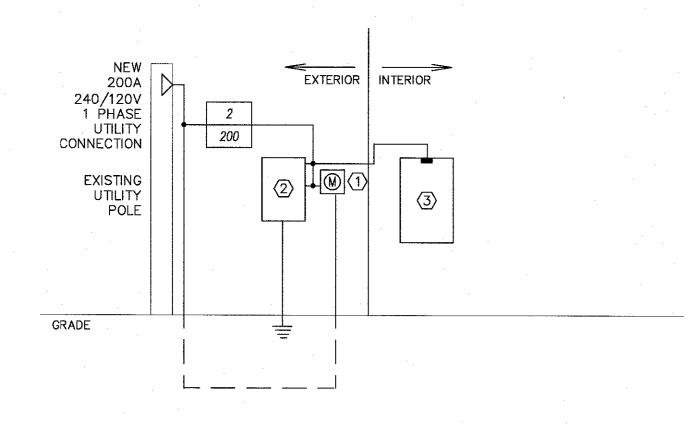
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REVISIONS				
NO.	DESCRIPTION	DATE		

ELECTRICAL LOCATION PLAN

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JOB NO:	DESIGNED BY:
CCC2023-01	DM3
DATE:	DRAWN BY:
MAY 30, 2024	DM3
SCALE:	CHECKED BY:
AS NOTED	SMB
DRAWING NUMBER:	

E-1.0



SINGLE LINE DIAGRAM
NO SCALE

SINGLE LINE DIAGRAM NOTES:

2 200A MAIN DISCONNECT


(3) 200A MAIN PANEL (BY OTHERS)

GENERAL ELECTRICAL NOTES:

- 1. ALL ELECTRICAL MATERIALS AND EQUIPMENT FOR THIS PROJECT SHALL BE NEW AND APPROVED BY UNDERWRITERS LABORATORY (U.L.) OR ANY OTHER NATIONALLY RECOGNIZED TESTING AGENCY.
- 2. UPON COMPLETION OF THE WORK, THE ENTIRE WIRING SYSTEM SHALL BE FREE FROM GROUNDS, SHORT CIRCUITS, OPENS, OVERLOADS, AND IMPROPER VOLTAGE.
- 3. LIGHTING AND POWER BRANCH CIRCUIT PANEL BOARDS SHALL BE BOLT—ON CIRCUIT BREAKER TYPE EQUIPPED WITH QUICK—MAKE, QUICK—BREAK, TRIP INDICATING, MOLDED CASE, THERMAL MAGNETIC CIRCUIT BREAKERS.
- 4. TWO OR THREE POLE CIRCUIT BREAKERS SHALL BE COMMON TRIP TYPE. SINGLE POLE BREAKER WITH YOKED HANDLE WILL NOT BE PERMITTED.
- 5. ALL LIGHTING AND POWER PANELS SHALL HAVE THEIR TOP AT 6'-6" ABOVE FINISHED FLOOR.
- 6. PANEL BOARDS SHALL BE SUITABLE FOR FLUSH MOUNTING OR SURFACE MOUNTED INSTALLATION AS REQUIRED.
- 7. PANEL BOARDS SHALL BE DEAD-FRONT, SAFETY-TYPE AND SHALL CONTAIN MAIN CIRCUIT BREAKERS, MAIN LUGS RATINGS, BRANCH CIRCUIT BREAKERS, SPACE AND BUSSES AS INDICATED ON DRAWINGS.
- 8. THE FOLLOWING CONVENTION SHALL BE USED:

FEEDER TYPE
200 FEEDER SIZE

9. WHERE SHORT CIRCUIT RATINGS ARE NOT INDICATED, PROVIDE 65 KAIC MINIMUM. AS ACTUAL FEEDER ROUTING MAY VARY, THE SHORT CIRCUIT RATING OF ANY LOAD CENTER MAY BE REDUCED TO 10 KAIC IF THE FEEDER LENGTH FROM THE UTILITY TRANSFORMER TO THE LOAD CENTER EXCEEDS 70 FEET.

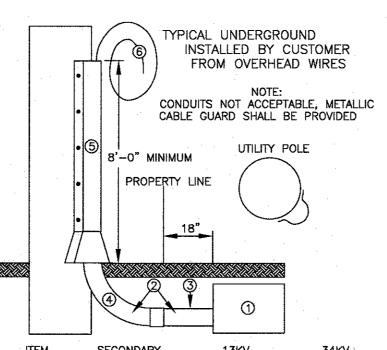

ITEM SECONDARY 13KV 34KV

① SPLICE BOX CONSULT UTILITY CO. CONSULT UTILITY CO.

② CONDUIT

CONSULT UTILITY CO. 2" MINUMUM

3" MINUMUM

30" MINIMUM

30" MINIMUM

4" RADIUS

24" MINIMUM

30" MINIMUM

30" MINIMUM

30" MINIMUM

30" MINIMUM

30" MINIMUM

30" MINIMUM

6" PROTECTION

METALLIC GUARD

METALLIC GUARD

METALLIC GUARD


METALLIC GUARD

CABLE ON POLE

CABLE SHALL BE SECURELY FASTENED TO POLE AND OF SUFFICIENT LENGTH TO PERMIT THE CONNECTION TO UTILITY COMPANY CONDUCTORS. THE UTILITY COMPANY WILL CONNECT THE CABLE ON THE POLE TO THE UTILITY COMPANY CONDUCTORS AND ASSUME OWNERSHIP OF FACILITIES ON ITS SIDE OF THE SERVICE POINT.

UTILITY POLE DETAIL

NO SCALE

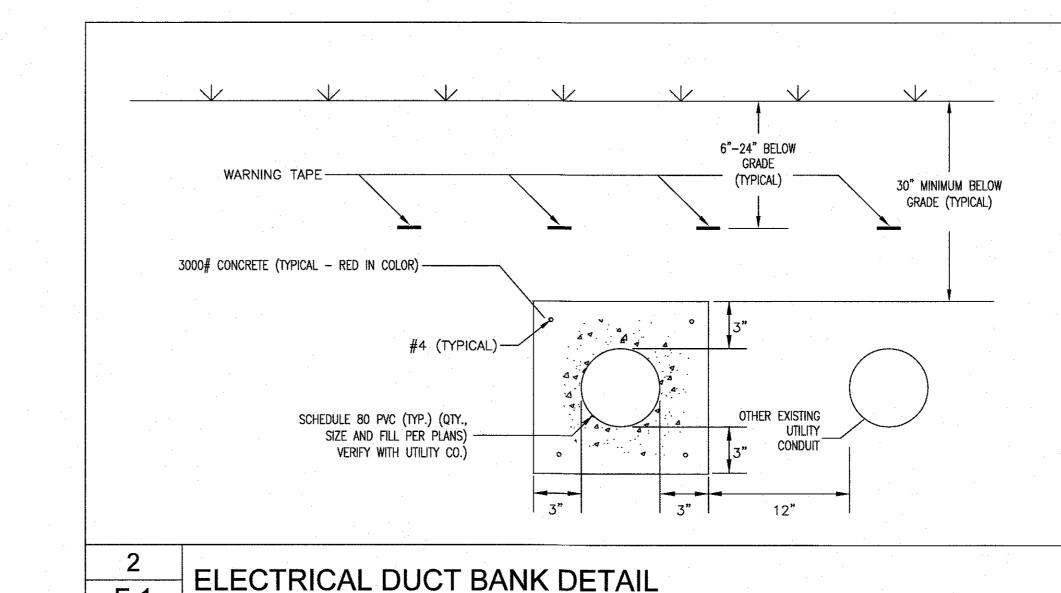

DETAIL NOTES:

1. DETECTABLE UNDERGROUND TAPE: BURY AS SHOWN BELOW GRADE. USE SETON STYLE 85517 (6" RED TAPE WITH BLACK LETTERS — "CAUTION: BURIED ELECTRICAL LINE BELOW"

2. DETECTABLE UNDERGROUND TAPE. BURY AS SHOWN BELOW GRADE. USE SETON (6" YELLOW TAPE WITH BLACK LETTERS — "CAUTION: BURIED UTILITY LINE BELOW"


3. MAINTAIN 12" MINIMUM OUTSIDE TO OUTSIDE DIAMETER SEPARATION BETWEEN ELECTRICAL AND OTHER EXISTING UTILITY CONDUITS.

4. BACKFILL WITH 1-13 SELECT BACKFILL. COMPACT IN 6" LIFTS. RESTORE SURFACE TO MATCH SURROUNDINGS.

5. PVC SCHEDULE 80 CONDUIT. SEE PLAN FOR SIZE, QUANTITY AND FILL.

SCALE

NONE

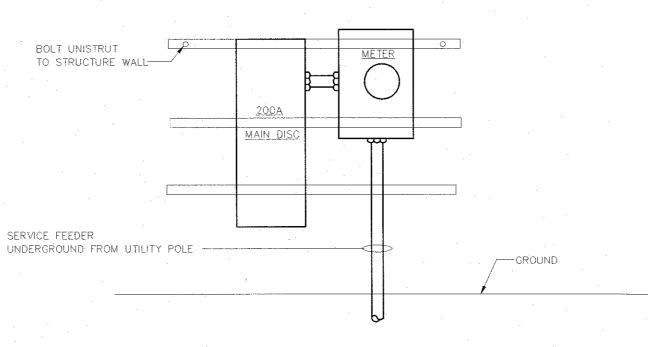

SURFACE MOUNTED METER & DISCONNECT

N.T.S.

ENTRANCE TO AND EGRESS FROM WORKING SPACE:

PER N.E.C. 110.26 (C)(1) & (2):

1. MINIMUM REQUIRED: AT LEAST ONE ENTRANCE OF SUFFICIENT AREA SHALL BE PROVIDED TO GIVE ACCESS TO AND EGRESS FROM WORKING SPACE ABOUT ELECTRICAL EQUIPMENT.

2. LARGE EQUIPMENT: FOR EQUIPMENT RATED AT 1200 AMPERES OR MORE OVER 1.8m (6'-0") WIDE THAT CONTAINS OVERCURRENT DEVICES, SWITCHING DEVICES OR CONTROL DEVICES, THERE SHALL BE ONE ENTRANCE TO AND EGRESS FROM THE REQUIRED WORKING SPACE NOT LESS THAN 610mm (24") WIDE AND 2.0m (6'-6") HIGH AT EACH END OF THE WORKING SPACE. A SINGLE ENTRANCE TO AND EGRESS FROM THE REQUIRED WORKING SPACE SHALL BE PERMITTED WHERE EITHER OF THE FOLLOWING CONDITIONS ARE MET:

a.) WHERE THE LOCATION PERMITS A CONTINUOUS AND UNOBSTRUCTED WAY OF EGRESS TRAVEL, A SINGLE ENTRANCE TO THE WORKING SPACE SHALL BE PERMITTED.

b.) EXTRA WORKING SPACE. WHERE THE DEPTH OF THE WORKING SPACE IS TWICE THAT REQUIRED, A SINGLE ENTRANCE SHALL BE PERMITTED.

WORKING SPACE CLEARANCES AROUND ELECTRICAL EQUIPMENT

NOMINAL VOLTAGE TO	MINIMUM CLEAR DISTANCE			
GROUND	CONDITION 1	CONDITION 2	CONDITION 3	
0-150 VOLTS	914mm (3'-0")	914mm (3'-0")	914mm (3'-0")	
151-600 VOLTS	914mm (3'-0")	1.07m (3'-6")	1.22m (4'-0")	
601-2500 VOLTS	914mm (3'-0")	1.2m (4'-0")	1.5m (5'-0")	
2501-9000 VOLTS	1.2m (4'-0")	1.5m (5'-0")	1.8m (6'-0")	
9000-25000 VOLTS	1.5m (5'-0")	1.8m (6'-0")	2.8m (9'-0")	

WHERE THE FOLLOWING CONDITIONS ARE AS FOLLOWS:


CONDITION 1: EXPOSED LIVE PARTS ON ONE SIDE OF THE WORKING SPACE AND NO LIVE OR GROUNDED PARTS ON THE OTHER SIDE OF THE WORKING SPACE, OR EXPOSED LIVE PARTS ON

GUARDED BY INSULATING MATERIALS.

CONDITION 2: EXPOSED LIVE PARTS ON ONE SIDE OF THE WORKING SPACE AND GROUNDED PARTS ON THE OTHER SIDE OF THE WORKING SPACE. CONCRETE, BRICK, OR TILE WALLS SHALL BE CONSIDERED AS GROUNDED.

BOTH SIDES OF THE WORKING SPACE THAT ARE EFFECTIVELY

CONDITION 3: EXPOSED LIVE PARTS ON BOTH SIDES OF THE WORKING SPACE.

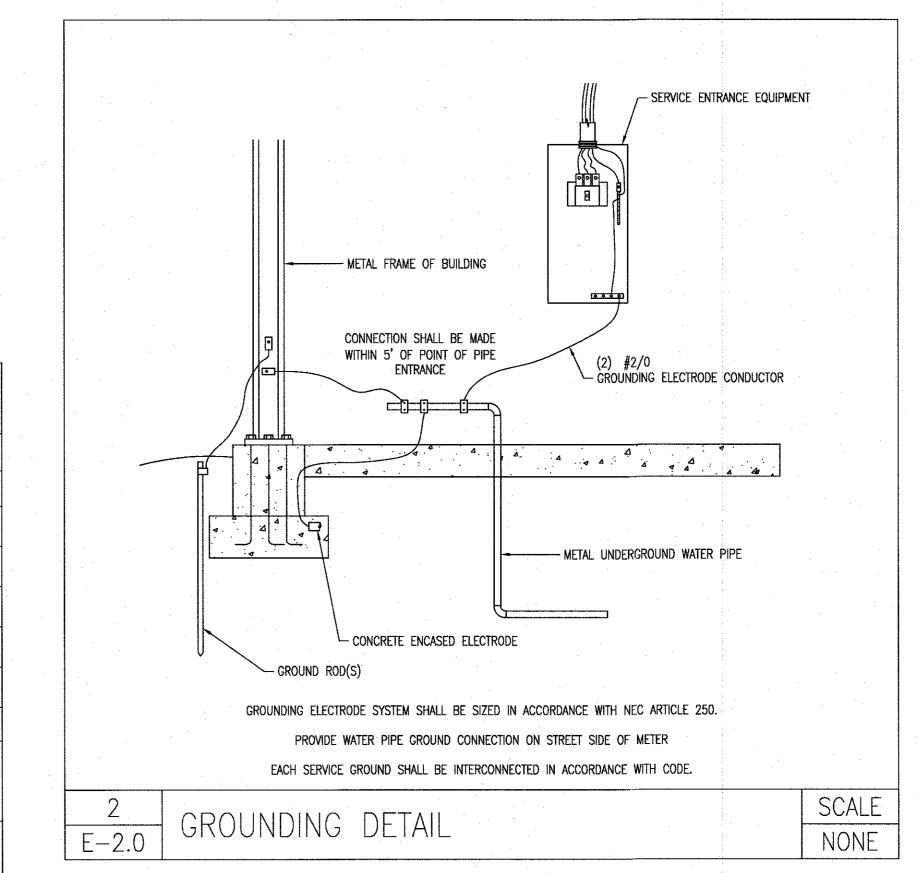

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NJ PROFESSIONAL PLANNER No. 33LI00555700
NJ REGISTERED ARCHITECT No. 21AI01487200
ALL DIMENSIONS MUST BE VERIFIED BY
CONTRACTOR AND OWNER MUST BE NOTIFIED
OF ANY DISCREPANCIES BEFORE PROCEEDING

WITH THE WORK.

PROJECT:

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CAMDEN

STRUCTURE ACADEMY AT THE TRAINING CENTER

SMOKE TOWER ST DEN COUNTY FIRE A ONAL EMERGENCY TI 420 NORTH WOODBURY-TURN BLACKWOOD NEW JERS

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REVISIONS

DESCRIPTION

DATE

ELECTRICAL SINGLE LINE & SCHEDULES

RAWING TITLE:

JOB NO:
CCC2023-01

DATE:
DATE:
MAY 30, 2024

SCALE:
AS NOTED

DRAWN BY:
DM3

CHECKED BY:
SMB

DRAWING NUMBER:

E-2.0