


ALTERATIONS TO TREASURY MOTOR POOL BAYSIDE STATE PRISON 4342 NJ-47 MAURICE RIVER, N.J. 08314 DPMC NO. A1397-00 STATE OF NEW JERSEY HONORABLE PHILIP D. MURPHY, GOVERNOR HONORABLE PHILIP D. MURPHY, GOVERNOR


DIVISION OF PROPERTY MANAGEMENT & CONSTRUCTION CHRISTOPHER CHIANESE, DIRECTOR

ELIZABETH MAHER MUOIO, STATE TREASURER

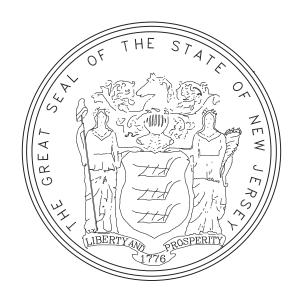


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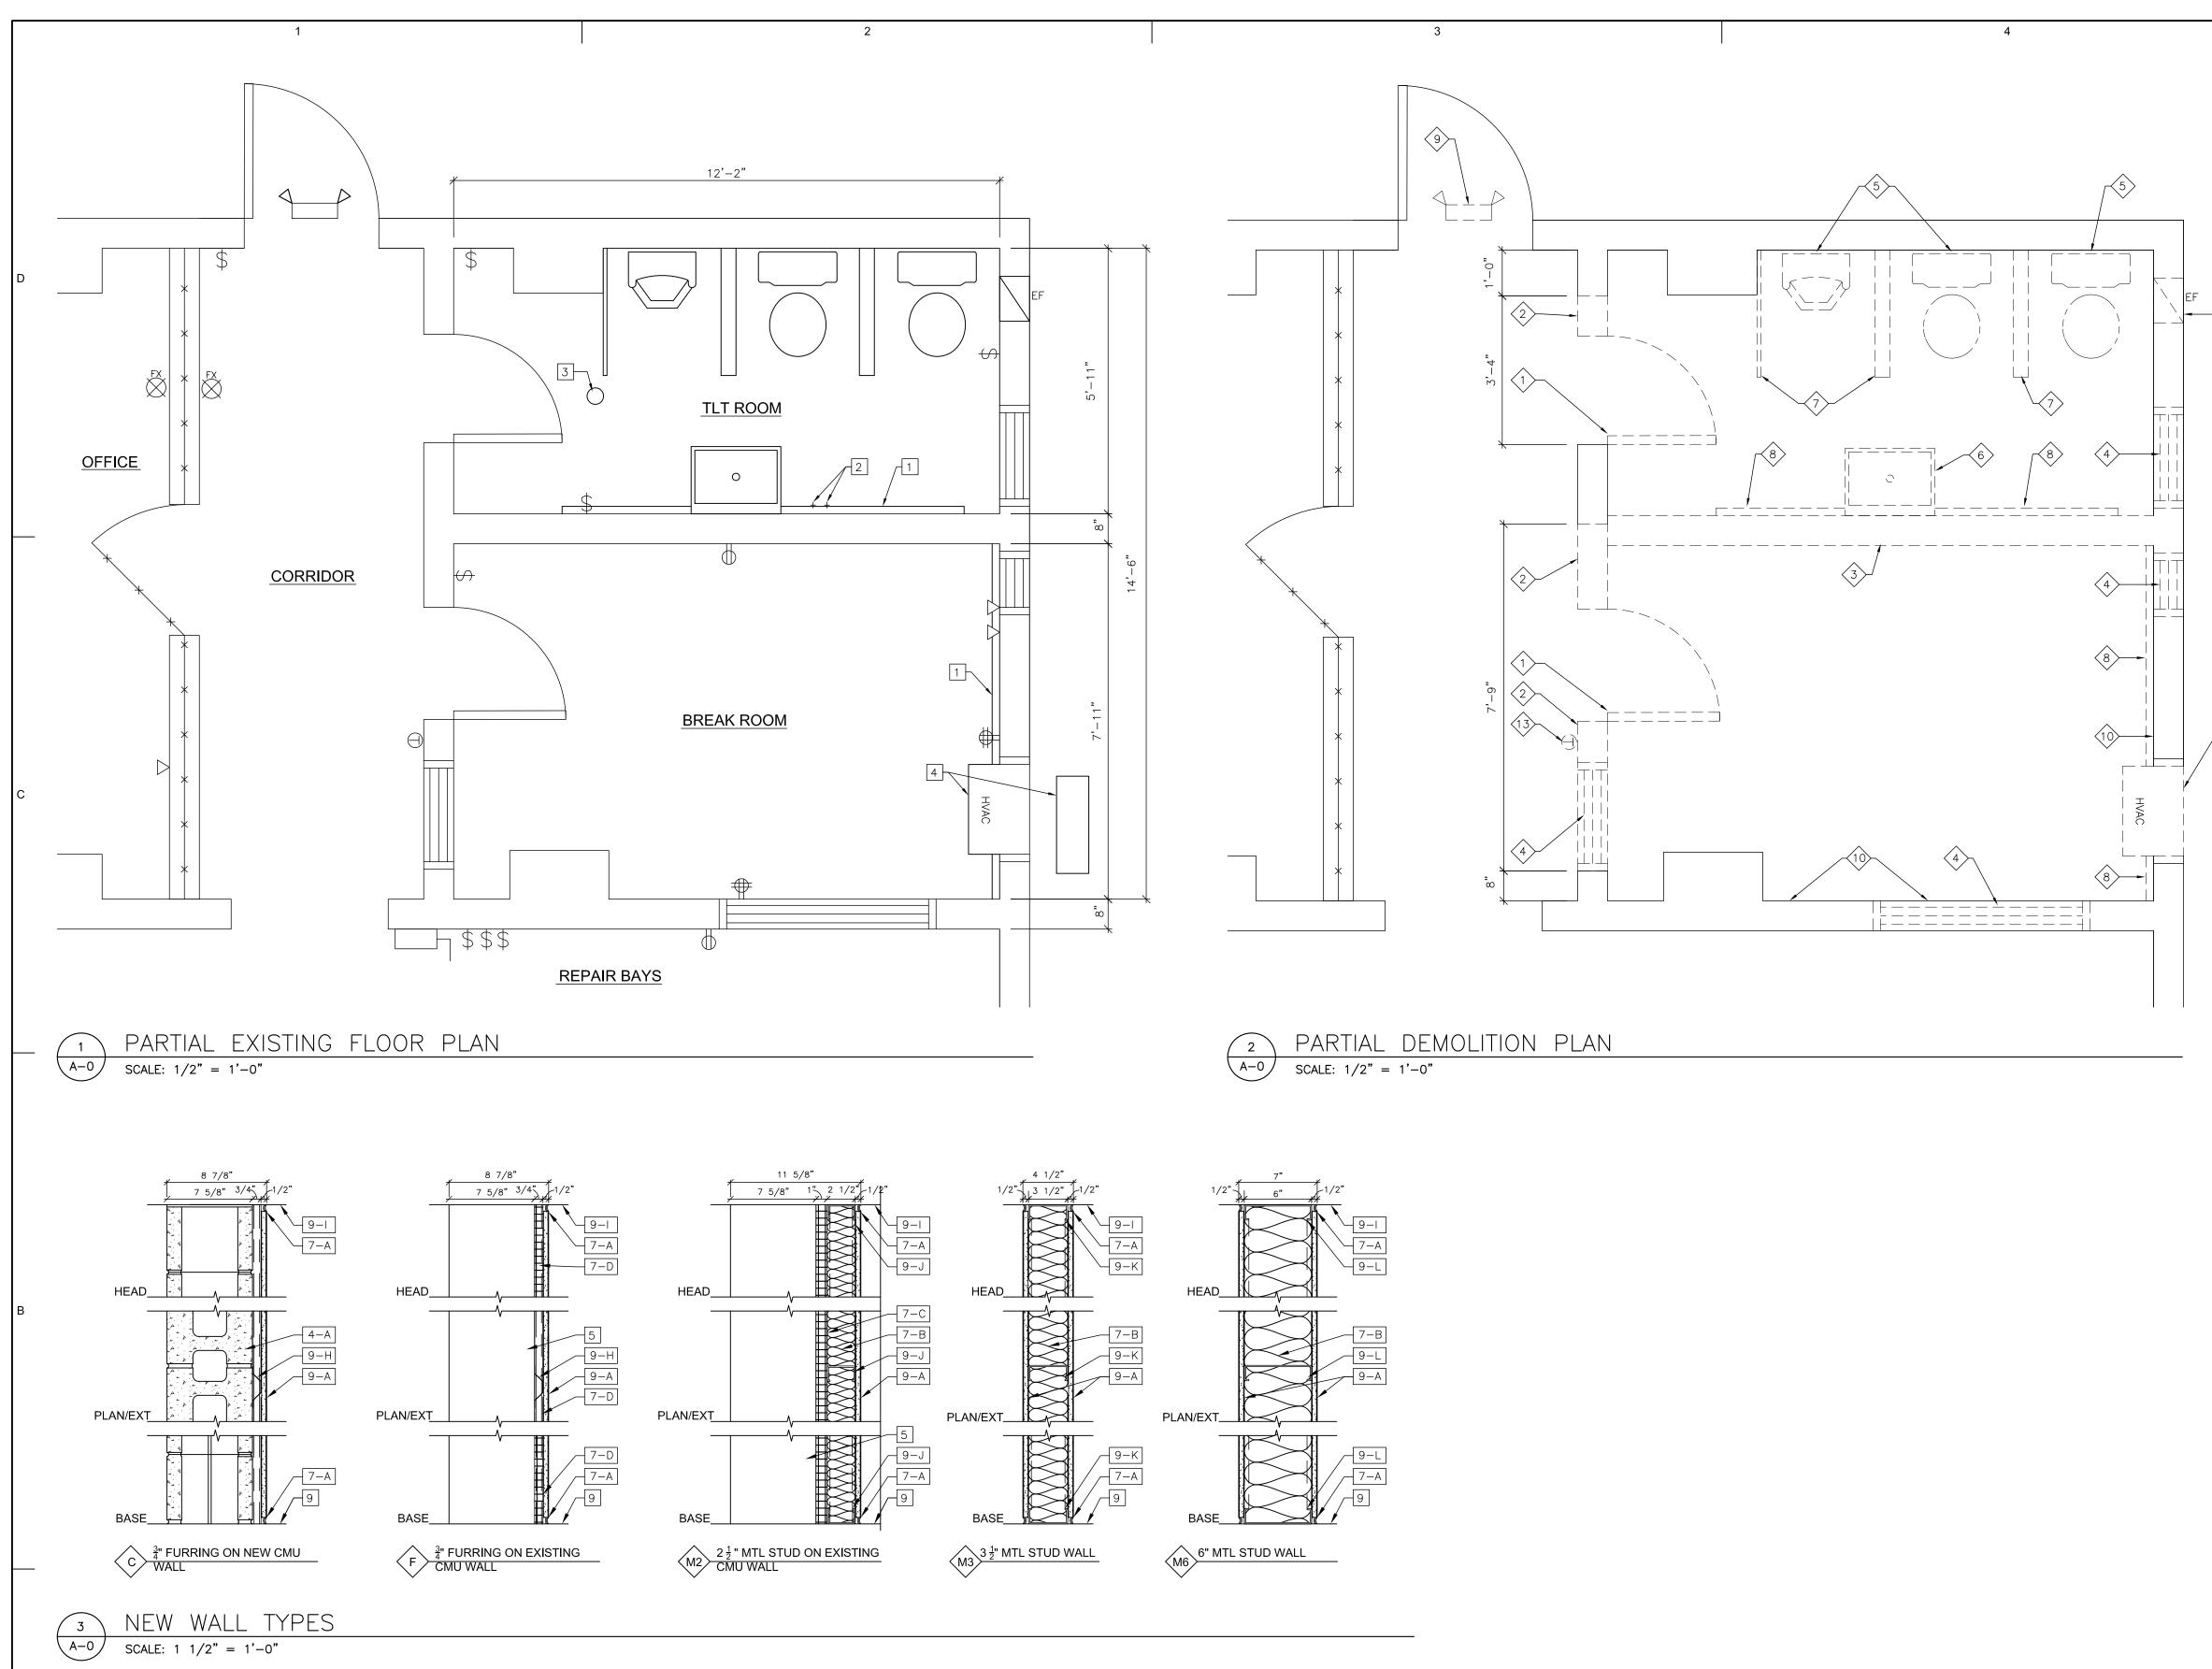
RAD REF RFL REFR REINF RESIL REV RFG RM RO	RADIUS REFERENCE REFLECT(ED) REFRIGERATOR REINFORCE(D)/REINFORCING RESILIENT REVISION(S)/REVISED ROOFING ROOM ROUGH OPENING	
	SANITARY DRAIN SECTION SHEET SINK BASE CABINET SPECIFICATION(S) SQUARE INCH SQUARE INCH SQUARE FOOT SQUARE FOOT SQUARE FEET (FOOT) SERVICE SINK STANDARD STRUCTURAL THICK/THICKNESS TOILET TOP OF TYPICAL VENT VERTICAL VINYL COMPOSITION TILE VINYL TILE VENT THROUGH ROOF WALL CABINET WATER HEATER WAINSCOT WATER CLOSET WIDD/W WITH WITHOUT WOOD WEATHERPROOF	

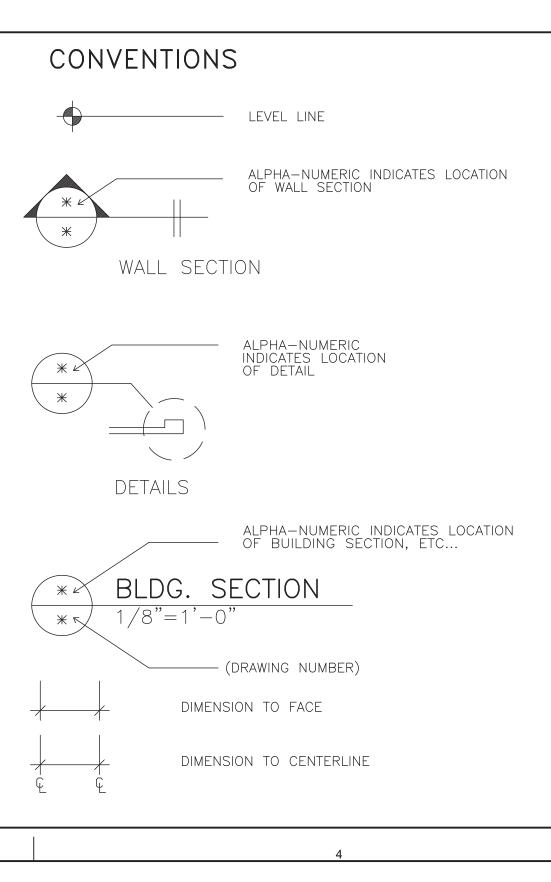



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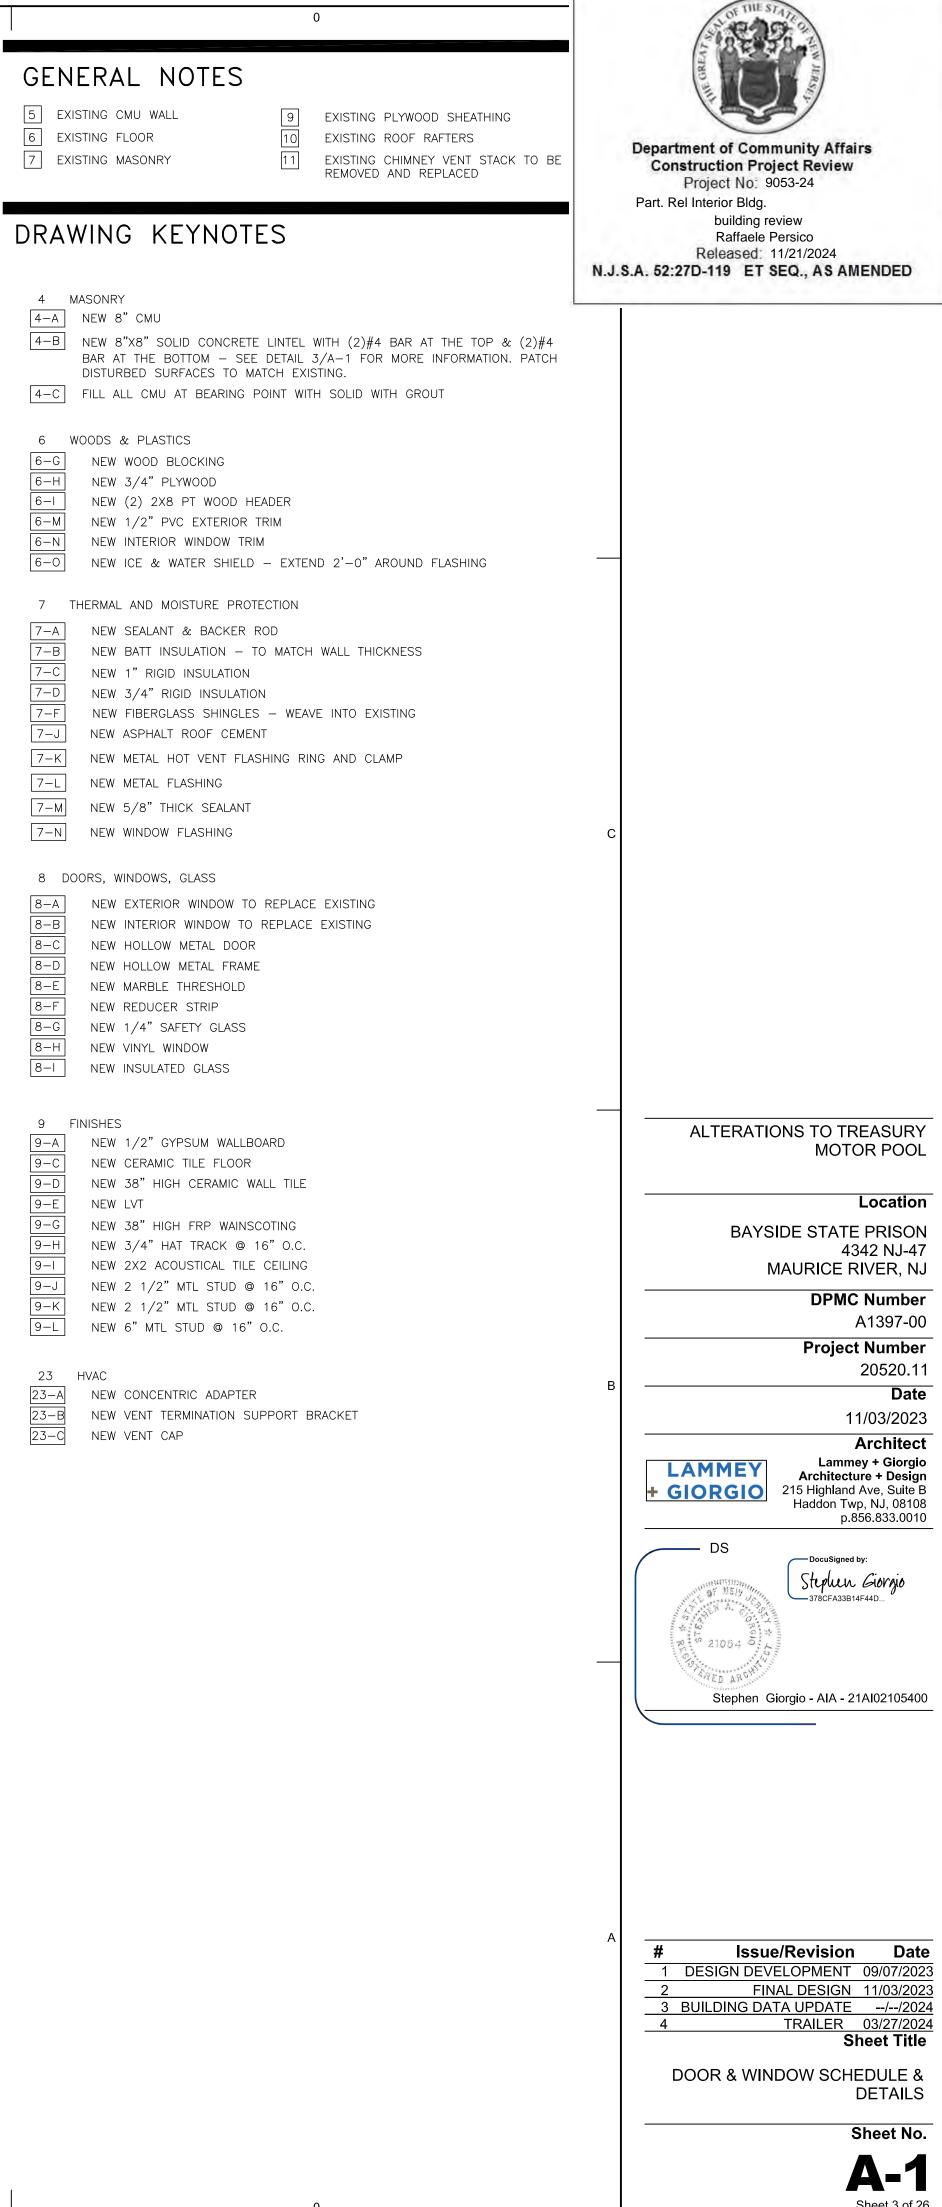





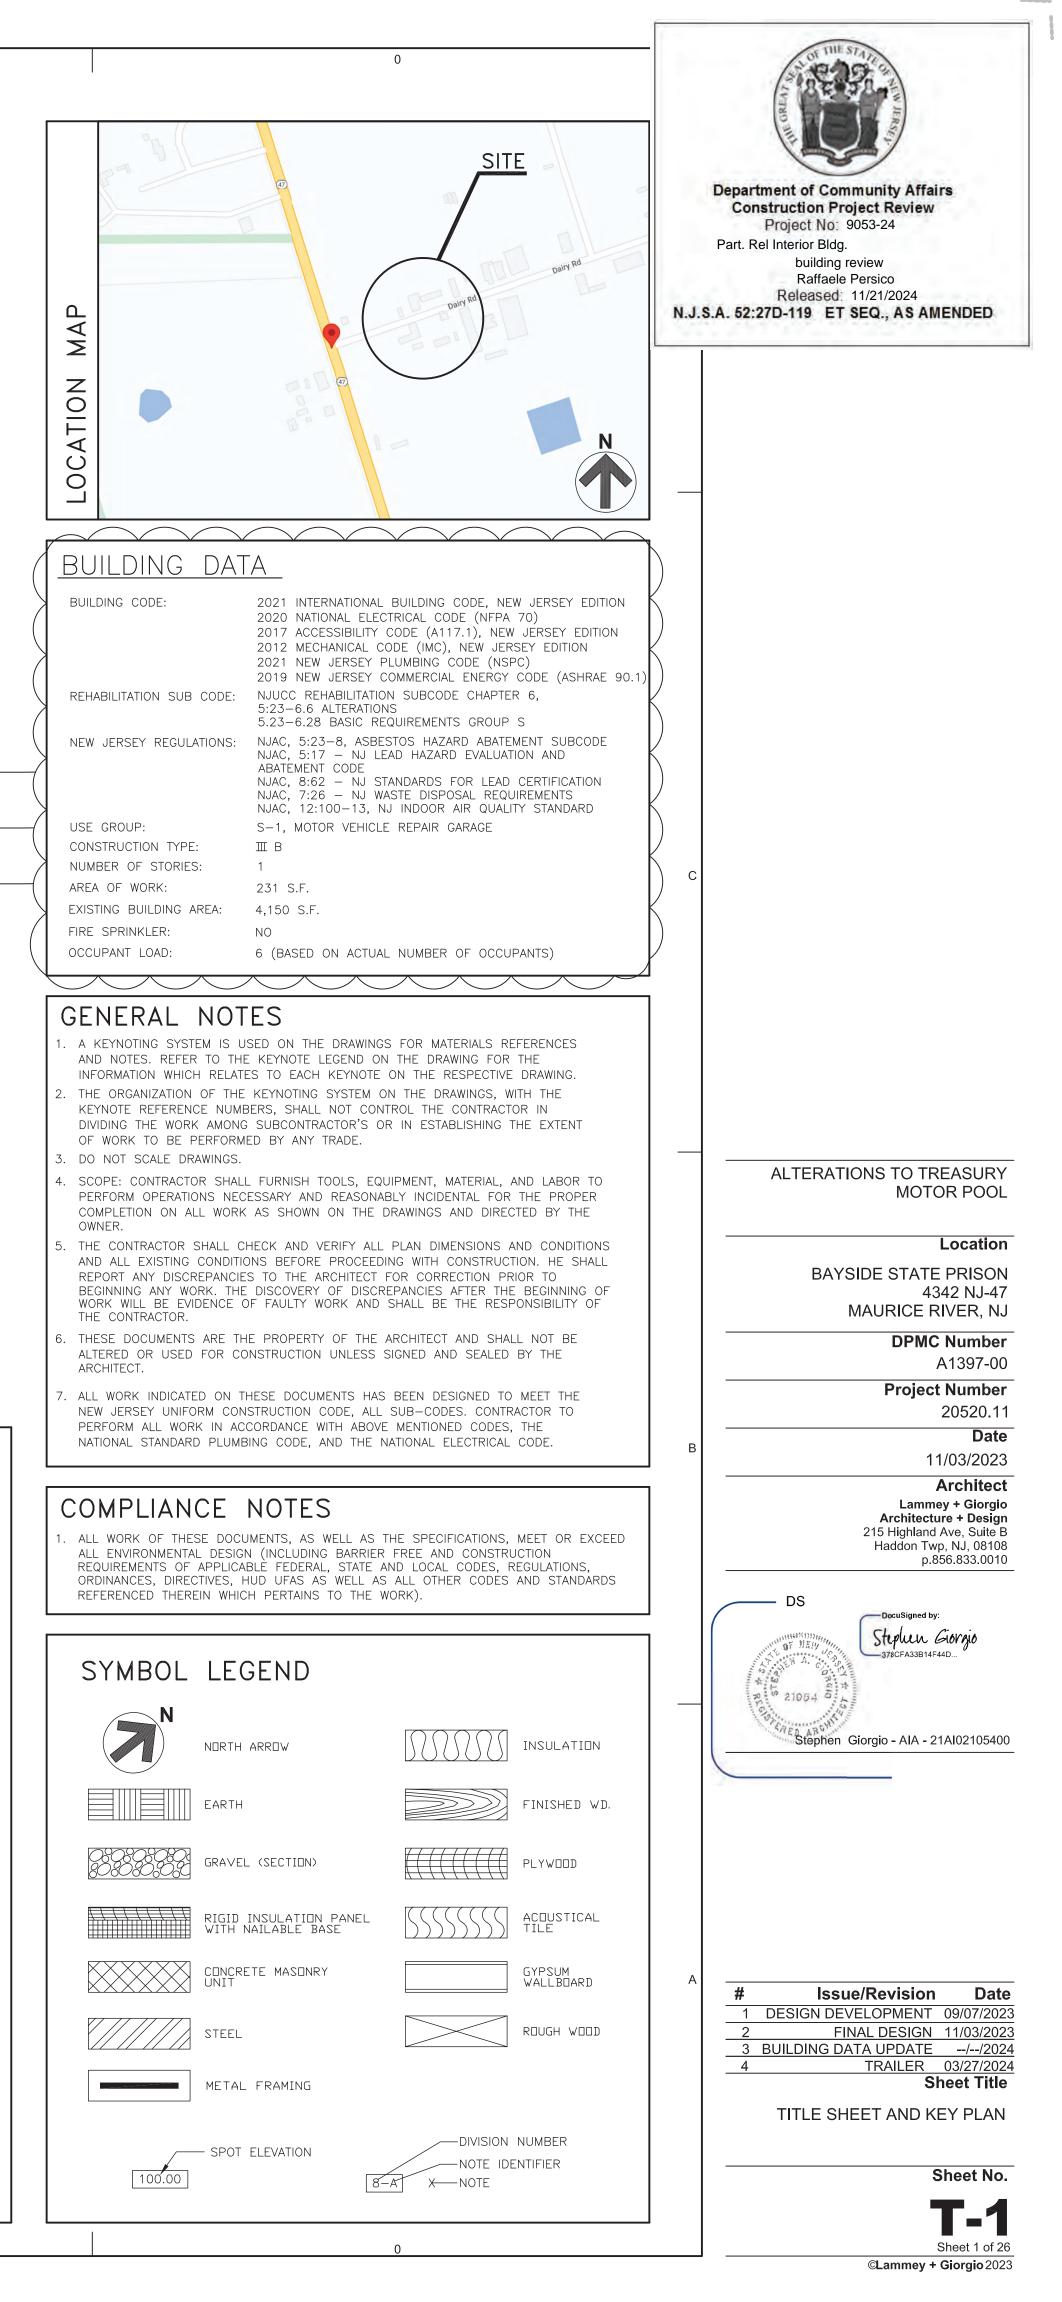

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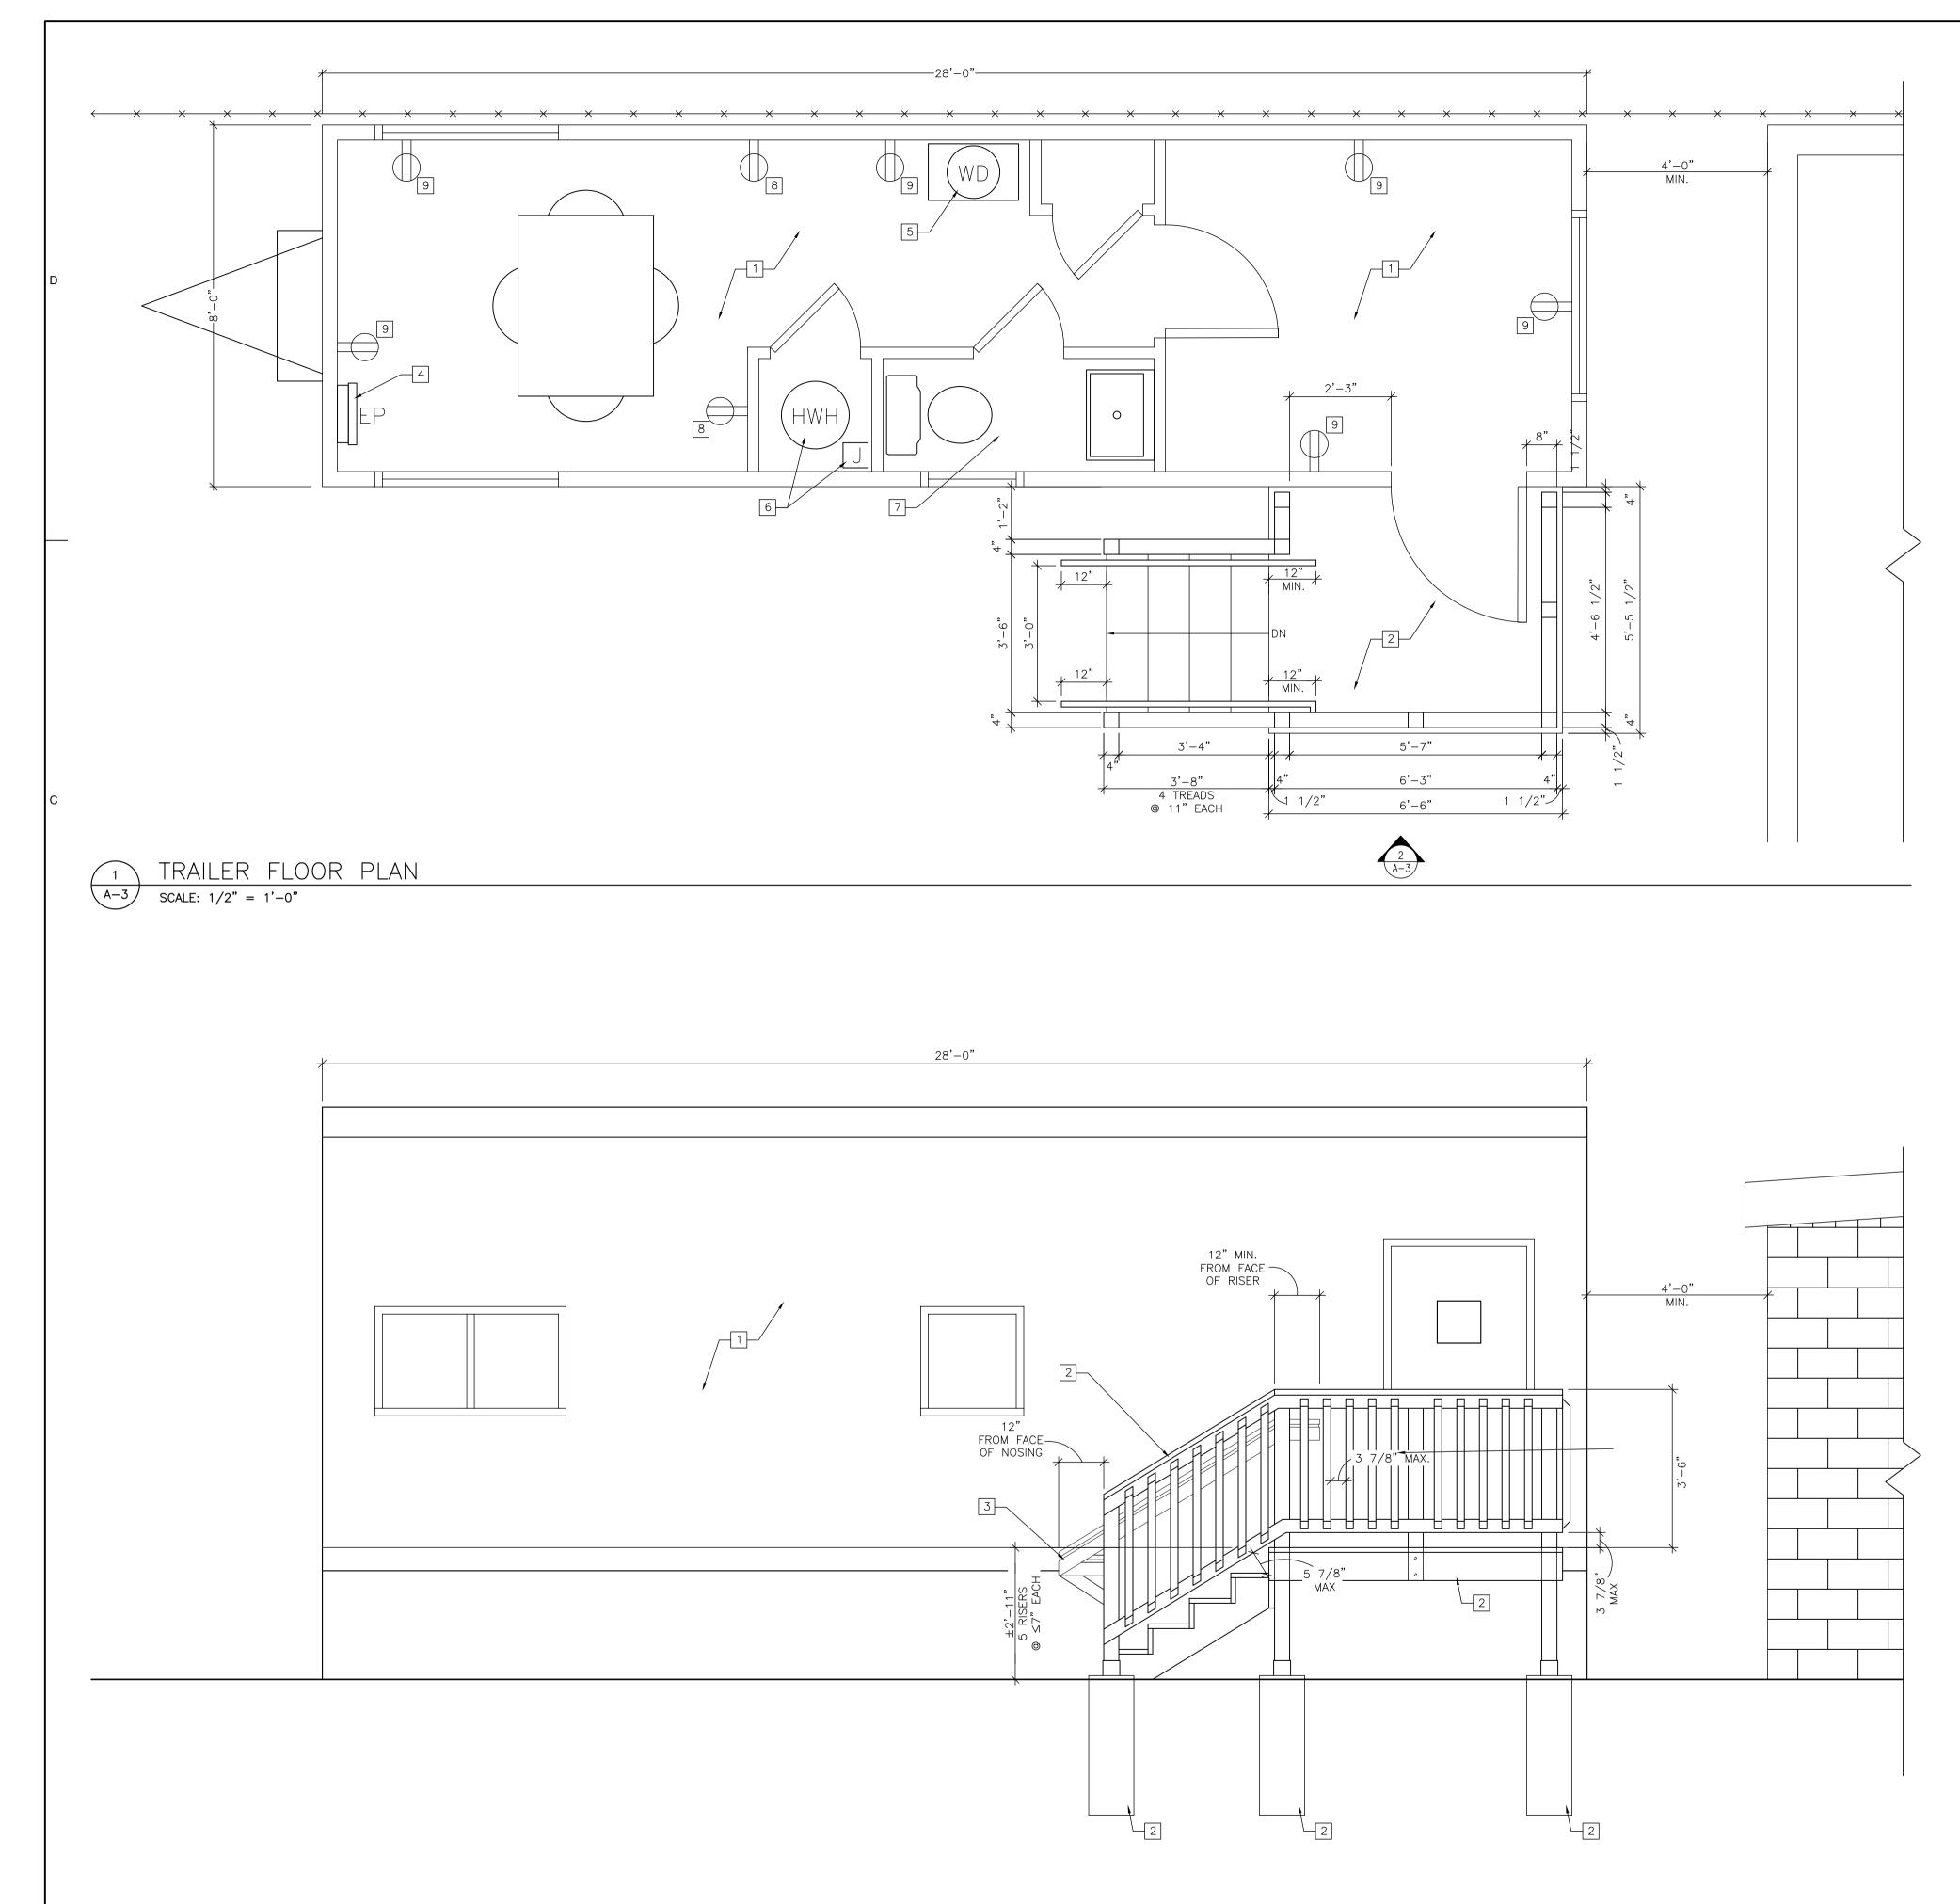
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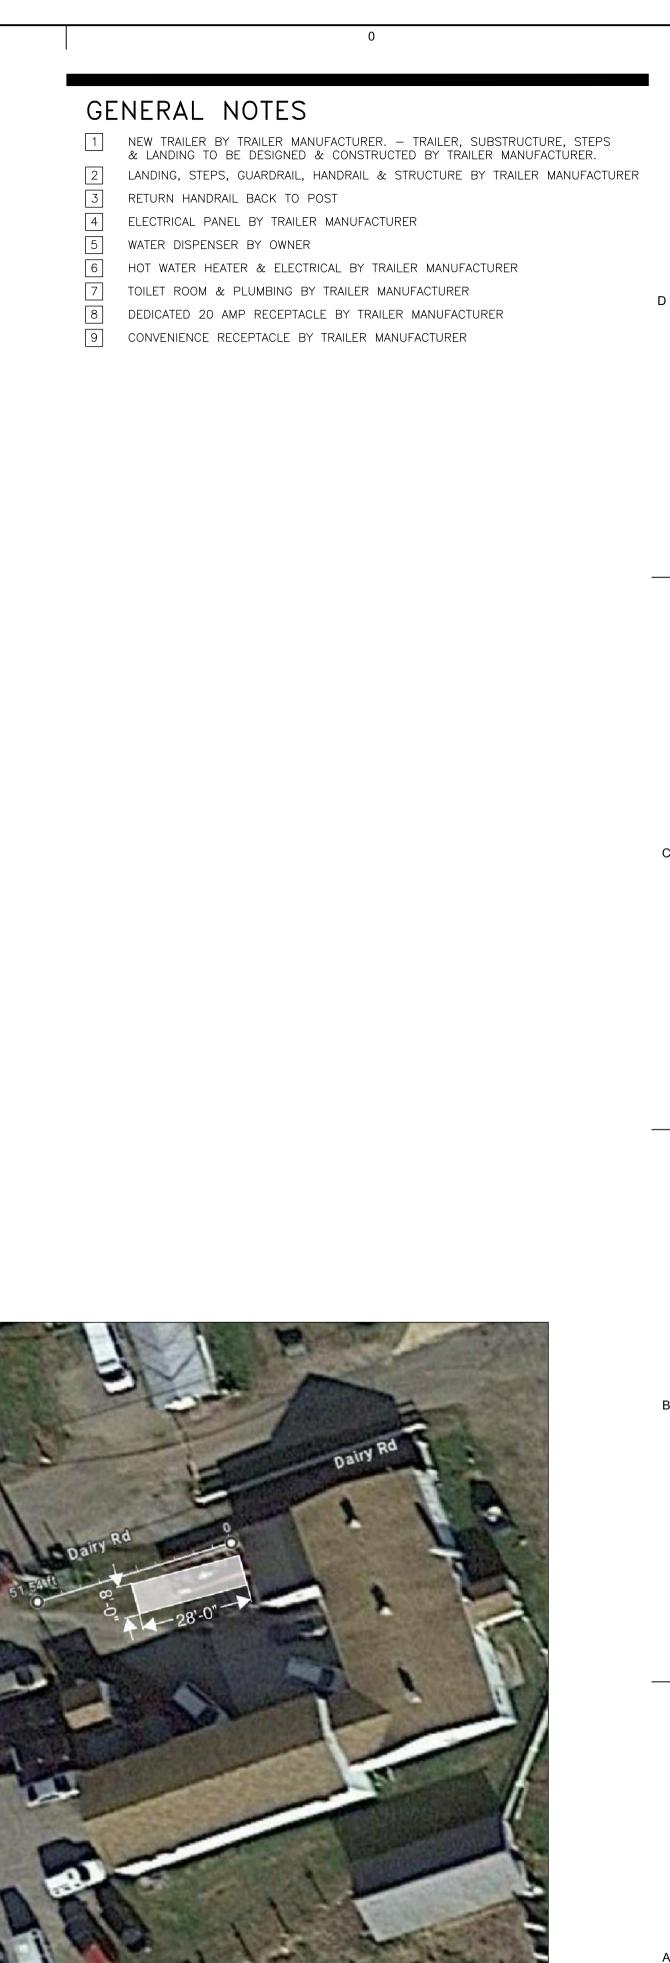
LEGEN	D	B			
	EXISTING CONSTRUCTION	Ē	EXISTING DOOR	De	epartment of Community Affairs
	NEW CMU WALL WITH 3/4"HAT TRACK AND 1/2"GYPSUM WALLBOARD.		NEW DOOR CHAIN LINK FENCE		Construction Project Review Project No: 9053-24 art. Rel Interior Bldg. building review Raffaele Persico
	FURR OUT EXISTING WALL WITH NEW 3/4" HAT TRACK WITH RIGID		EMERGENCY EXIT SIGN EMERGENCY EXIT LIGH		Released: 11/21/2024 . 52:27D-119 ET SEQ., AS AMENDE
	INSULATION AND 1/2" GYPSUM WALLBOARD.		SUPPLY		
	NEW CMU INFILL WITH INEW 3/4" HAT TRACK WITH RIGID INSULATION, AND 1/2" GYPSUM WALLBOARD.	(E)	2X2 LED FIXTURE EXISTING		
Y	NEW 2 1/2" MTL STUD WALL WITH 1/2" GYPSUM WALLBOARD ON INTERIOR SIDE & 1" RIGID INSULATION ON EXTERIOR SIDE.	(N) (T)	NEW THERMOSTAT		
	NEW 3 $\frac{1}{2}$ " MTL STUD WALL WITH 1/2" GYPSUM WALLBOARD ON BOTH SIDES & R-19 BATT INSULATION IN STUD CAVITY.				
	NEW 6" MTL STUD WALL WITH 1/2" GYPSUM WALLBOARD ON BOTH SIDES & R–19 BATT INSULATION IN STUD CAVITY.			с	
4 SPLIT SY		DOOR UNIT			
4 SPLIT SY DRAWIN 4 MASON 4 A MASON 4-A NEW 4-B NEW BAR DIST	ISTEM DUCTLESS INDOOR & OUT	WITH (2)#4 B, 3/A-1 FOR M STING.	IORE INFORMATION. PATC		ALTERATIONS TO TREASU MOTOR PO Loca BAYSIDE STATE PRIS
4 SPLIT SY DRAWIN 4 MASON 4 MASON 4-A NEW 4-B NEW BAR DIST 4-C FILL 6 WOODS 6-A NE BAR 6-B NE 6 NE	STEM DUCTLESS INDOOR & OUT IG KEYNOTES IRY 8" CMU 8"X8" SOLID CONCRETE LINTEL AT THE BOTTOM – SEE DETAIL URBED SURFACES TO MATCH EX	WITH (2)#4 B, 3/A–1 FOR M STING. TH SOLID WITH	IORE INFORMATION. PATC	н	MOTOR PO Loca BAYSIDE STATE PRIS 4342 N MAURICE RIVER DPMC Num A139 Project Num
4 SPLIT SY A MASON 4 MASON 4-A NEW 4-B NEW BAR DIST 4-C FILL 6 WOODS 6-A NE 6-B NE 6-C NE 6-C NE 6-C NE 8 DOORS, 8-A NE 8-B NE	STEM DUCTLESS INDOOR & OUT IG KEYNOTES IRY 8" CMU 8"X8" SOLID CONCRETE LINTEL AT THE BOTTOM – SEE DETAIL URBED SURFACES TO MATCH EX ALL CMU AT BEARING POINT WI S & PLASTICS W SOLID SURFACE COUNTERTOP CKSPLASH W WOOD WALL CABINETS W WOOD BASE CABINETS	WITH (2)#4 B, 3/A–1 FOR M STING. TH SOLID WITH ON 3/4" PAR ⁻¹ E EXISTING	IORE INFORMATION. PATC	H GH B B	MOTOR PC Loca BAYSIDE STATE PRIS 4342 N MAURICE RIVER DPMC Num A139 Project Num 2052 I 11/03/2 Archi LAMMEY
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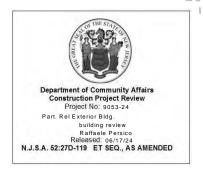


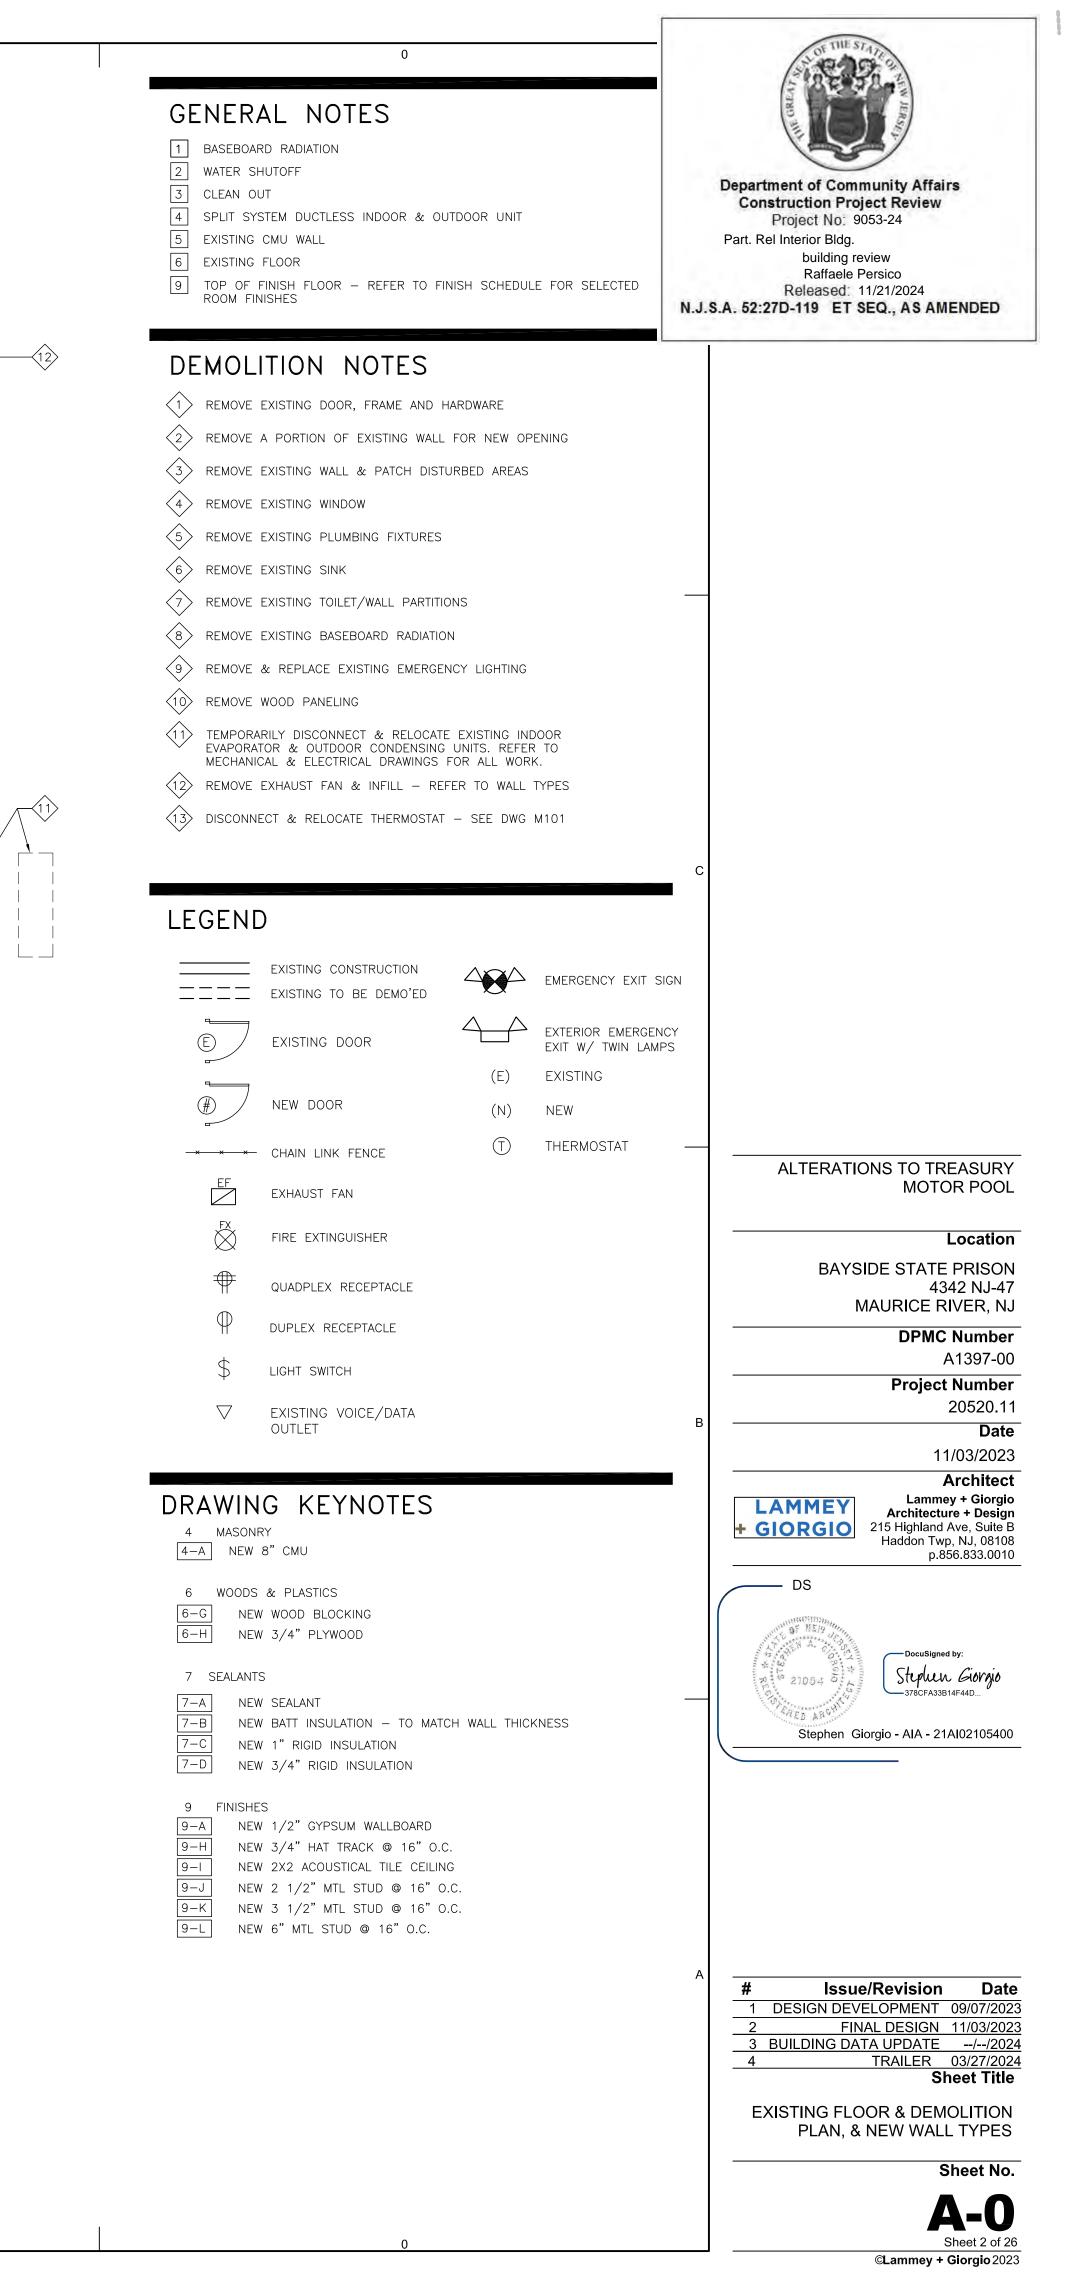 $\begin{array}{c|c} 2 & TRAILER & ELEVATION \\ \hline A-3 & SCALE: 1/2" = 1'-0" \end{array}$

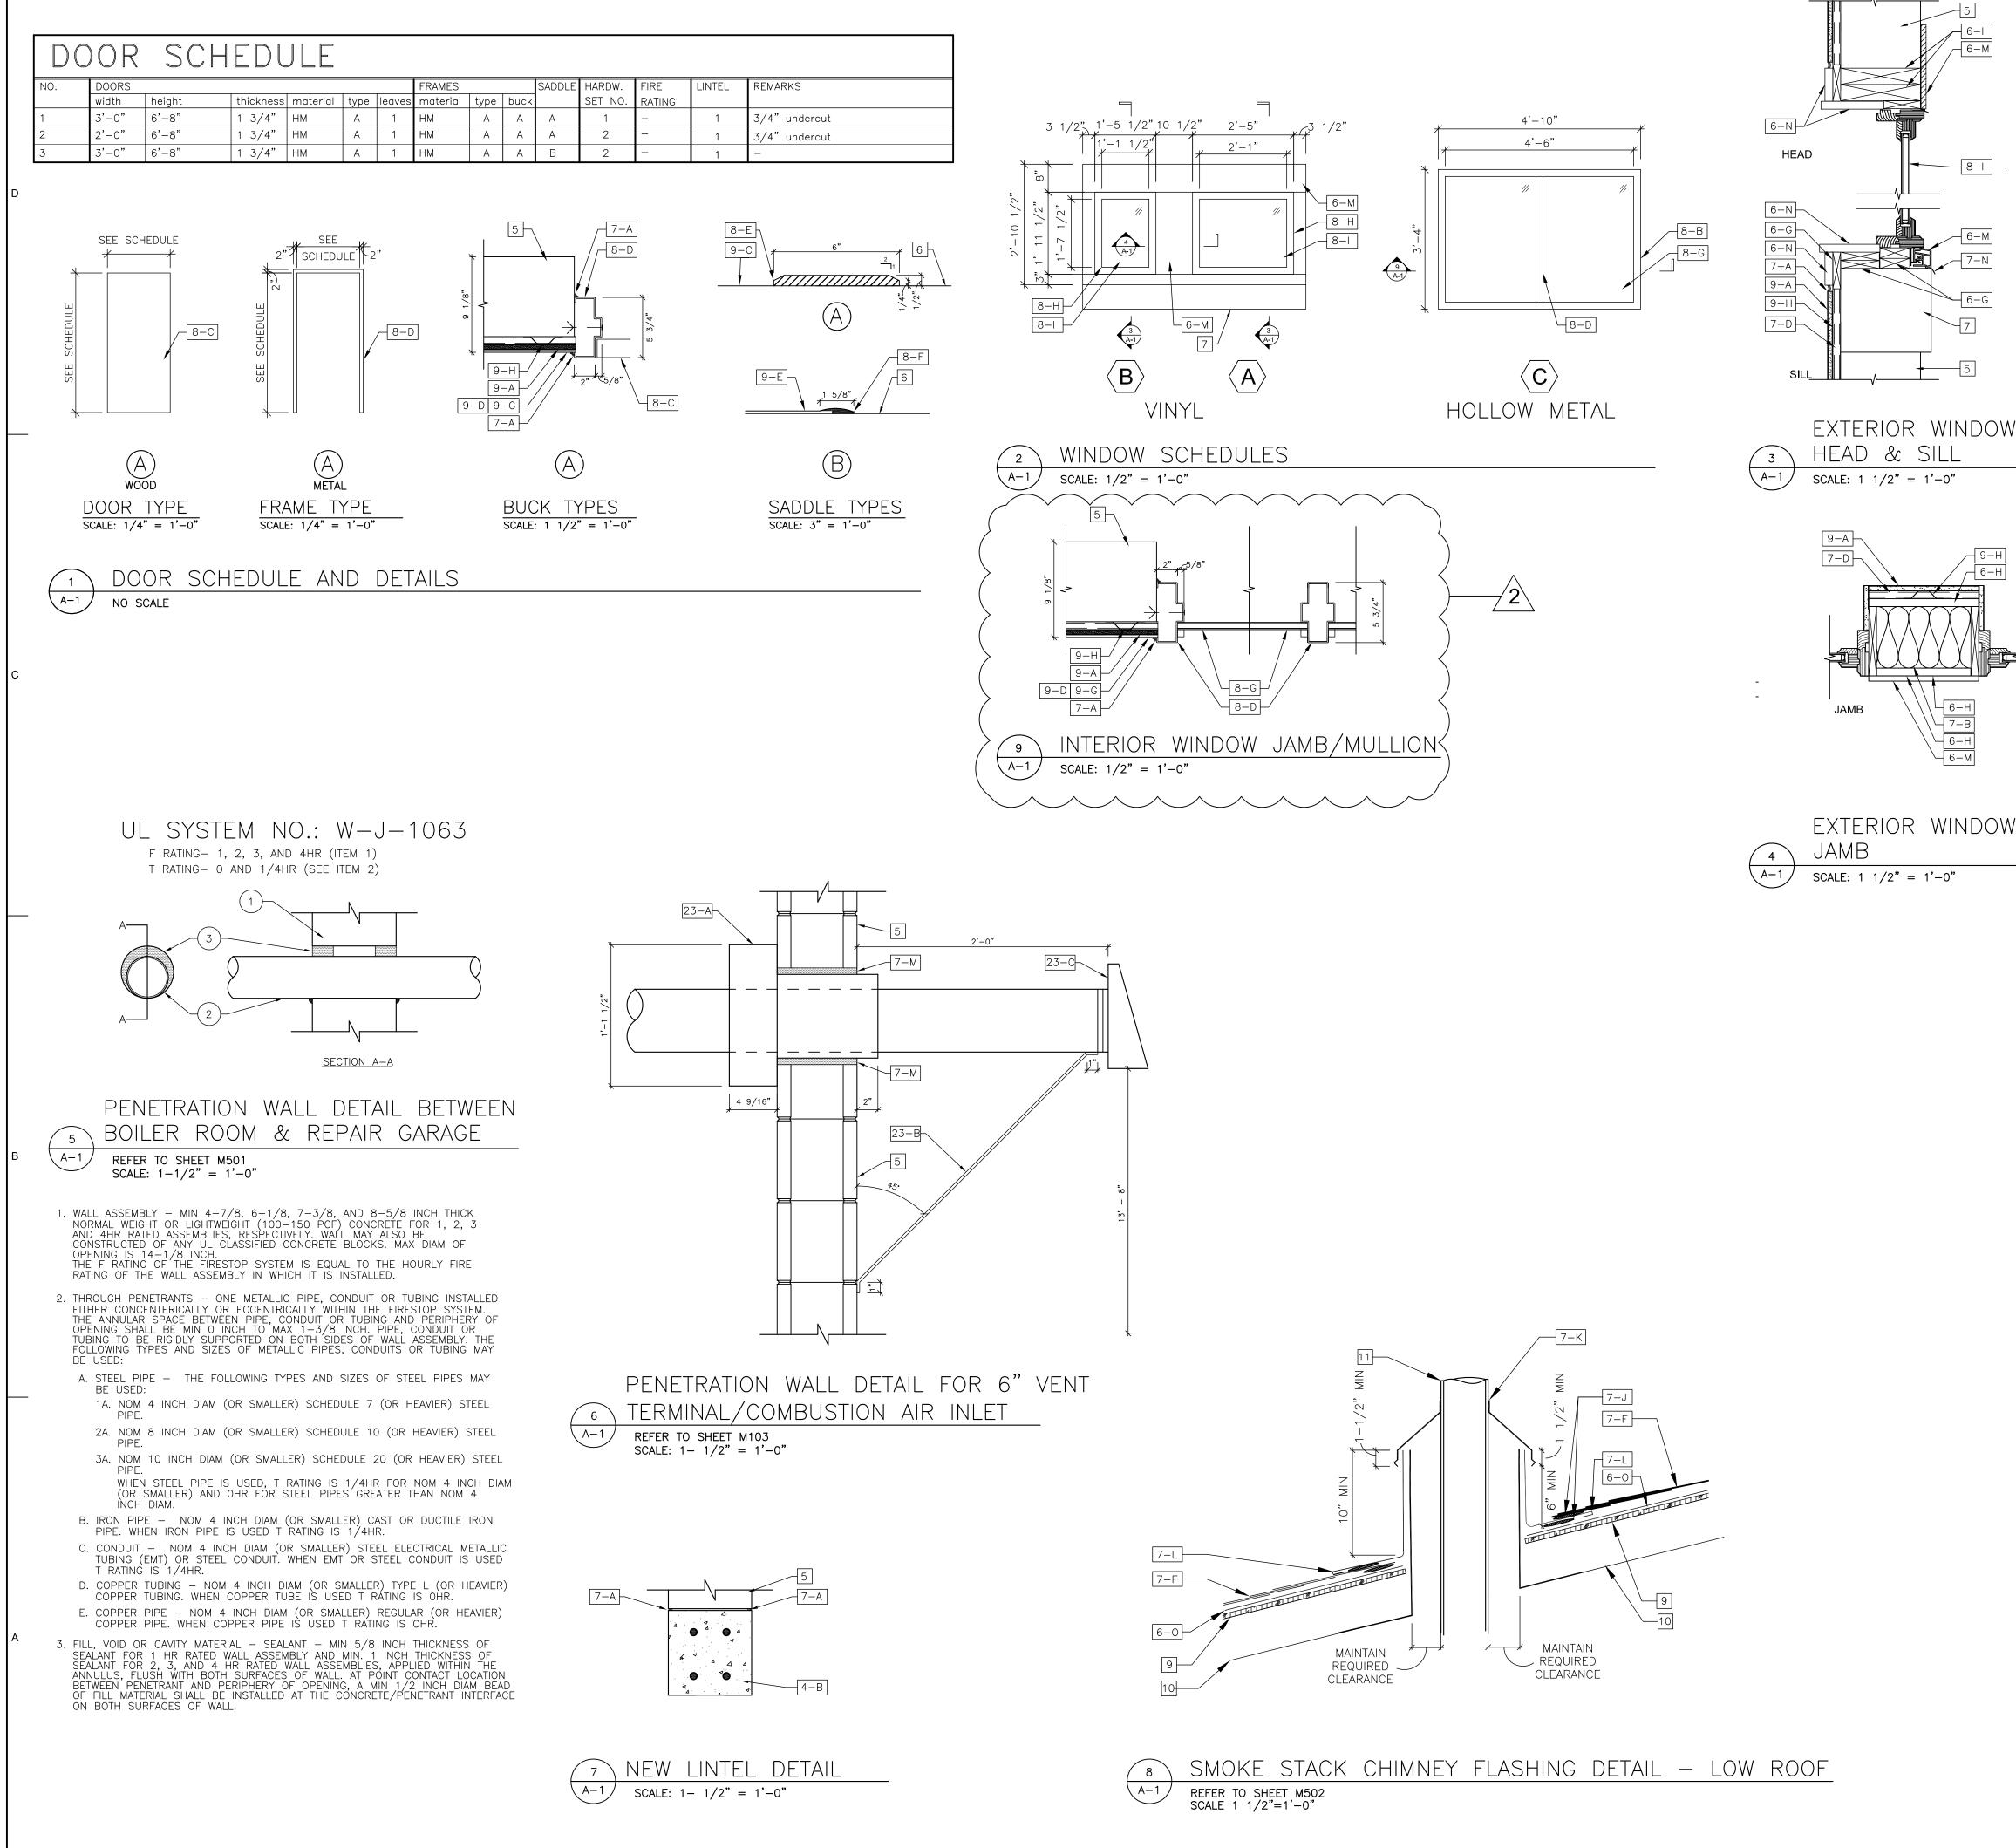

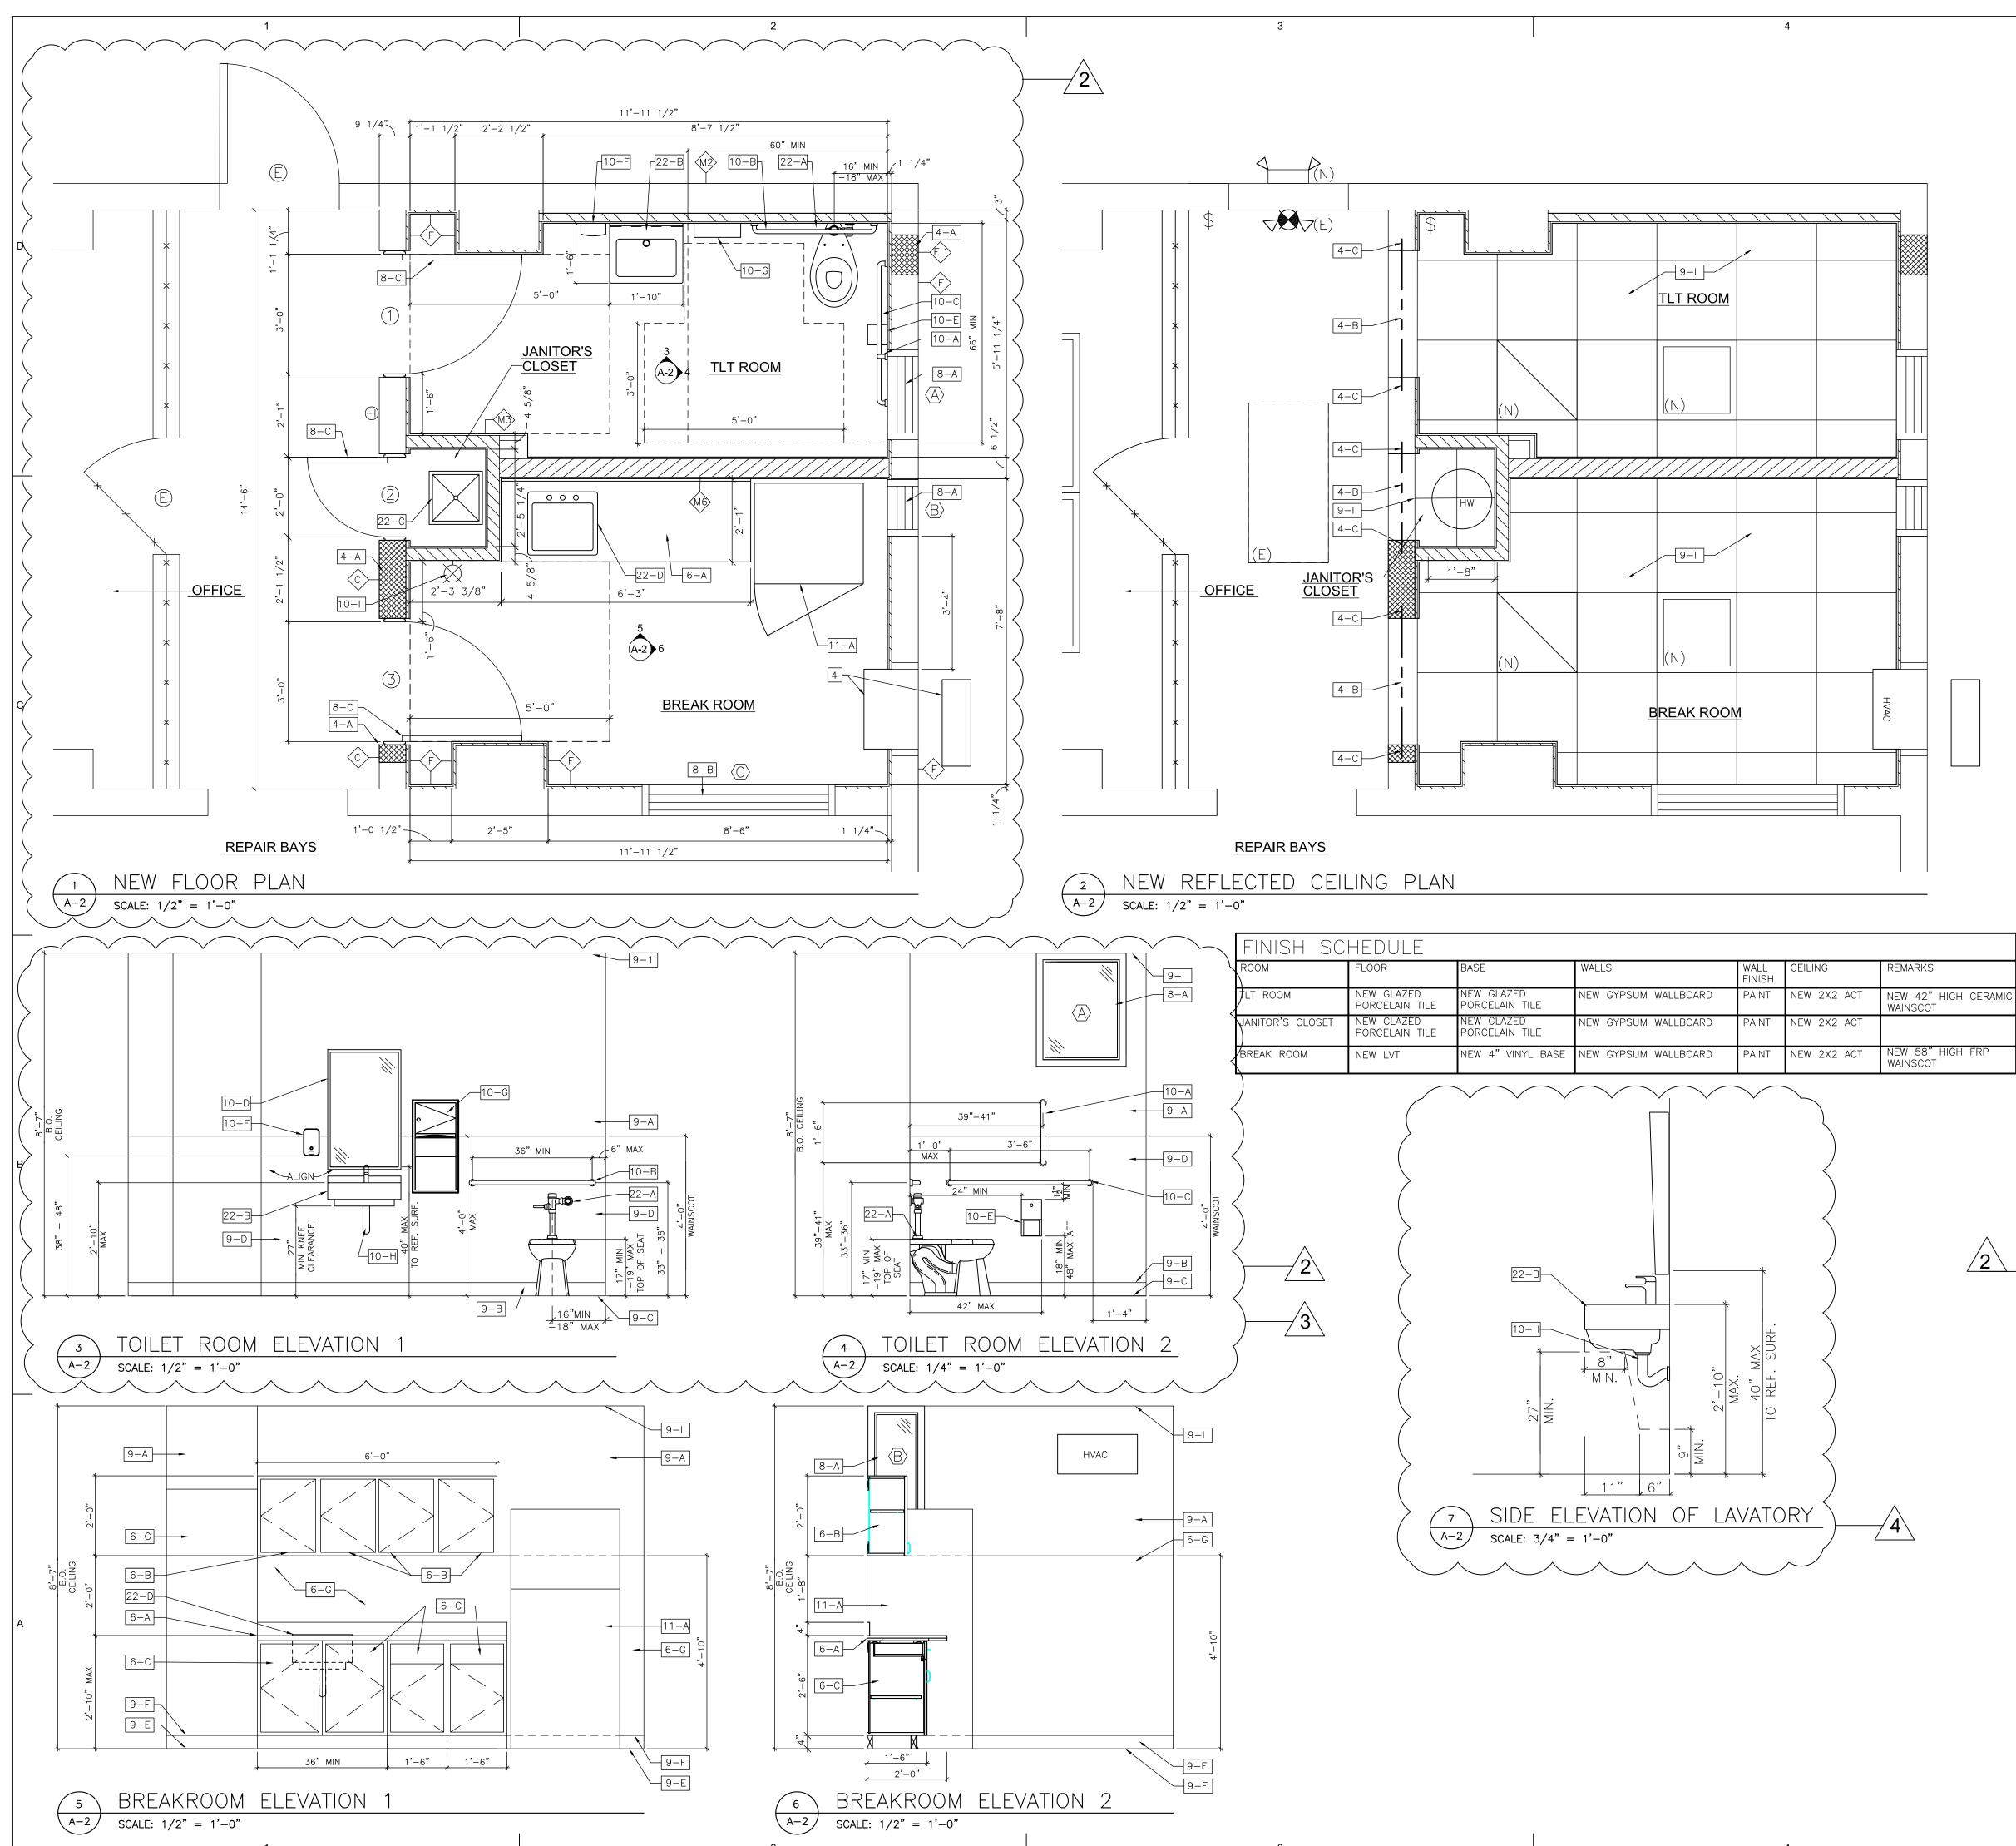

SITE PLAN WITH TRAILER



ALTERATIONS TO TREASURY MOTOR POOL

Location

BAYSIDE STATE PRISON 4342 NJ-47 MAURICE RIVER, NJ DPMC Number A1397-00 Project Number 20520.11 Date 20520.11 Date 11/03/2023 Architect Lammey + Giorgio Architecture + Design 215 Highland Ave, Suite B Haddon Twp, NJ, 08108 p.856.833.0010

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Sheet No. A-3 Sheet 4 of 26 ©Lammey + Giorgio 2023

	1
SYMBOL	S
<u>ہے۔۔۔۔</u>	WORK, FURNISH AND INSTALL
~~~~~~~~~~~~~~~~~~~~~~~~~~~~~~~~~~~~~~~	EXISTING SYSTEM TO REMAIN
¥++++R	REMOVE EXISTING SYSTEM
BDD	BACKDRAFT DAMPER
 {	PIPE UP
G{	PIPE DROP
	PIPE CAPPED
_	PITCH DIRECTION
<u>ب</u> ۲ ۱	PRESSURE GAUGE
<del>بال</del> ے	THERMOMETER
$\bigcirc$	PUMP
<b>،</b>	UNION FOR PIPE SIZES 2" AND SMALLER, FLANGE FOR PIPE SIZES 2-1/2" AND LARGER
	SHUTOFF VALVE
Ň	CHECK VALVE
	PRESSURE (TEMPERATURE) RELIEF VALVE
Ţ	AUTOMATIC AIR VENT
$\bigtriangledown$	PRESSURE REDUCING VALVE
	3/4" UNDERCUT DOOR
<b>↓</b>	STRAINER
$\odot$	WALL MOUNTED CARBON MONOXIDE (CO) DETECTOR AT 5'-0" ABOVE FINISHED FLOOR
3	WALL MOUNTED EMERGENCY BOILER SHUTOFF SWITCH AT 5'-0" ABOVE FINISHED FLOOR
7	WALL MOUNTED THERMOSTAT AT 5'-0" ABOVE FINISHED FLOOR
(CG)	CEILING MOUNTED COMBUSTIBLE GAS SENSOR
PS	PRESSURE SENSOR
igodol	INDICATES POINT OF DISCONNECTION
Ð	INDICATES POINT OF CONNECTION BETWEEN NEW AND EXISTING
$\langle 1 \rangle$	DEMOLITION KEY NOTE REFERENCE. NUMBER 1 IS THE NOTE NUMBER
1	NEW WORK KEY NOTE REFERENCE. NUMBER 1 IS THE NOTE NUMBER

## **ABBREVIATIONS**

2

AFF	
AMPS	AMPERES
ARCH.	ARCHITECT
ASME	AMERICAN SOCIETY OF MECHANICAL ENGINEERS
В	BOILER
BDS	
BFP	BOILER FEEDWATER PACKAGE
BFW	
BLDG.	BUILDING
во	BLOW OFF
BOD	
BOE	
BOP	BOTTOM OF PIPE
BTU	BRITISH THERMAL UNIT
BTUH	BRITISH THERMAL UNITS PER HOUR
CFH	CUBIC FEET PER HOUR
CFM	CUBIC FEET PER MINUTE
CHF	CHEMICAL FEEDER
CHT	CHEMICAL SOLUTION TANK
CONT.	CONTINUATION
CR	CONDENSATE RETURN
CSD	CONTROLS AND SAFETY DEVICES
CU	CONDENSING UNIT
CU. FT.	CUBIC FEET
CVP	CONDENSATE RETURN VACUUM PUMP
CW	DOMESTIC COLD WATER
D	DRAIN
DB	DRY BULB
DCW	DOMESTIC COLD WATER
DEP	DEPARTMENTS OF ENVIRONMENTAL PROTECTION
DIA.	DIAMETER
DN.	DOWN
DWG(S)	DRAWING(S)
(E)	EXISTING
EA.	EACH
EAT	ENTERING AIR TEMPERATURE
EDR	EQUIVALENCE OF DIRECT RADIATION
EG	EXHAUST GRILLE
ESP	EXTERNAL STATIC PRESSURE
EUH	ELECTRIC UNIT HEATER
EWT	ENTERING WATER TEMPERATURE
°F	DEGREE, FAHRENHEIT
FC	FLEXIBLE CONNECTOR
FL.	FLOOR
FLA	FULL LOAD AMPERES
FM	FACTORY MUTUAL INSURANCE COMPANY
FT	FEET
FT. WG.	FEET OF WATER COLUMN GAUGE
GA	GAUGE
GAL	GALLONS
GE-GAP	
GPH	GALLONS PER HOUR
GPM	GALLONS PER MINUTE
H	HEIGHT
HP	HORSEPOWER

## DEMOLITION NOTES

3

- 1. PRIOR TO STARTING OF DEMOLITION, FIELD VERIFY LOCATION AND SIZES OF ALL EXISTING PIPING THAT SHOULD BE DISCONNECTED, CAPPED, REMOVED OR ABANDONED. INSPECT AREAS IN WHICH WORK WILL BE PERFORMED. NOTE EXISTING CONDITIONS OF STRUCTURE SURFACES, EQUIPMENT, OR SURROUNDING PROPERTY THAT COULD BE MISCONSTRUED AS DAMAGED RESULTING FROM SELECTIVE DEMOLITION WORK; FILE WITH OWNER PRIOR TO STARTING WORK. 2. UNLESS OTHERWISE NOTED OR INDICATED, ALL EXISTING EQUIPMENT, PIPING, DUCTWORK AND ACCESSORIES ARE TO REMAIN.
  - 3. THE OWNER ASSUMES NO RESPONSIBILITY FOR ACTUAL CONDITION OF ITEMS OR STRUCTURES TO BE DEMOLISHED OR REMOVED.

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- 4. THE CONTRACTOR SHALL MAKE CONTINUOUS OBSERVATIONS OF THE EXISTING STRUCTURE DURING THE PERFORMANCE OF THE WORK AND SHALL NOTIFY THE ARCHITECT & ENGINEER OF ANY CRACKS, DEFLECTIONS, ETC. THAT MAY REQUIRE FURTHER INVESTIGATION.
- 5. ALL DEMOLITION ACTIVITIES, CUTTING AND PATCHING REQUIRED IN CONNECTION WITH THE WORK SHALL BE PERFORMED BY MECHANICS OF THE SPECIFIC TRADE INVOLVED AND AS REQUIRED TO EXECUTE EACH LINE OF WORK. ALL PATCHING SHALL BE FINISHED TO MATCH ADJACENT SURFACES EITHER NEW OR EXISTING TO REMAIN.
- 6. CONDUCT DEMOLITION OPERATIONS AND REMOVAL OF DEBRIS TO ENSURE MINIMUM INTERFERENCE WITH WALKS AND OTHER ADJACENT OCCUPIED AND USED FACILITIES.
- 7. PROVIDE BARRICADES, WARNING SIGNS AND LIGHTS AT OPENINGS AND OTHER AREAS HAZARDOUS TO PEDESTRIANS AND TRAFFIC. KEEP CONSTRUCTION DEBRIS CLEAR OF TRAFFIC AREAS.
- 8. ALL WORK PERFORMED SHALL BE IN ACCORDANCE WITH THE REGULATIONS AND GUIDELINES SET FORTH BY ALL AGENCIES HAVING JURISDICTION OVER THE WORK.
- 9. ALL WORK SHALL BE PERFORMED IN ACCORDANCE WITH OCCUPATIONAL SAFETY AND HEALTH ADMINISTRATION (OSHA) RULES AND REGULATIONS.
- 10. THE CONTRACTOR SHALL PROTECT AND PRESERVE ALL EXISTING ITEMS TO REMAIN AND SHALL REPAIR AND/OR REPLACE ANY ITEM DAMAGED DURING THE COURSE OF WORK TO THE SATISFACTION OF THE OWNER AT NO ADDITIONAL COST.
- 11. ALL DEMOLITION MATERIALS AND DEBRIS SHALL BE LEGALLY DISPOSED OF OFF THE OWNER'S PROPERTY AT NO ADDITIONAL COST TO THE OWNER.
- 12. ANY EXISTING CONSTRUCTION THAT IS TO REMAIN IN PLACE IF DAMAGED DURING PERFORMANCE OF WORK UNDER THIS CONTRACT SHALL BE RESTORED TO ITS ORIGINAL CONDITION TO THE SATISFACTION OF THE OWNER AND AT THE CONTRACTOR'S SOLE EXPENSE.
- 13. THE CONTRACTOR SHALL BE RESPONSIBLE FOR THE LOCALIZED DEMO / CORING OF EXISTING MASONRY WALLS, CONCRETE FLOORS, AND PLASTER CEILINGS FOR THE INSTALLATION OF ALL INFRASTRUCTURE, INCLUDING BUT NOT LIMITED TO, DUCTWORK, PIPING, EQUIPMENT, CONDUITS FOR CONTROLS, ETC.

HR	HOUR
HZ	HERTZ
ID	INSIDE DIAMETER
I.R.I.	IMPROVED RISK INSURERS
IN.	INCHES
IN. WG.	INCHES OF WATER COLUMN GAUGE
KW	KILOWATT
L	LENGTH
LBS	POUNDS
LWCO	LOW WATER CUTOFF
LWT	LEAVING WATER TEMPERATURE
MAX.	MAXIMUM
MBH	THOUSAND BTU PER HOUR
MCA	MINIMUM CIRCUIT AMPERES
MEP	MANUFACTURING EXTENSION PARTNERSHIP
MIN.	MINIMUM
NEMA	NATIONAL ELECTRICAL MANUFACTURER ASSOCIATION
NFPA	NATIONAL FIRE PROTECTION ASSOCIATION
N.I.C.	NOT IN CONTRACT
NPW	NON-POTABLE WATER
NTS	NOT TO SCALE
NYC	NEW YORK CITY
OD	OUTSIDE DIAMETER
OSHA	OCCUPATIONAL SAFETY AND HEALTH ADMINISTRATION
PH	PHASE
POC	PROOF OF CLOSURE
PPM	PARTS PER MILLION
PSI	POUNDS PER SQUARE INCH
PSIG	POUNDS PER SQUARE INCH, GAUGE
PVC	POLYVINYL CHLORIDE
QTY	QUANTITY
R	CAST IRON RADIATOR
RM.	ROOM
RPM	REVOLUTIONS PER MINUTE
SF	SUPPLY FAN
SQ. FT.	SQUARE FEET
т	STEAM TRAP
TEFC	TOTALLY ENCLOSED, FAN-COOLED
TYP.	TYPICAL
UH	UNIT HEATER
UL	UNDERWRITERS' LABORATORIES
V	VOLT
W	WIDTH
W/	WITH

Ν	0	Τ	ES

1. ALL WORK, MATERIALS AND WORKMANSHIP SHALL BE PERFORMED IN STRICT ACCORDANCE WITH, AND SHALL CONFORM WITH ALL FEDERAL, STATE AND LOCAL CODES, ORDINANCES, RULES AND REGULATIONS, SPECIFICATIONS AND RECOMMENDED PRACTICES OF THE MANUFACTURERS AND THE APPROPRIATE APPLICABLE STANDARDS. WHERE SUCH CODES, RULES AND REGULATIONS ARE AT VARIANCE WITH THE PLANS AND NOTES, SAID CODES, RULES AND REGULATIONS, ETC. SHALL TAKE PRECEDENCE OVER THE PLANS AND NOTES.

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- 2. THE CONTRACTOR SHALL COMPLY WITH ALL APPLICABLE BUILDING CODES AND REGULATIONS AND SHALL PAY FOR AND OBTAIN ALL NECESSARY AND REQUIRED INSPECTIONS, APPROVALS AND PERMITS, NECESSARY TO PERFORM ALL WORK AND SERVICES HEREIN NOTED OR INDICATED ON THE DRAWINGS.
- 3. THE CONTRACTOR SHALL FULLY INFORM HIMSELF OF THE CONDITIONS RELATING TO THE CONSTRUCTION AND LABOR UNDER WHICH THE WORK WILL BE PERFORMED AND COMPARE THE DRAWINGS AND SPECIFICATIONS WITH THE WORK IN PLACE. FAILURE TO DO SO WILL NOT RELIEVE THE CONTRACTOR OF HIS OBLIGATION TO FURNISH ALL LABOR AND MATERIALS NECESSARY TO CARRY OUT THE PROVISIONS OF THE CONTRACT DOCUMENTS AND TO COMPLETE THE CONTEMPLATED WORK FOR THE CONSIDERATION SET FORTH IN HIS BID. CONTRACTOR, IN THE CARRYING OUT OF HIS WORK, SHALL EMPLOY SUCH METHODS OR MEANS THAT WILL NOT CAUSE ANY INTERRUPTIONS OR INTERFERENCE WITHIN THE WORK OF ANY OTHER.
- 4. THE CONTRACTOR SHALL VERIFY ALL DIMENSIONS AND PROPOSED PIPE CONNECTIONS AT THE JOB SITE AND SHALL REPORT ANY DISCREPANCIES TO THE ENGINEER PRIOR TO STARTING CONSTRUCTION. COMMENCEMENT OF THE WORK BY THE CONTRACTOR SHALL IMPLY HIS ACCEPTANCE OF ALL CONDITIONS.
- 5. MINOR DETAILS NOT USUALLY SHOWN OR SPECIFIED BUT NECESSARY FOR PROPER CONSTRUCTION OF ANY PART OF THE WORK SHALL BE INCLUDED AS IF THEY WERE INDICATED ON THE DRAWINGS.
- 6. DUE TO THE SMALL SCALE OF THE DRAWINGS THE PIPING SHOWN IS DIAGRAMMATIC. THE CONTRACTOR SHALL PROVIDE ALL NECESSARY OFFSETS TO AVOID CONFLICTS WITH STRUCTURAL ELEMENTS, LIGHTING FIXTURES, PLUMBING, ETC.
- 7. ALL WORK SHALL BE EXECUTED IN A CAREFUL AND ORDERLY MANNER WITH THE LEAST POSSIBLE NOISE, DUST, OR DISTURBANCE TO OCCUPANTS IN ADJACENT SITES OR BUILDINGS.
- 8. THE CONTRACTOR SHALL PROVIDE PROTECTION FOR THE GENERAL PUBLIC AND CONSTRUCTION WORKERS IN AND AROUND THE CONSTRUCTION SITE.
- 9. THE CONSTRUCTION AREA SHALL BE THOROUGHLY CLEANED PRIOR, DURING AND AFTER THE CONSTRUCTION.
- 10. SUBMITTALS SHALL BE IN COMPLIANCE WITH CONTRACT REQUIREMENTS AND ACTUAL FIELD CONDITIONS.
- 11. DETAILS ON THE DRAWINGS ARE SHOWN AT SPECIFIC LOCATIONS AND ARE INTENDED TO SHOW GENERAL REQUIREMENTS THROUGHOUT. DETAILS NOTED "TYP." IMPLY ALL CONDITIONS TREATED SIMILARLY.
- 12 THE CONTRACTOR SHALL FIRE STOP ALL PENETRATIONS AND ALL FIRE RATED WALL ASSEMBLIES.
- 13. THE CONTRACTOR SHALL COORDINATE PLACEMENT OF ALL DUCTWORK AND WATER PIPING (HVAC, HOT WATER, ETC.) WITH ELECTRICAL COMPONENTS.
- A. IN NO CIRCUMSTANCE SHALL WATER PIPING BE RUN OVER TOP OF OR WITHIN THREE FEET LATERALLY FROM ELECTRICAL PANELS, TRANSFORMERS, SWITCHES, DISCONNECTS AND SIMILAR DEVICES. USE OF DRIP PANS AS AN ALTERNATIVE IS NOT ACCEPTABLE PRACTICE.
- B. NO PIPING, DUCTS, LEAK PROTECTION APPARATUS, OR OTHER EQUIPMENT FOREIGN TO THE ELECTRICAL INSTALLATION SHALL BE LOCATED IN THE DEDICATED ELECTRICAL SPACE WHICH IS EQUAL TO THE WIDTH AND DEPTH OF THE ELECTRICAL EQUIPMENT AND EXTENDING FROM THE FLOOR TO A HEIGHT OF 6 FEET ABOVE THE EQUIPMENT OR TO THE STRUCTURAL CEILING, WHICHEVER IS LOWER.
- C. NO PIPING, CONDUIT OR STRUCTURAL WORK SHALL BE INSTALLED IN OR THROUGH ANY DUCTWORK.
- 14. PROVIDE TAGS FOR ALL EQUIPMENT, CONTROLS, ETC.
- 15. WHEN PIPES, DUCTS AND OTHER HANGING ITEMS ARE SUPPORTED FROM THE STRUCTURAL ELEMENTS, THE CONTRACTOR SHALL PROVIDE THE MISCELLANEOUS STEEL NECESSARY TO SUPPORT PIPING, DUCTWORK AND MECHANICAL EQUIPMENT.
- 17. THE CONTRACTOR SHALL PROVIDE ALL NECESSARY SCAFFOLDS AND TEMPORARY PLATFORMS AS REQUIRED TO PERFORM ALL WORK.

ALTERATIONS TO TREASURY MOTOR POOL

Department of Community Affairs Construction Project Review Project No: 9053-24 Project No. partial release mechanical Thomas Williams Veased: 05/24/24

Released: 05/24/24 N.J.S.A. 52:27D-119 ET SEQ., AS AMENDED

	Location
	IDE STATE PRISON 4342 NJ-47 /AURICE RIVER, NJ
	DPMC Number
	A1397-00
	Project Number
	20520.11
	Date
	11/03/2023
	Architect
LAMMEY + GIORGIO	Lammey + Giorgio Architecture + Design 215 Highland Ave, Suite B Haddon Twp, NJ, 08108 p.856.833.0010

Μ Μ MOTT MACDONALD

> 111 Wood Ave South Iselin, NJ 08830-4112 973.379.3400 | mottmac.com




#	Issue/Revision	Date
1	DESIGN DEVELOPMENT	09/07/2023
2	FINAL DESIGN	11/03/2023
3	BUILDING DATA UPDATE	//2024
4	TRAILER	03/27/2024
	SI	neet Title

MECHANICAL SYMBOLS, LEGEND AND ABBREVIATIONS



Sheet 6 of 26 ©Lammey + Giorgio 2023

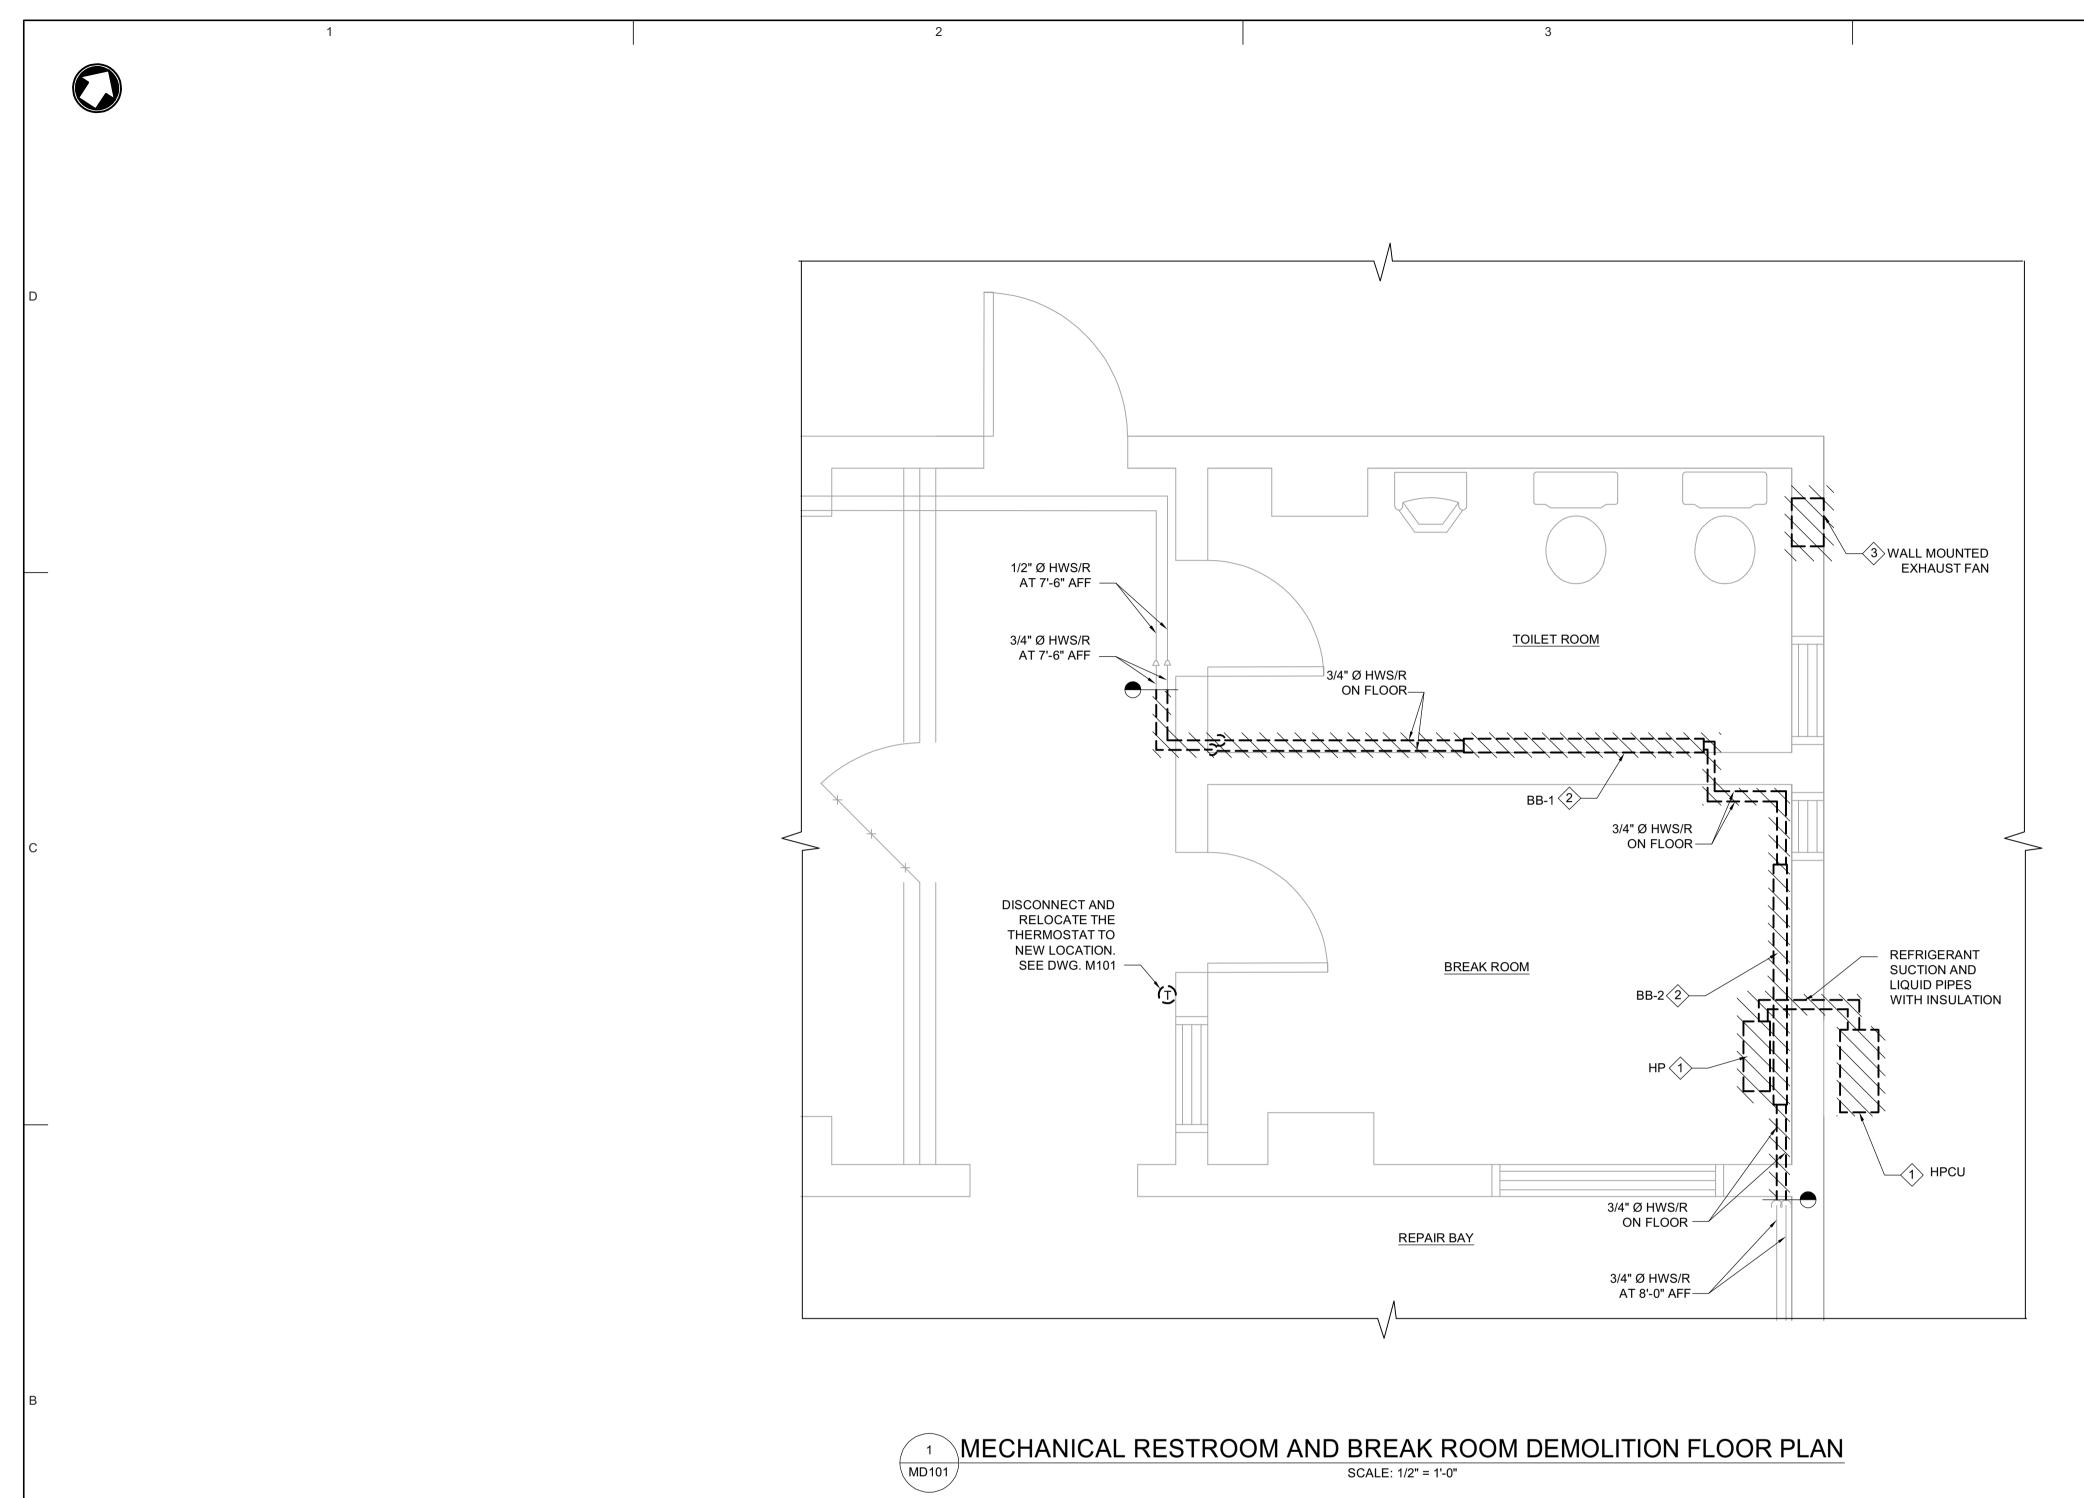



## DEMOLITION KEY NOTES

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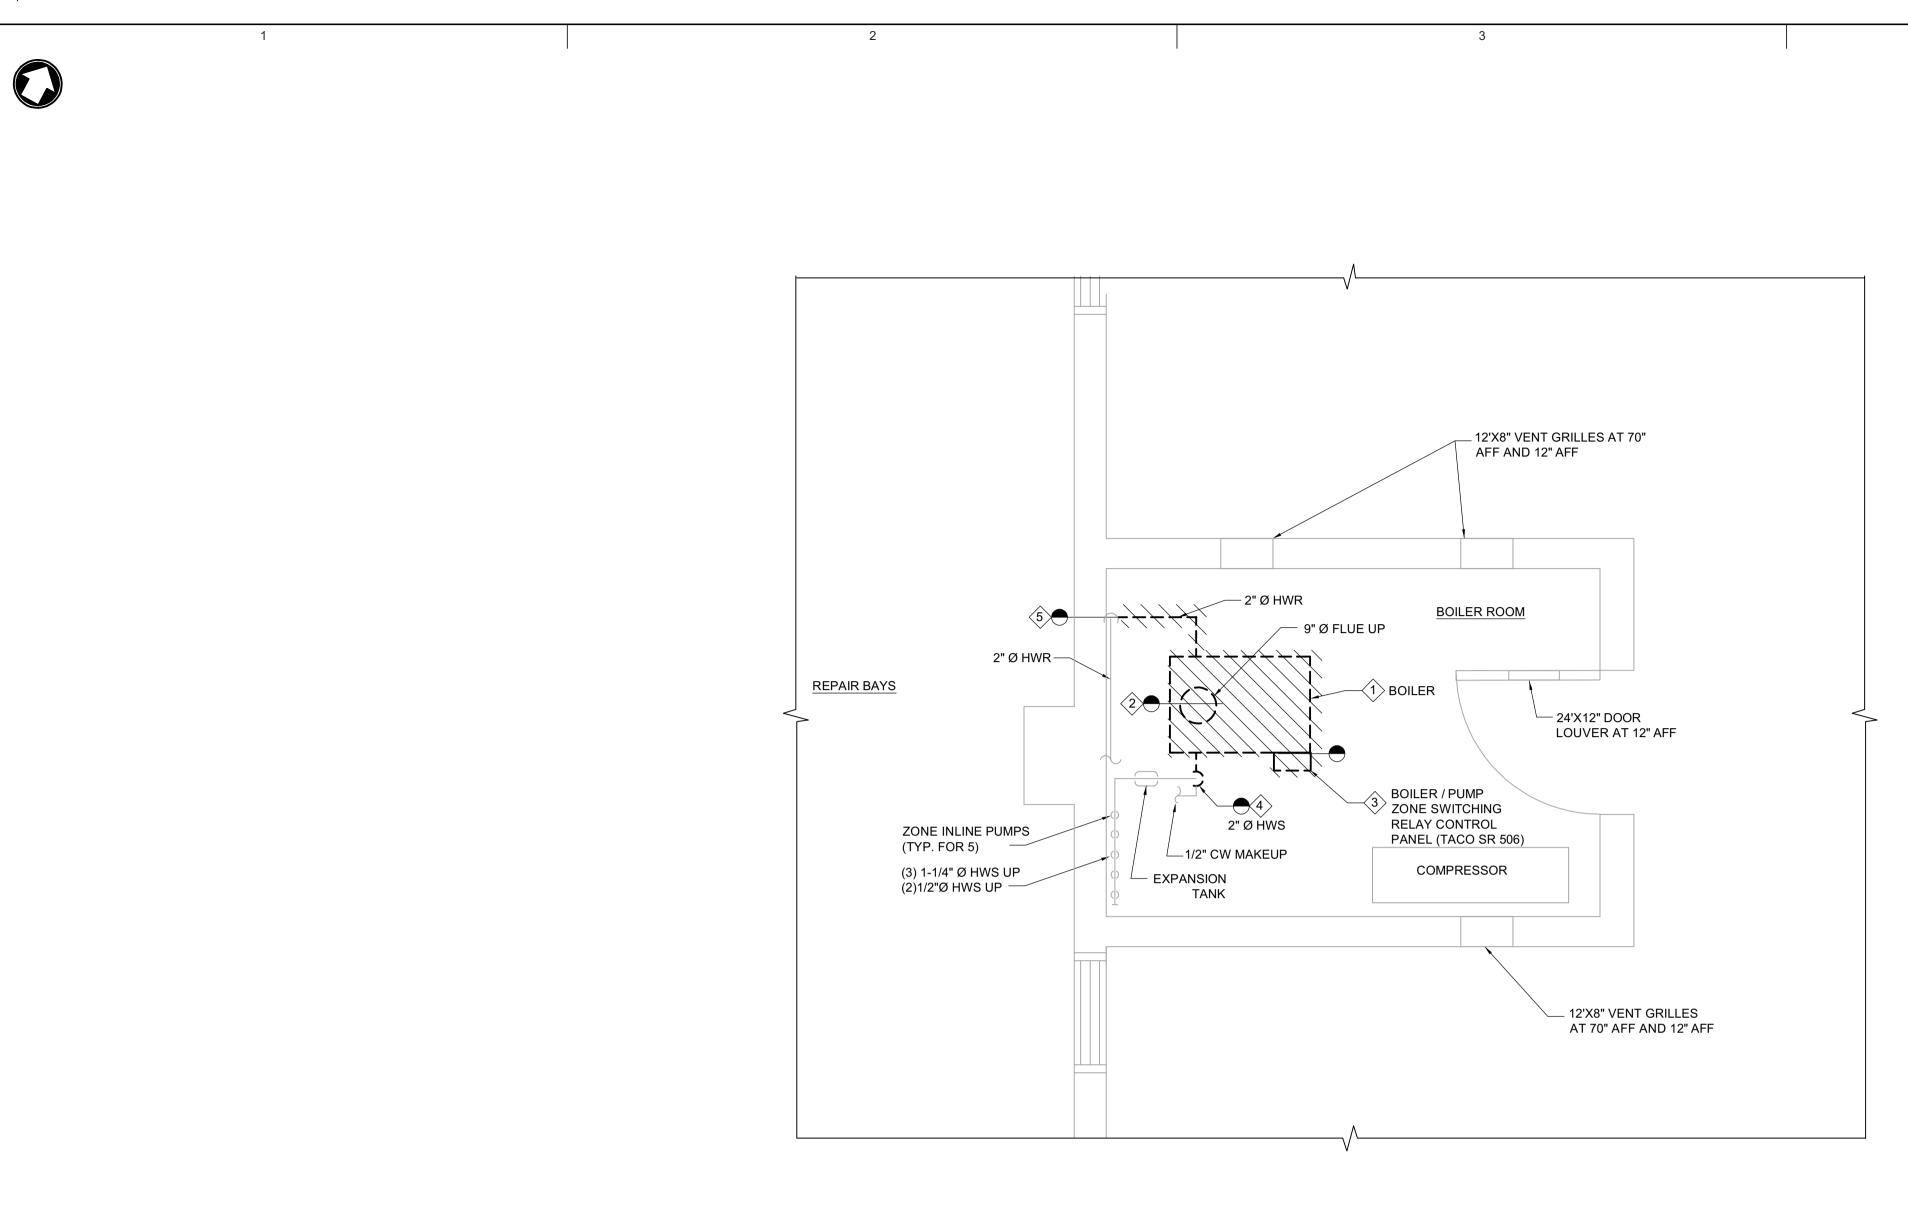
- TEMPORARY DISCONNECT AND RELOCATE INDOOR EVAPORATOR AND OUTDOOR CONDENSING UNITS FROM ELECTRIC POWER, REFRIGERANT PIPING, PIPES THERMAL INSULATION, CONTROLS AND SUPPORTS. THE UNITS AND ACCESSORIES SHALL BE STORED AND PRESERVED. SEE DWG. M101A FOR NEW WORK. ALL WORK WITH HANDLING OF THE REFRIGERANT SHALL BE IN COMPLIANCE WITH EPA REGULATIONS, SECTION 608-THE CLEAN AIR ACT. SEE ELECTRICAL DRAWINGS FOR ALL ELECTRICAL WORK
- 2 DISCONNECT AND REMOVE BASEBOARD WITH ASSOCIATED ACCESSORIES, THERMAL INSULATION AND SUPPORT.
- 3 DISCONNECT AND REMOVE EXHAUST FAN WITH ASSOCIATED DUCTWORK, WIRING, CONDUITS, CONTROLS, AND SUPPORT.




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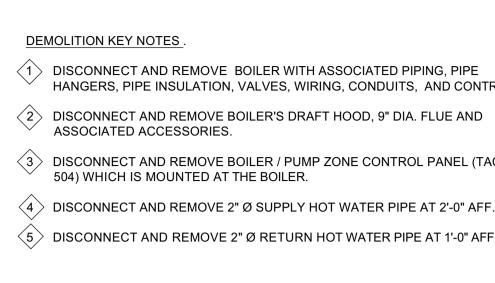
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Β	ALTERATIONS TO TREASURY MOTOR POOL <b>Location</b> BAYSIDE STATE PRISON 4342 NJ-47 MAURICE RIVER, NJ DPMC Number A1397-00 Project Number 20520.11 Date 11/03/2023
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A KEY PLAN NTS	#Issue/RevisionDate1DESIGN DEVELOPMENT09/07/20232FINAL DESIGN11/03/20233BUILDING DATA UPDATE-/-/20244TRALER03/27/20246TRALER03/27/2024Breat TrainingSheat TrainingDESTINATION OF TRANSDESTINATION OF TRANS

Department of Community Affairs Construction Project Review Project No: 9053-24 partial release mechanical Thomas Williams Released: 05/24/24 N.J.S.A. 52:27D-119 ET SEQ., AS AMENDED



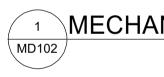

## 1 MECHANICAL BOILER ROOM DEMOLITION FLOOR PLAN MD102 SCALE: 1/2" = 1'-0"



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	ALTERATIONS TO TREASURY
	MOTOR POOL
	BAYSIDE STATE PRISON 4342 NJ-47 MAURICE RIVER, NJ
	DPMC Number A1397-00
В	Project Number 20520.11 Date
	11/03/2023 Architect LAMMEY + GIORGIO 215 Highland Ave, Suite B Haddon Twp, NJ, 08108 p.856.833.0010
	M M MOTT MACDONALD
	111 Wood Ave South Iselin, NJ 08830-4112 973.379.3400   mottmac.com
	DocuSigned by: DocuSigned by: Jack ( Wang E2EFDAEF26BF413
AREA OFAWORK	#         Issue/Revision         Date           1         DESIGN DEVELOPMENT         09/07/2023           2         FINAL DESIGN         11/03/2023           3         BUILDING DATA UPDATE        //2024           4         TRAILER         03/27/2024           Sheet Title
KEY PLAN	MECHANICAL BOILER ROOM DEMOLITION FLOOR PLAN
NTS	Sheet No. MD102 Sheet 8 of 26
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Department of Community Affairs Construction Project Review Project No: 9053-24 partial release mechanical Thomas Williams Released: 05/24/24 N.J.S.A. 52:27D-119 ET SEQ., AS AMENDED


DISCONNECT AND REMOVE BOILER WITH ASSOCIATED PIPING, PIPE HANGERS, PIPE INSULATION, VALVES, WIRING, CONDUITS, AND CONTROLS.


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DISCONNECT AND REMOVE BOILER / PUMP ZONE CONTROL PANEL (TACO SR 504) WHICH IS MOUNTED AT THE BOILER.

4 DISCONNECT AND REMOVE 2" Ø SUPPLY HOT WATER PIPE AT 2'-0" AFF.

 $\langle 5 \rangle$  DISCONNECT AND REMOVE 2" Ø RETURN HOT WATER PIPE AT 1'-0" AFF.



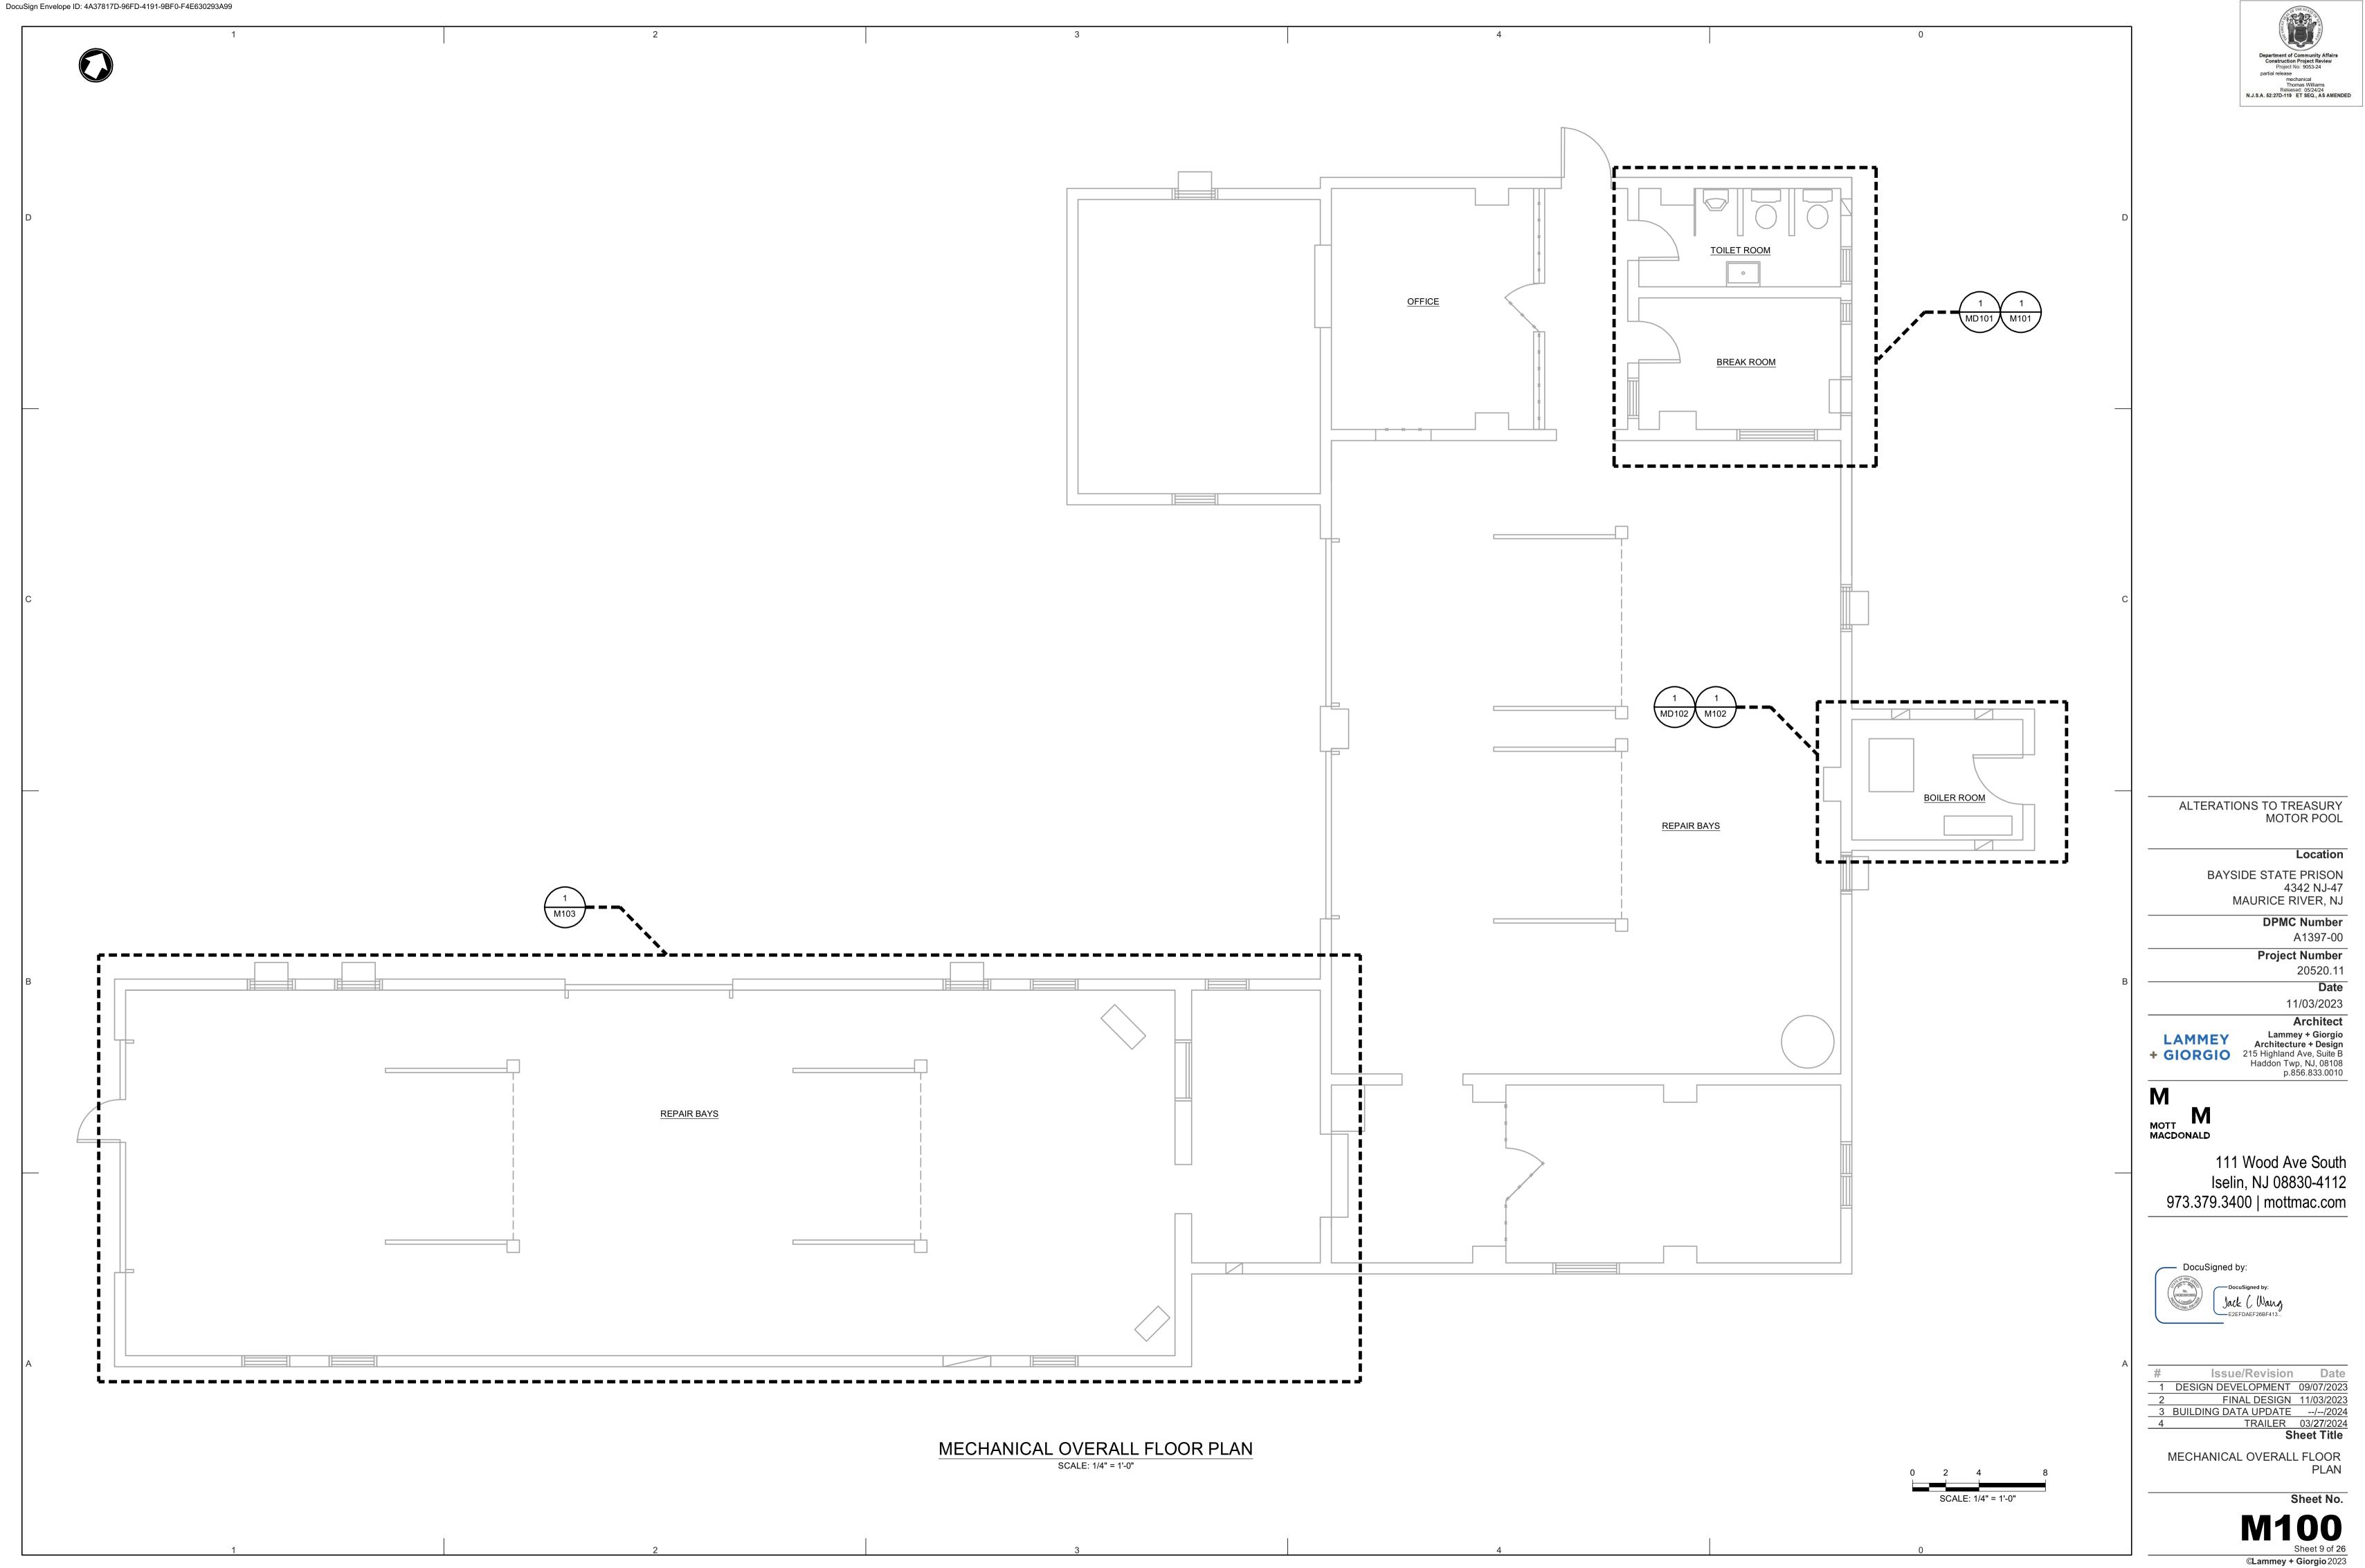

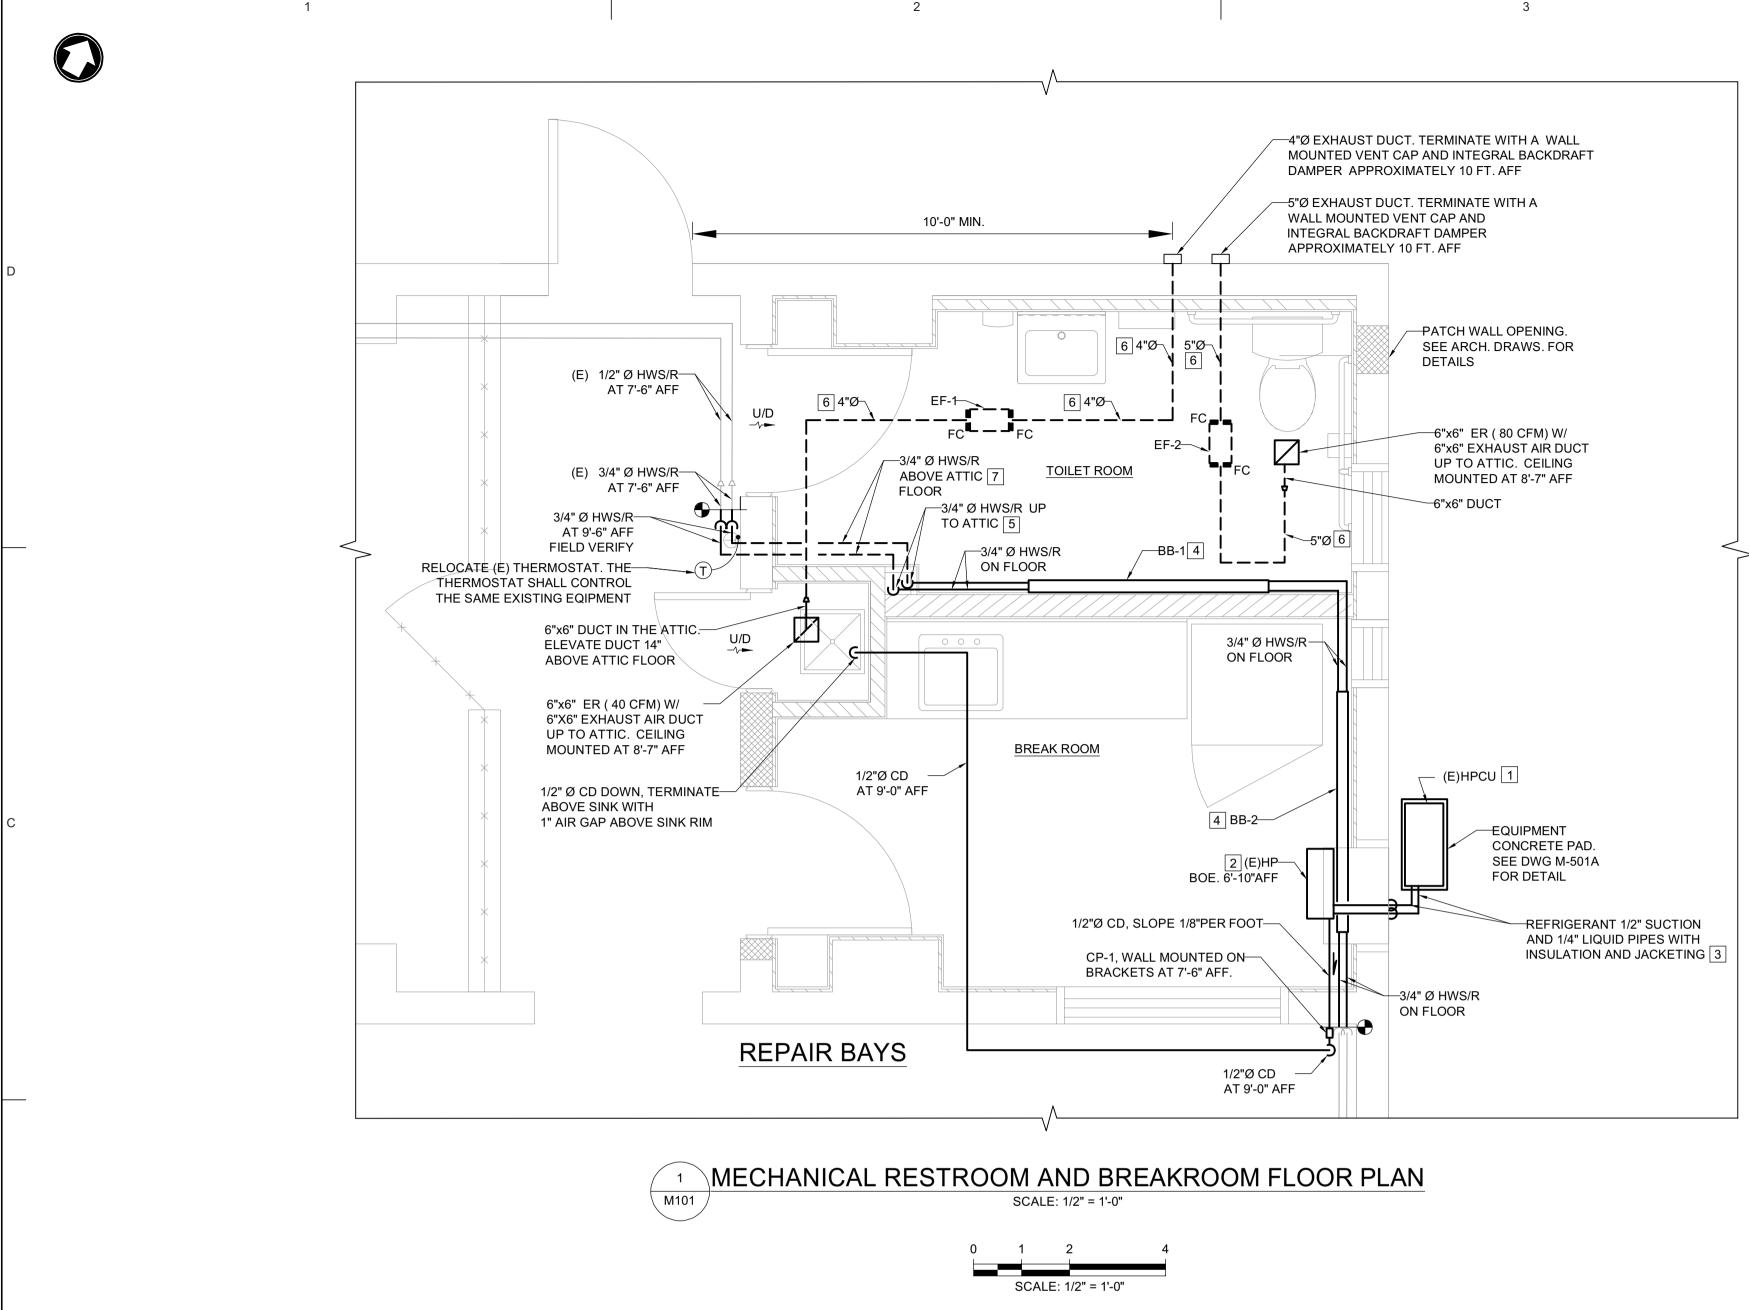	BASEBOARD SCHEDULE				_							BASIS OF D	ESIGN "SIGN
TAG	LOCATION	CAPACITY	EAT	AVERAGE EWT °E	WATER FLOW	HEATING ELEMENT LENGTH	TUBE SIZE	FIN SIZE	TIERS	FIN PER FT.	ENCLOSURE DEPTH	HEIGHT OF PANEL	MODEL
BB-1	TOILET ROOM	BTUH 6080	°F 65.0	°⊢ 170.0	GPM 0.5	FT. 5.0	IN. 3/4	IN. 4 X 4	IN. 1	48	IN. 5 1/4	IN. 12	SWE-S
BB-2	BREAK ROOM	6080	65.0	170.0	0.5	5.0	3/4	4 X 4	1	48	5 1/4	12	SWE-S

PROVIDE: - WALL-TO-WALL BASEBOARD ENCLOSURES W/TRIMS, CORNER AND END CAPS - SLOPE TOP ENCLOSURES

			MOTOR										
NOTES	WEIGHT LBS	V/PH/Hz	w	RPM	FAN RPM	ESP IN. WC.	AIR FLOW CFM	DRIVE	FAN TYPE	MODEL NO.	AREA SERVED	LOCATION	TAG
1-6	3.9	120/1/60	36	2,472	2,212	0.300	80	DIRECT	INLINE TURBO TUBE	TT-125	JANITOR CLOSET	ATTIC	EF-1
1-6	3.7	120/1/60	38	2,584	2,024	0.375	40	DIRECT	INLINE TURBO TUBE	TT-100	TOILET RM	ATTIC	EF-2
												NOTES:	
								ORS	4. FLEXIBLE CONNECT		CH NEMA 12	1. DISCONNECT SWIT	
							I	PROTECTION	5. POWER OVERLOAD		ER IN DUCT	2. BACKDRAFT DAMP	:
									6. POWER CORD		AP W/ BIRD SCREAN	3. ALUMINUM WALL C	

CONDENSATE PUMP SCHEDULE WATER TOTAL DISCHARGE TAG LOCATION CHECK TANK SIZE FLOW HEAD VALVE CAPACITY FT GPH IN IN GAL RPM CP-1 REPAIR BAY 60 10 3/8 3/8 0.5 1800 1 PROVIDE: - NEMA 12 DISCONNECT SWITCH - THERMAL PROTECTED, FAN COOLE - OVERFLOW DETECTION SWITCH - MAXIMUM WATER TEMPERATURE : - AUTOMATIC START AND STOP OPERATIONS - FIELD PROVIDED WALL BRACKETS - CHECK VALVES

## KEY NOTES

PROVIDE A CONCRETE EQUIPMENT PAD. REINSTALL (E) OUT THE CONCRETE EQUIPMENT PAD. SEE DWG. M501, CONCRET

4

- 2 REINSTALL (E) INDOOR EVAPORATOR ON THE WALL AT 6'-10 PIPING, ELECTRICAL POWER CONNECTION AND CONTROLS. CP-1 AS SHOWN IN THE DRAWING.
- 3 PROVIDE NEW REFRIGERANT PIPES 1/2"Ø SUCTION LINE AND TO MATCH EXISTING REFRIGERANT PIPE SIZES. PROVIDE NE THE AIR CONDITNING SPLIT SYSTEM UNIT AS REQUIRED.
- 4 PROVIDE BASEBOARD WITH ASSOCIATED ACCESSORIES ANI FOR THE BASEBOARD PIPING DETAIL.
- 5 PROVIDE THERMAL INSULATION AND JACKETING FOR VERTIC LOCATED INSIDE THE WALL PARTITION.
- 6 PROVIDE ROUND DUCT 14" ABOVE ATTIC FLOOR .
- 7 PROTECT PIPES WITH STEEL COVER MADE OUT OF 16 GA GA 3" HEIGHT BY 3" WIDE AND SECURED TO THE ATTIC'S FLOOR.

		NG UNIT ON UNIT DETAIL.					
0" AFF. ( 6. PROVI	CONNECT F	REFRIGERANT NSATE PUMP					
D 1/4"Ø I EW REFI	LIQUID LINE RIGERANT	E. FIELD VERIFY AND REFILL					
ND SUPP	PORTS. SEE	E DWG M-501					
ICAL 3/4'	"Ø HWS/R F	PIPES RISERS					
ALVANIZ R.	ED STEEL,						
							_
							_
				-			
OTOR		BASIS OF D	ESIGN "LITTLE GIAN	<u>17"</u>			
		OPERATING WEIGHT	MODEL				
/PH/HZ 15/1/60	HP 1/30	LBS 5.5	VCCA-20ULS				
D МОТО 140 F	RS						
FOR PUN	MP SUPPOF	RT					-
					AREA OF WO	RК — _	
		C					
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# Department of Community Affairs Construction Project Review Project No: 9053-24 partial release mechanical Thomas Williams Released: 05/24/24 N.J.S.A. 52:27D-119 ET SEQ., AS AMENDED

ALTERATIONS TO TREASURY MOTOR POOL


	Location
BAYS	SIDE STATE PRISON
	4342 NJ-47
n	MAURICE RIVER, NJ
	DPMC Number
	A1397-00
	Project Number
	20520.11
	Date
	11/03/2023
	Architect
LAMMEY + GIORGIO	Lammey + Giorgio Architecture + Design 215 Highland Ave, Suite B Haddon Twp, NJ, 08108 p.856.833.0010
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# Issue/Revision Date
1 DESIGN DEVELOPMENT 09/07/2023
2 FINAL DESIGN 11/03/2023
3 BUILDING DATA UPDATE//2024
4 TRAILER 03/27/2024
Sheet Title
MECHANICAL RESTROOM AND
BREAK ROOM FLOOR PLAN AND
EQUIPMENT SCHEDULES
·
Sheet No.
M101

Sheet 10 of 26

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### MECHANICAL BOILER ROOM FLOOR PLAN 1 M102 SCALE: 1/2" = 1'-0"

SCALE: 1/2" = 1'-0"

2

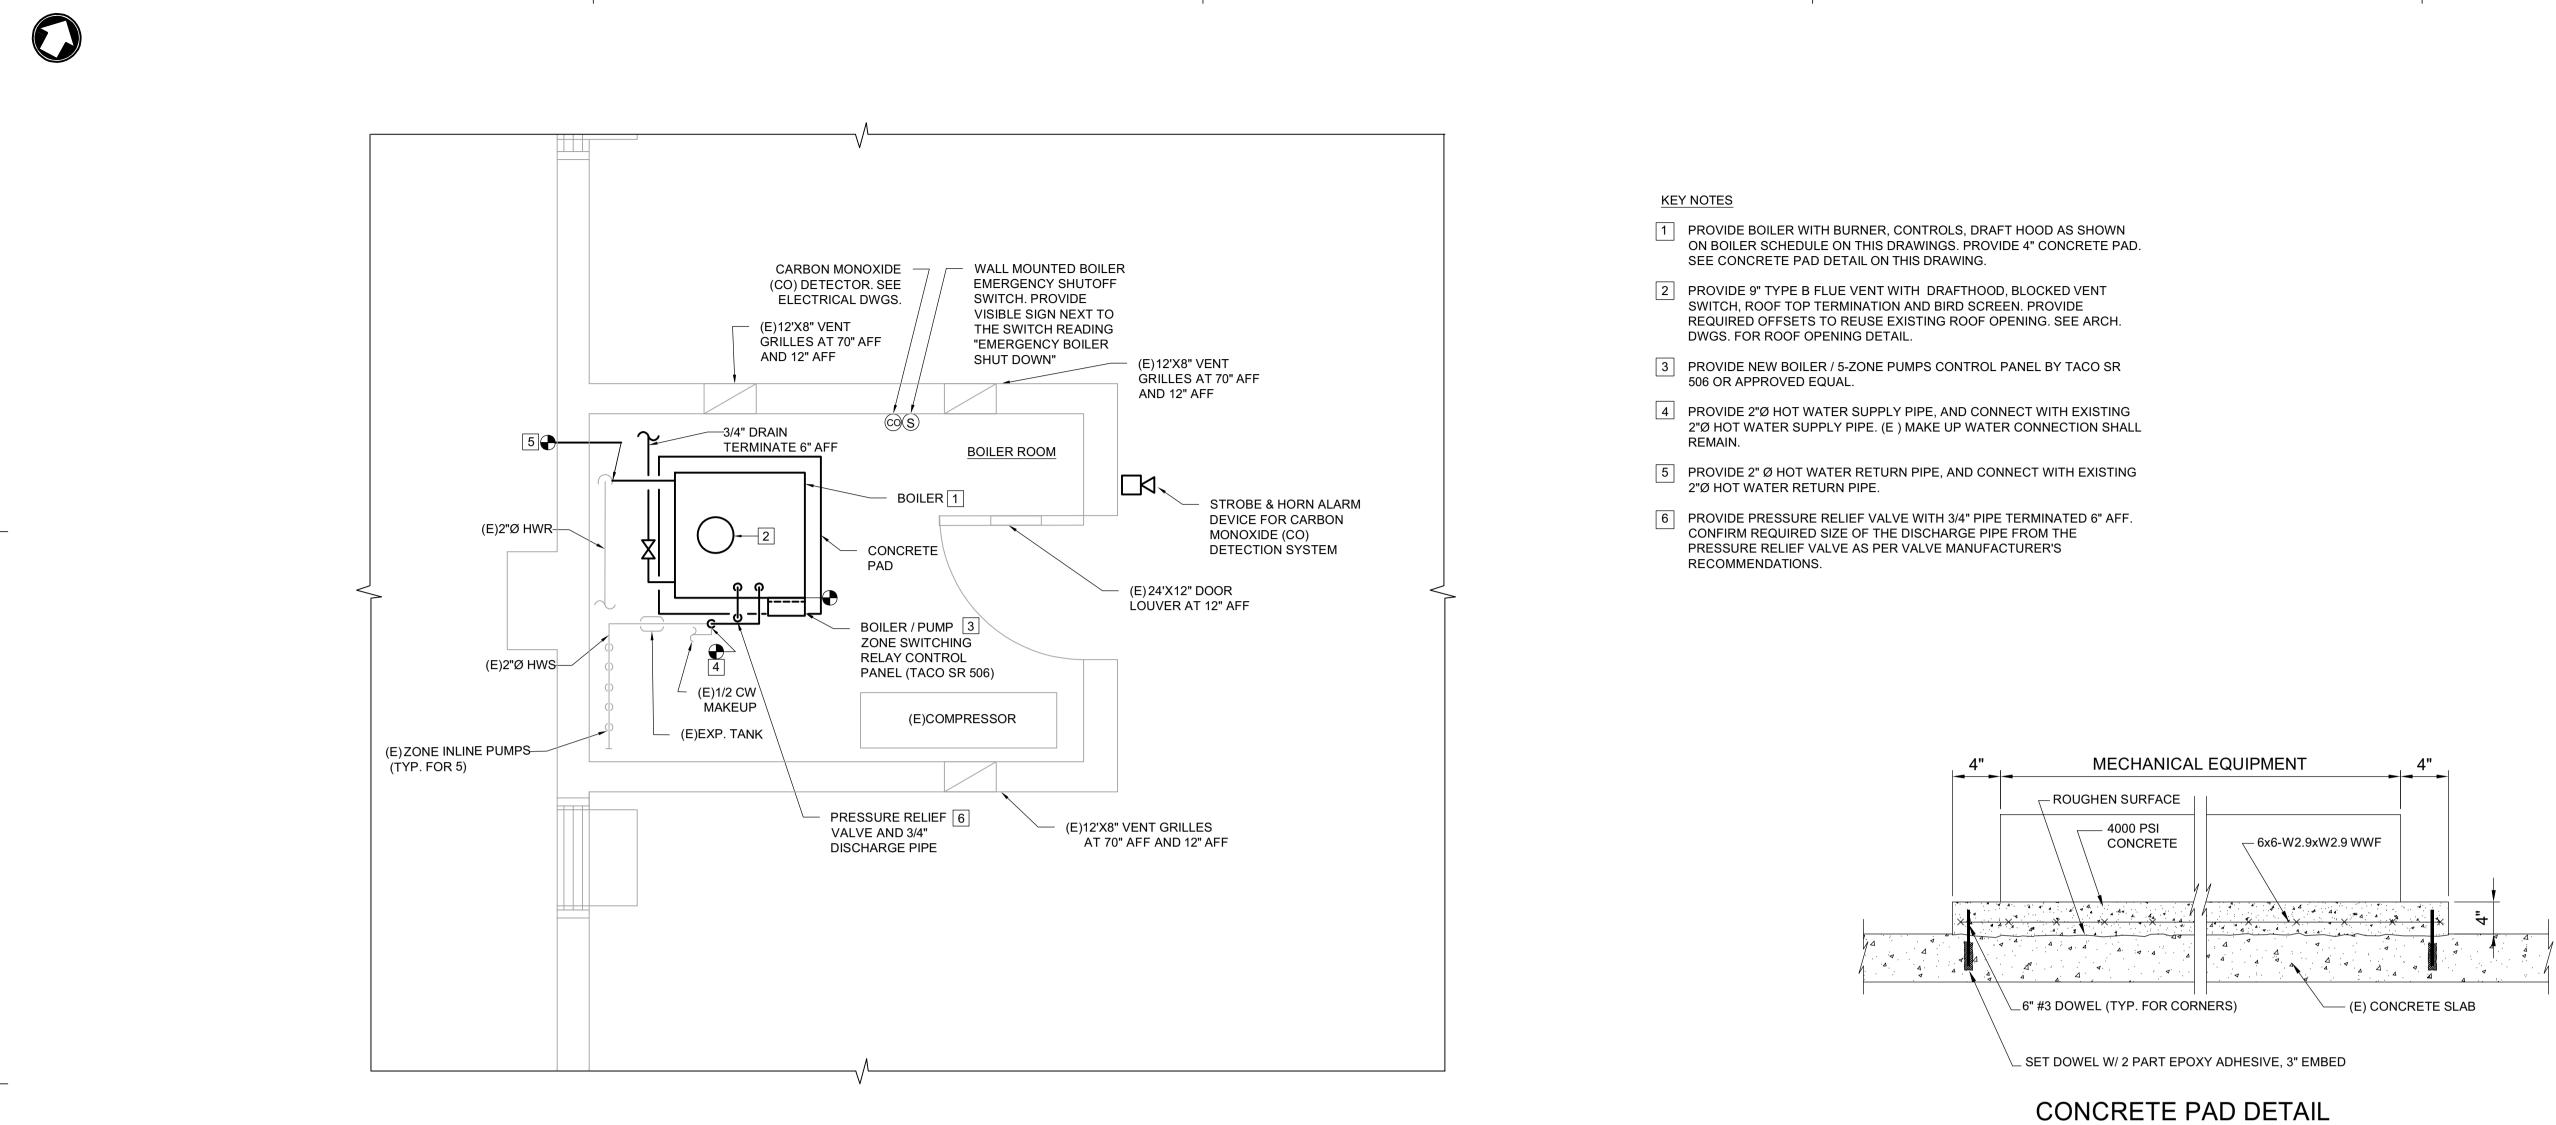	GAS-FIRED H	OT WATER BOI	LER SCHEDULE	1	1	1			1		1		1	1			BASIS OF DESI	GN "BURNHA
TAG	LOCATION	SERVICE	BOILER TYPE	GROSS INPUT	NET OUTPUT	EWT	LWT	TYPE OF	GAS INPUT	MIN. / MAX. GAS PRESSURE	AHRI EFFICIENCY	FLUE CONNECTION					OPERATING	MODEL
				МВН	МВН	°F	°F	GAS	CFH	IN. WC.	%	IN.	RATING PSIG	WATER FLOW GPM	FLA AMPS	V/PH/HZ	LBS	
B-1	BOILER ROOM	HEATING SYSTEM	CAST IRON, SECTIONAL	410	328	160	180	NATURAL GAS	410	6 / 14	80.1	9	50	41	5	120/1/60	1,000	808HE
PROVIDE:	ROVIDE: - ASME RELIEF VALVE, 30 PSI - TYPE B, DOUBLE WALL METAL FLUE - TOP MOUNTED DRAFTHOOD BY BOILER MANUFACTURER - 100% SHUTOFF GAS CONTROLS - STAINLESS STEEL FLUE BAFFLES					ΑСКЕТ V	E / TEMI VITH 3" I NIC, DIR	WITCH PERATURE GAUGE NSULATION ECT SPARK IGNITION										

NOT TO SCALE

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No.
Department of Community Affairs
Construction Project Review
Project No: 9053-24
partial release
mechanical
Thomas Williams
Released: 05/24/24
 A. 52:27D-119 ET SEQ., AS AMENDED


### ALTERATIONS TO TREASURY MOTOR POOL

	Location
BAYS	DE STATE PRISON
	4342 NJ-47
Ν	MAURICE RIVER, NJ
	DPMC Number
	A1397-00
	Project Number
	20520.11
	Date
	11/03/2023
	Architect
LAMMEY	Lammey + Giorgio
+ GIORGIO	Architecture + Design 215 Highland Ave, Suite B
	Haddon Twp, NJ, 08108 p.856.833.0010
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## MOTT MACDONALD 111 Wood Ave South


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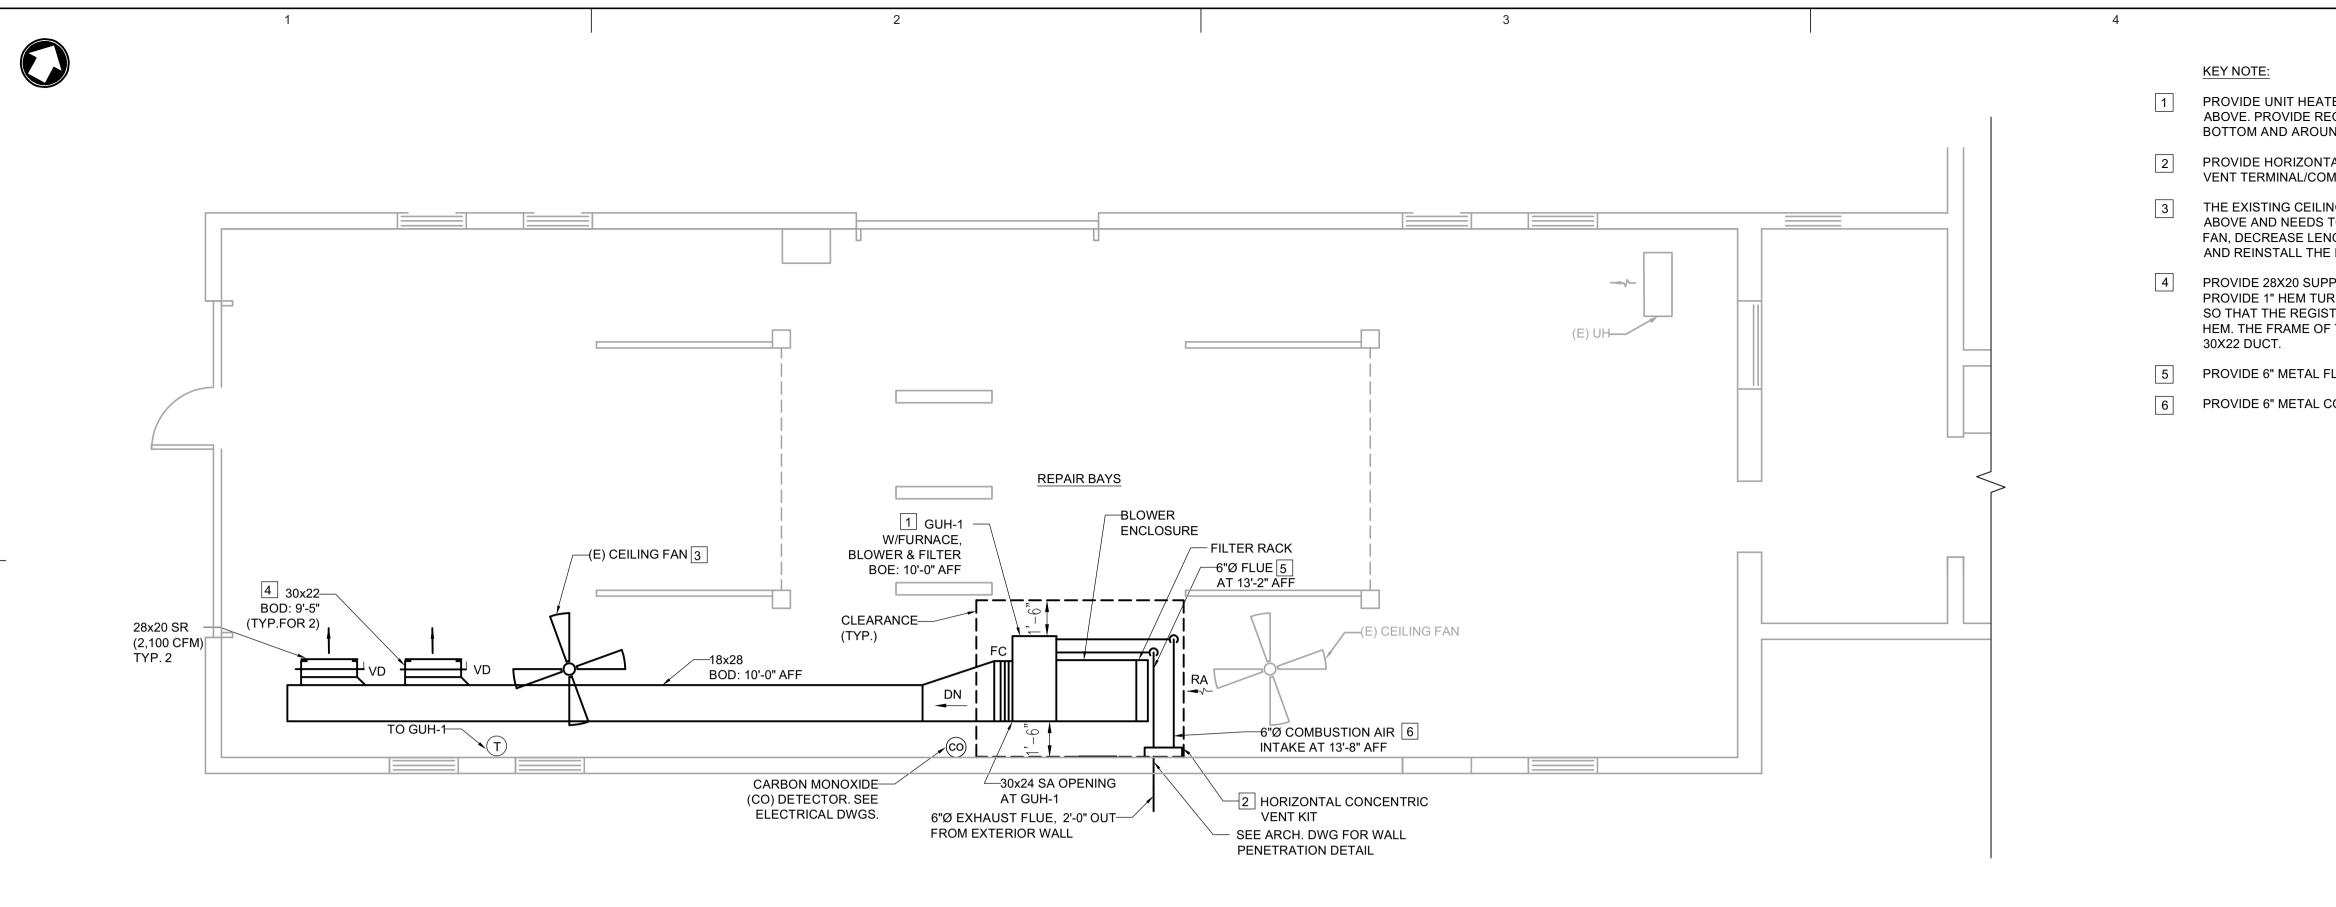





MECHANICAL BOILER ROOM FLOOR PLAN DETAIL AND EQUIPMENT SCHEDULE Sheet No.

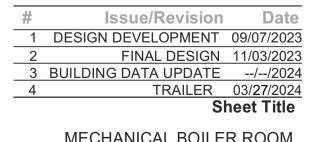





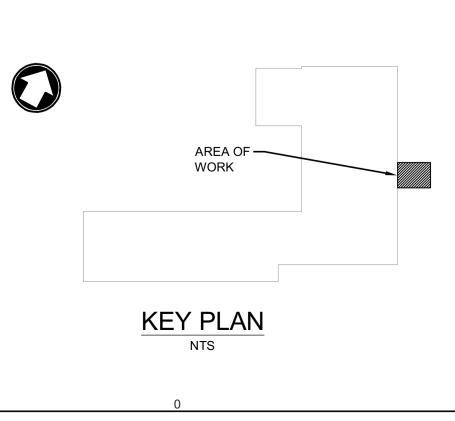

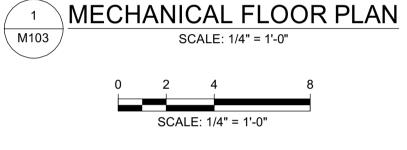


				HEATING SECTION										' FAN	FAN MOTOR				
TAG	AREA	TOTAL					OPERATING					AIR							
	SERVED	AIR FLOW	INPUT	OUTPUT	VENT OUTLET	COMBUSTION INLET	GAS PRESSURE MIN / MAX	THERMAL EFFICIENCY	EAT	LAT	GAS TYPE	TEMPERATURE RISE	TOTAL STATIC PRESSURE	ESP	RPM	V/PH/HZ	MOTOR	WEIGHT	MODEL
		CFM	МВН	MBH	INCH	INCH	IN. WG.	%	F	F		F	IN. WC	IN. WC			HP	LBS	
GUH-1	REPAIR BAYS	4,200	250	205	6	6	6/7	82	65	110	NATURAL	45	0.634	0.5	1,725	208/3/60	2	360	BTX250SS4112NBA
											THE COMBUSTION AIR AND VENT PIPES MUST BE SINGLE WALL STAINLESS STEEL MATERIAL, EXCEPT FOR THE AST SECTION OF VENT PIPE, WHICH MUST BE ONE CONTINUOUS LENGTH OF DOUBLE WALL B-VENT EXTENDED								
3. HORIZONTAL CONCENTRIC VENT KIT W/ CONCENTRIC ADAPTOR						R	7. TEFC FAN MOTOR THRO						THROUGH THE CONCENTRIC VENT BOX AND COMBUSTION AIR INLET PIPE ON THE CONCENTRIC SIDE OF TH						NTRIC SIDE OF THE
4. COMBUSTION AIR INTAKE PIPE WITH GUARD						8. TWO STAGE, DIRECT SPARK IGNITION BOX.													
					9. DIGITAL, 24/7 PROGRAMMABLE, TWO STAGE, WALL MOUNTED						11. THE HORIZONTAL COMBUSTION AIR AND VENT SYSTEMS USING A CONCENTRIC VENT MUST BE CATEGORY III								
					SYSTE						SYSTEM (SEPARATE COMBUSTION) AND VENT MUST BE GAS TIGHT.								

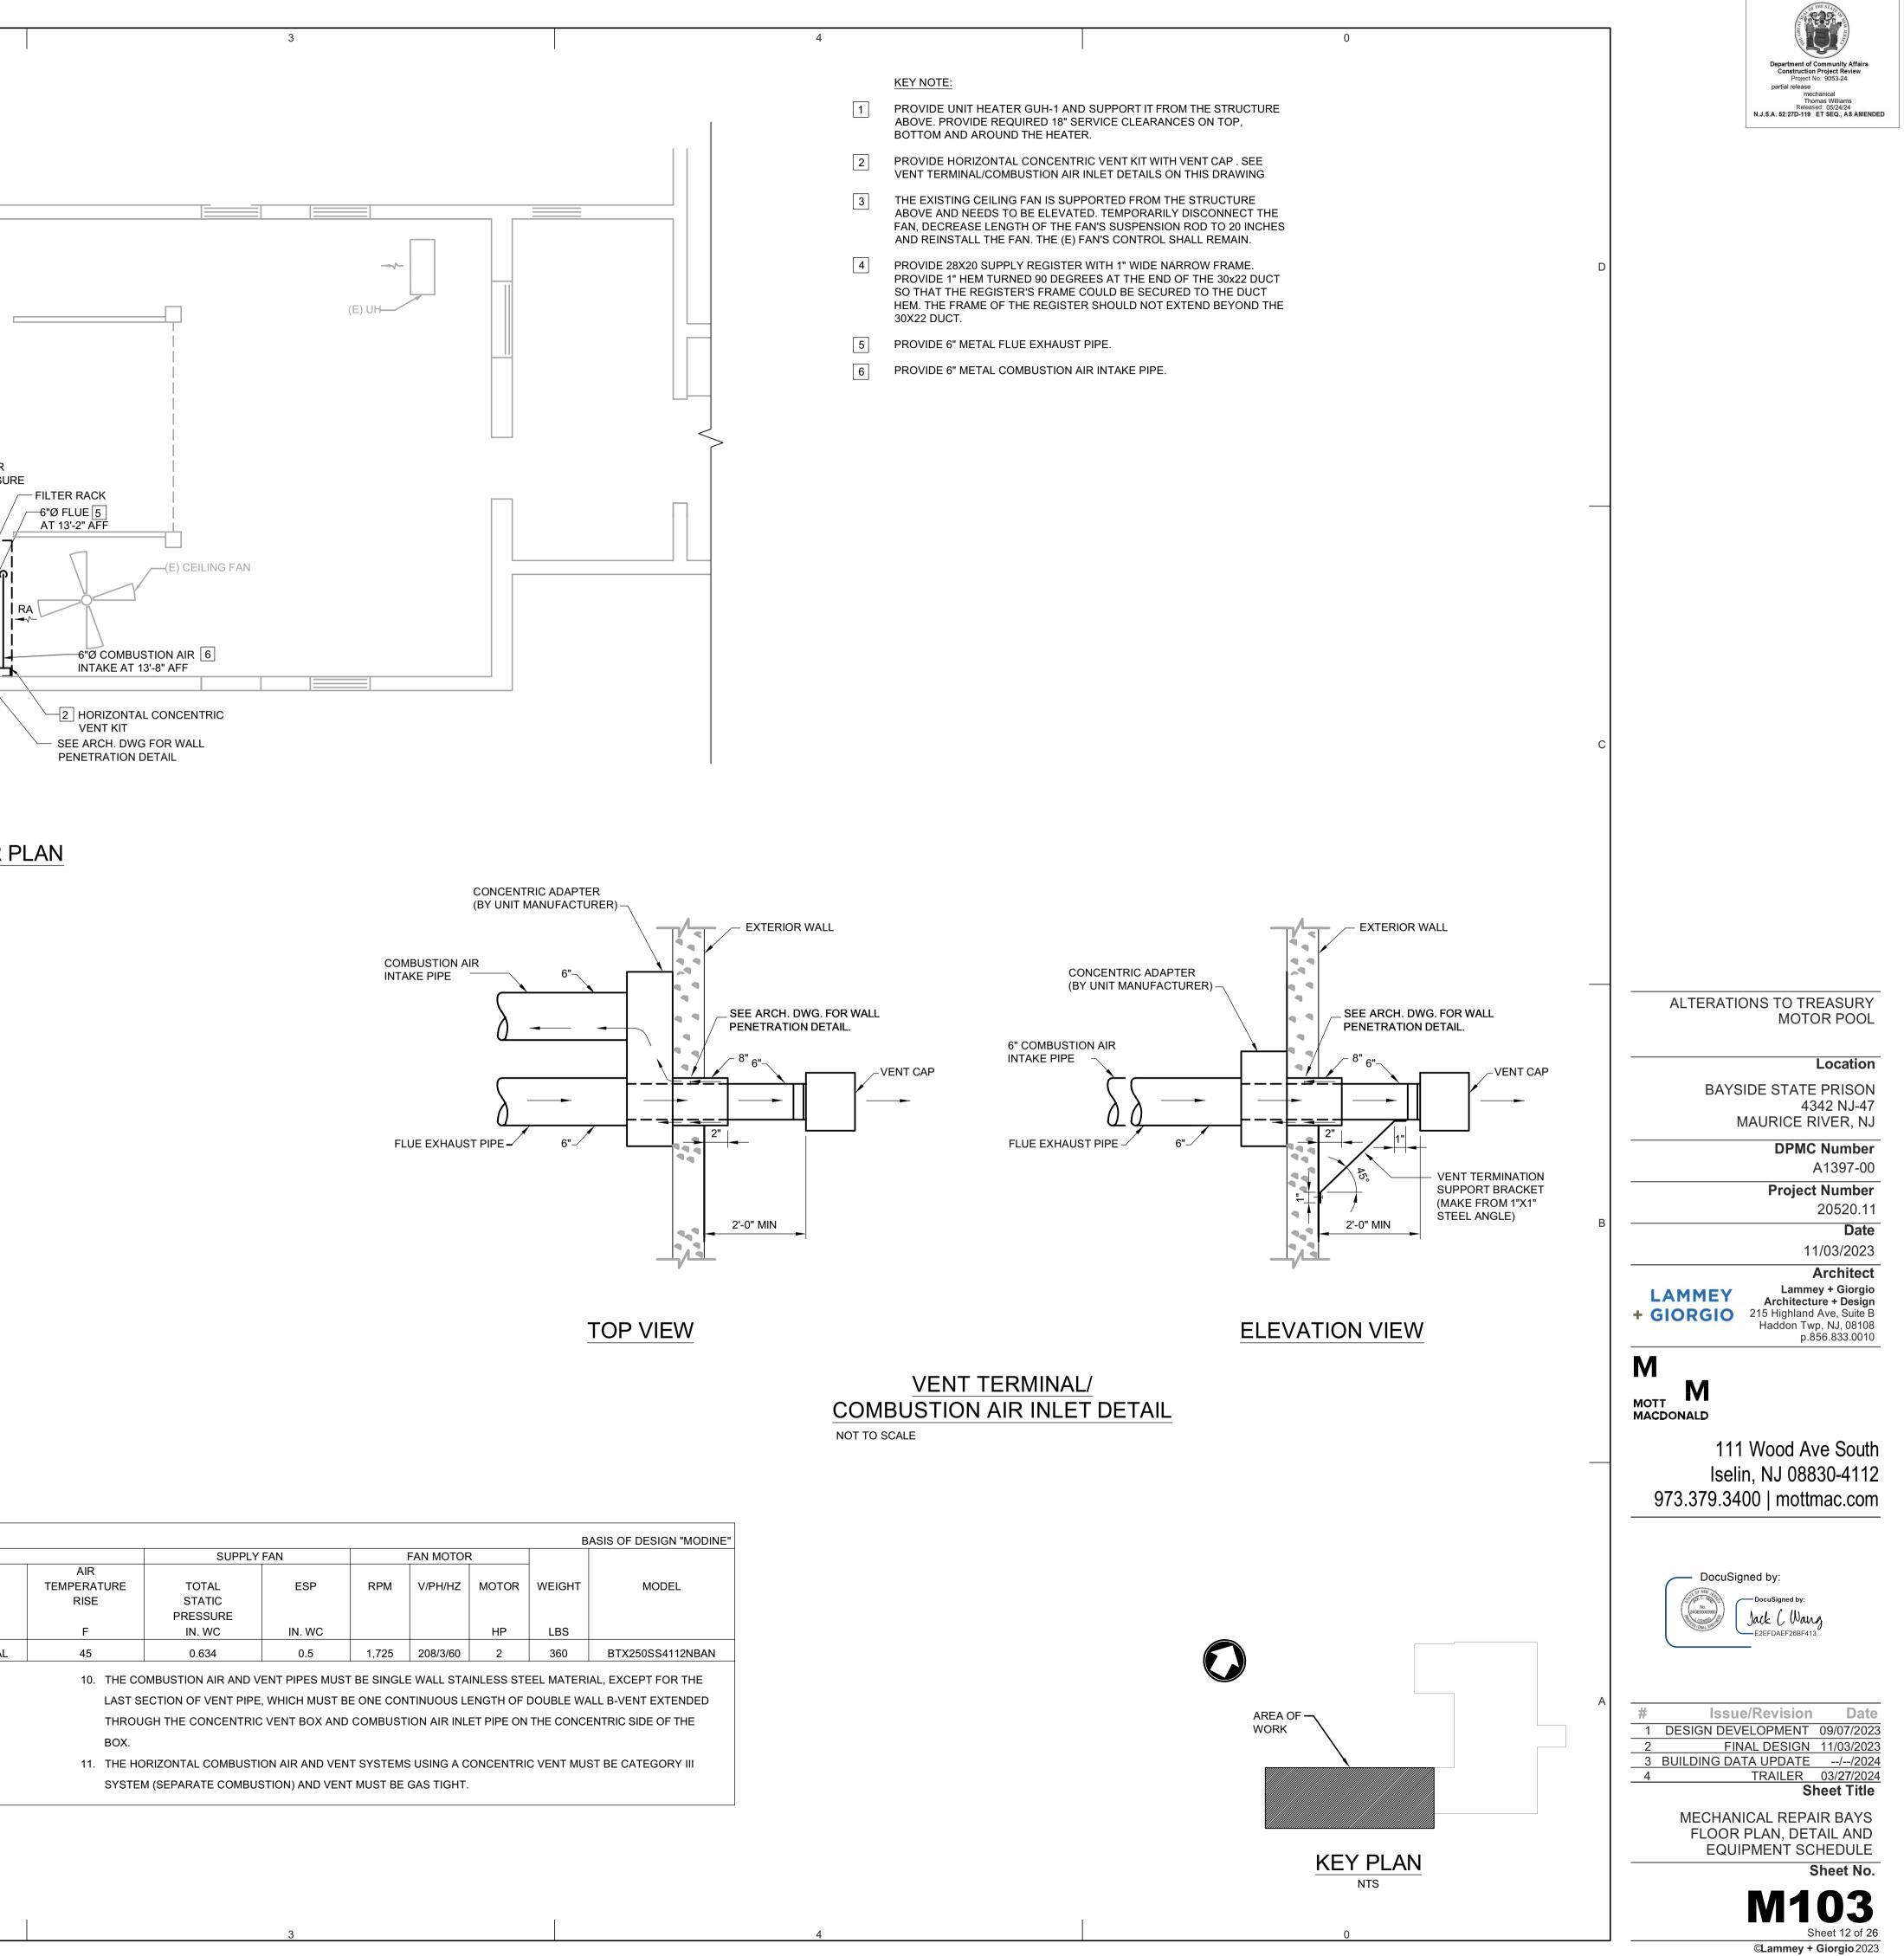

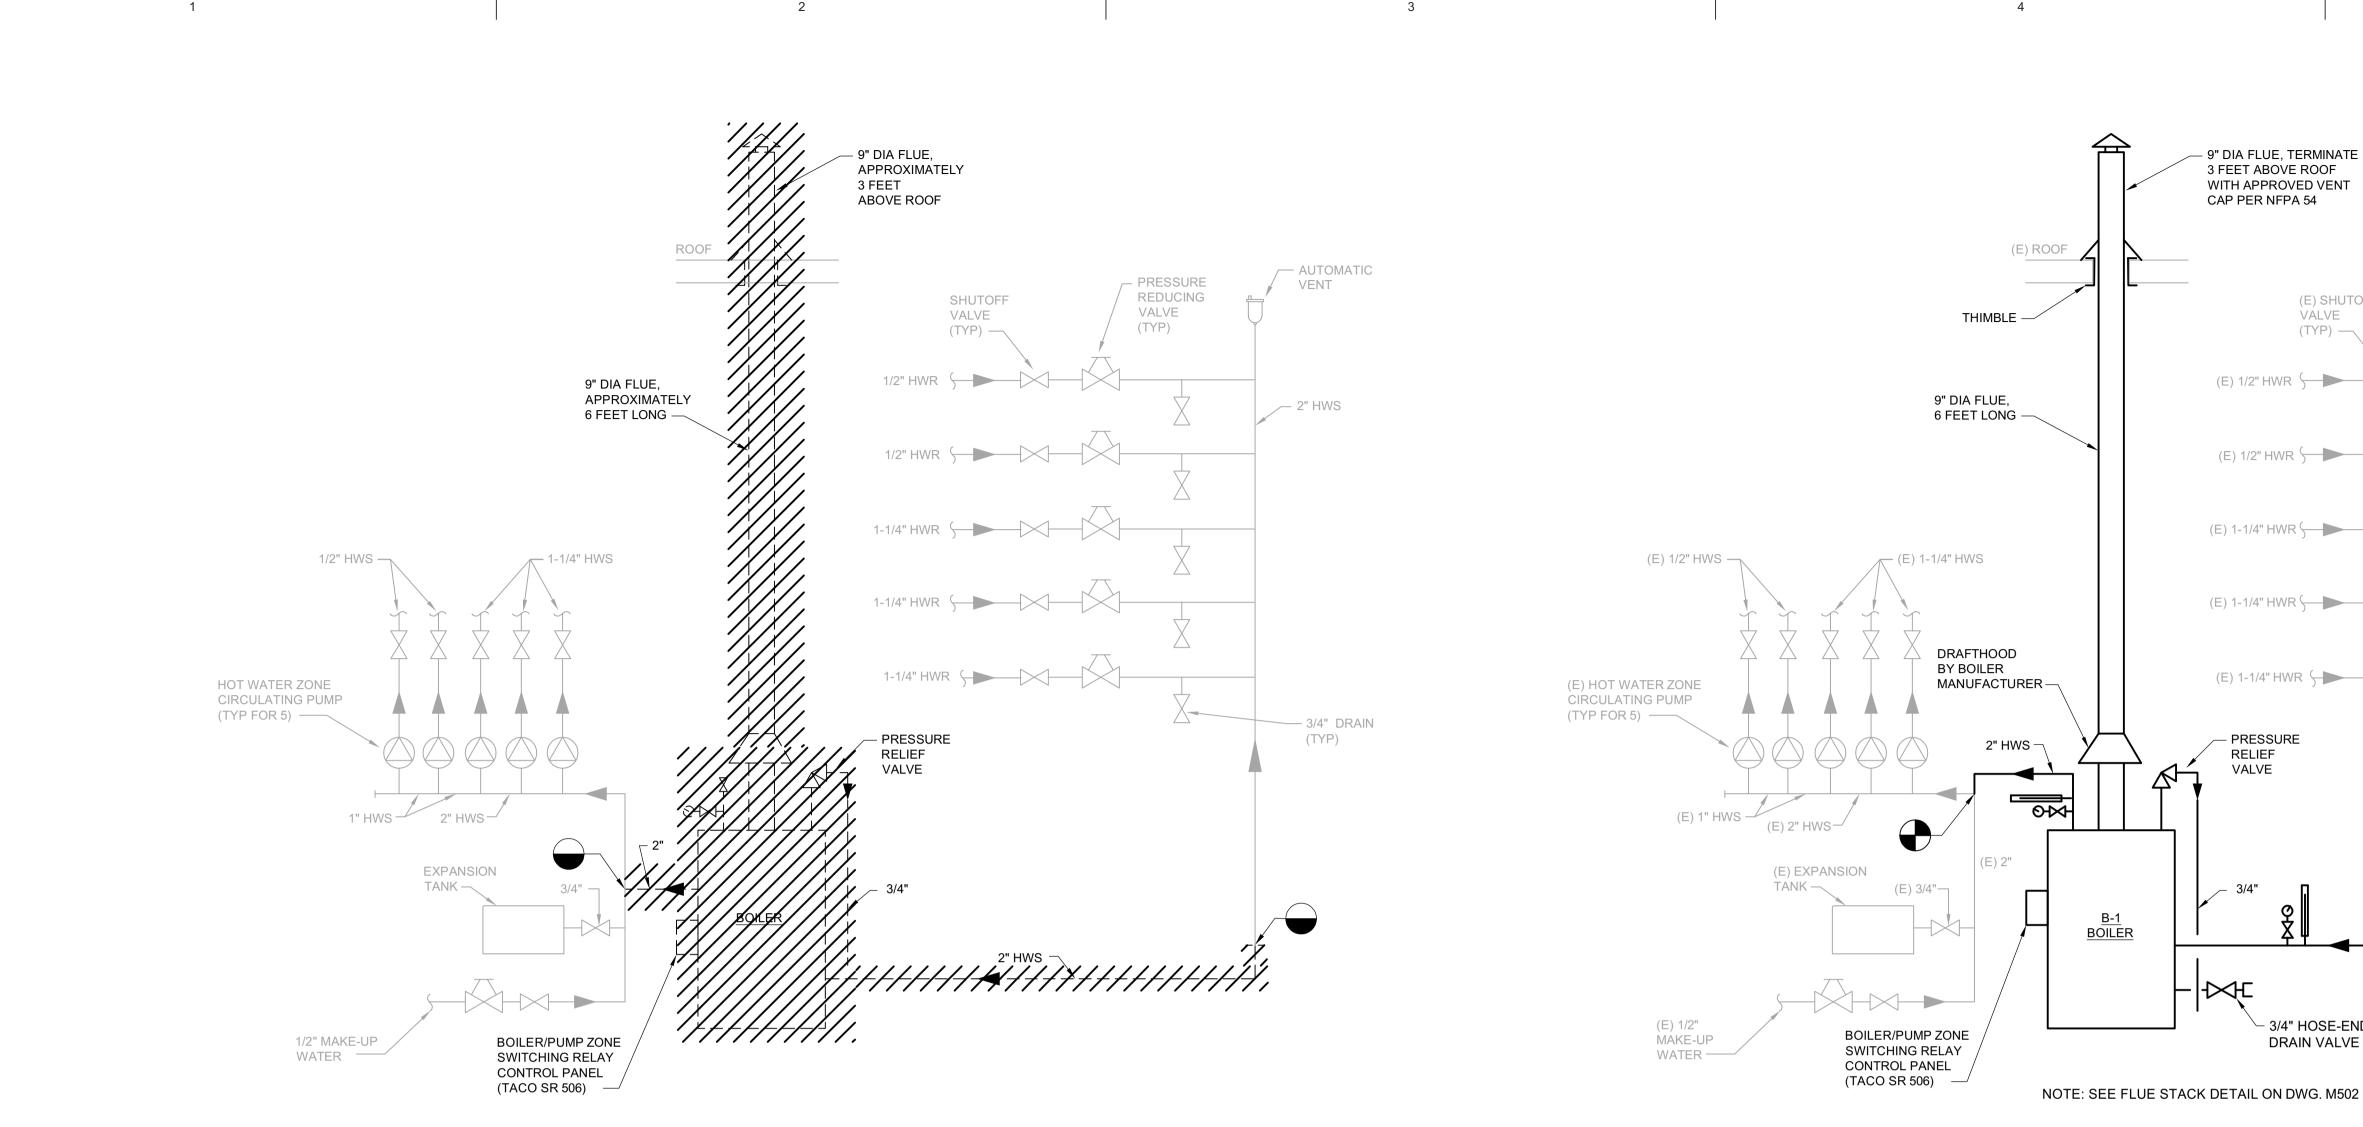


## BOILER SYSTEM PIPING DEMOLITION SCHEMATIC

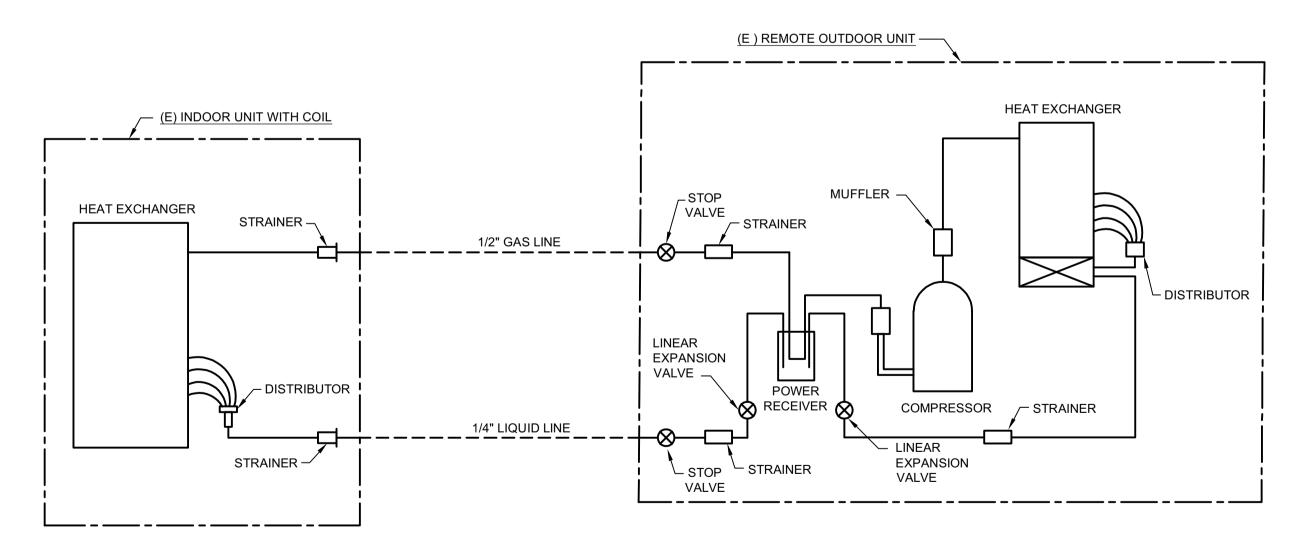



GENERAL NOTES:

- 1. SHOWN SINGLE-CIRCUIT SCHEMATIC IS DIAGRAMMATIC. UNIT MAY HAVE MORE THAN
- ONE CIRCUIT. 2. FIELD VERIFIED TO MATCH EXISTING REFRIGERANT PIPE SIZES.
- 3. PROVIDE ALL MANUFACTURER'S RECOMMENDED ACCESSORIES NOT LIMITED TO VALVES, FITTINGS AND DEVICES INDICATED ON THE SCHEMATIC.
- 4. PROVIDE NEW REFRIGERANT AND REFILL THE DUCTLESS SPLIT SYSTEM UNIT AS REQUIRED. 5. PROVIDE PIPING THERMAL INSULATION AS PER SPECIFICATIONS.
- 6. OUTDOOR UNIT (EQUIPMENT AND INSTALLATION) SHALL MEET REQUIREMENTS OF SPECIFICATION 230548 VIBRATION AND WIND CONTROLS FOR HVAC.

REFRIGERANT PIPING SCHEMATIC FOR DUCTLESS SPLIT SYSTEM HEAT PUMP NOT TO SCALE

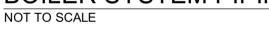

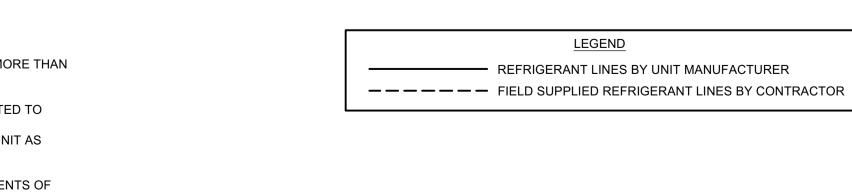

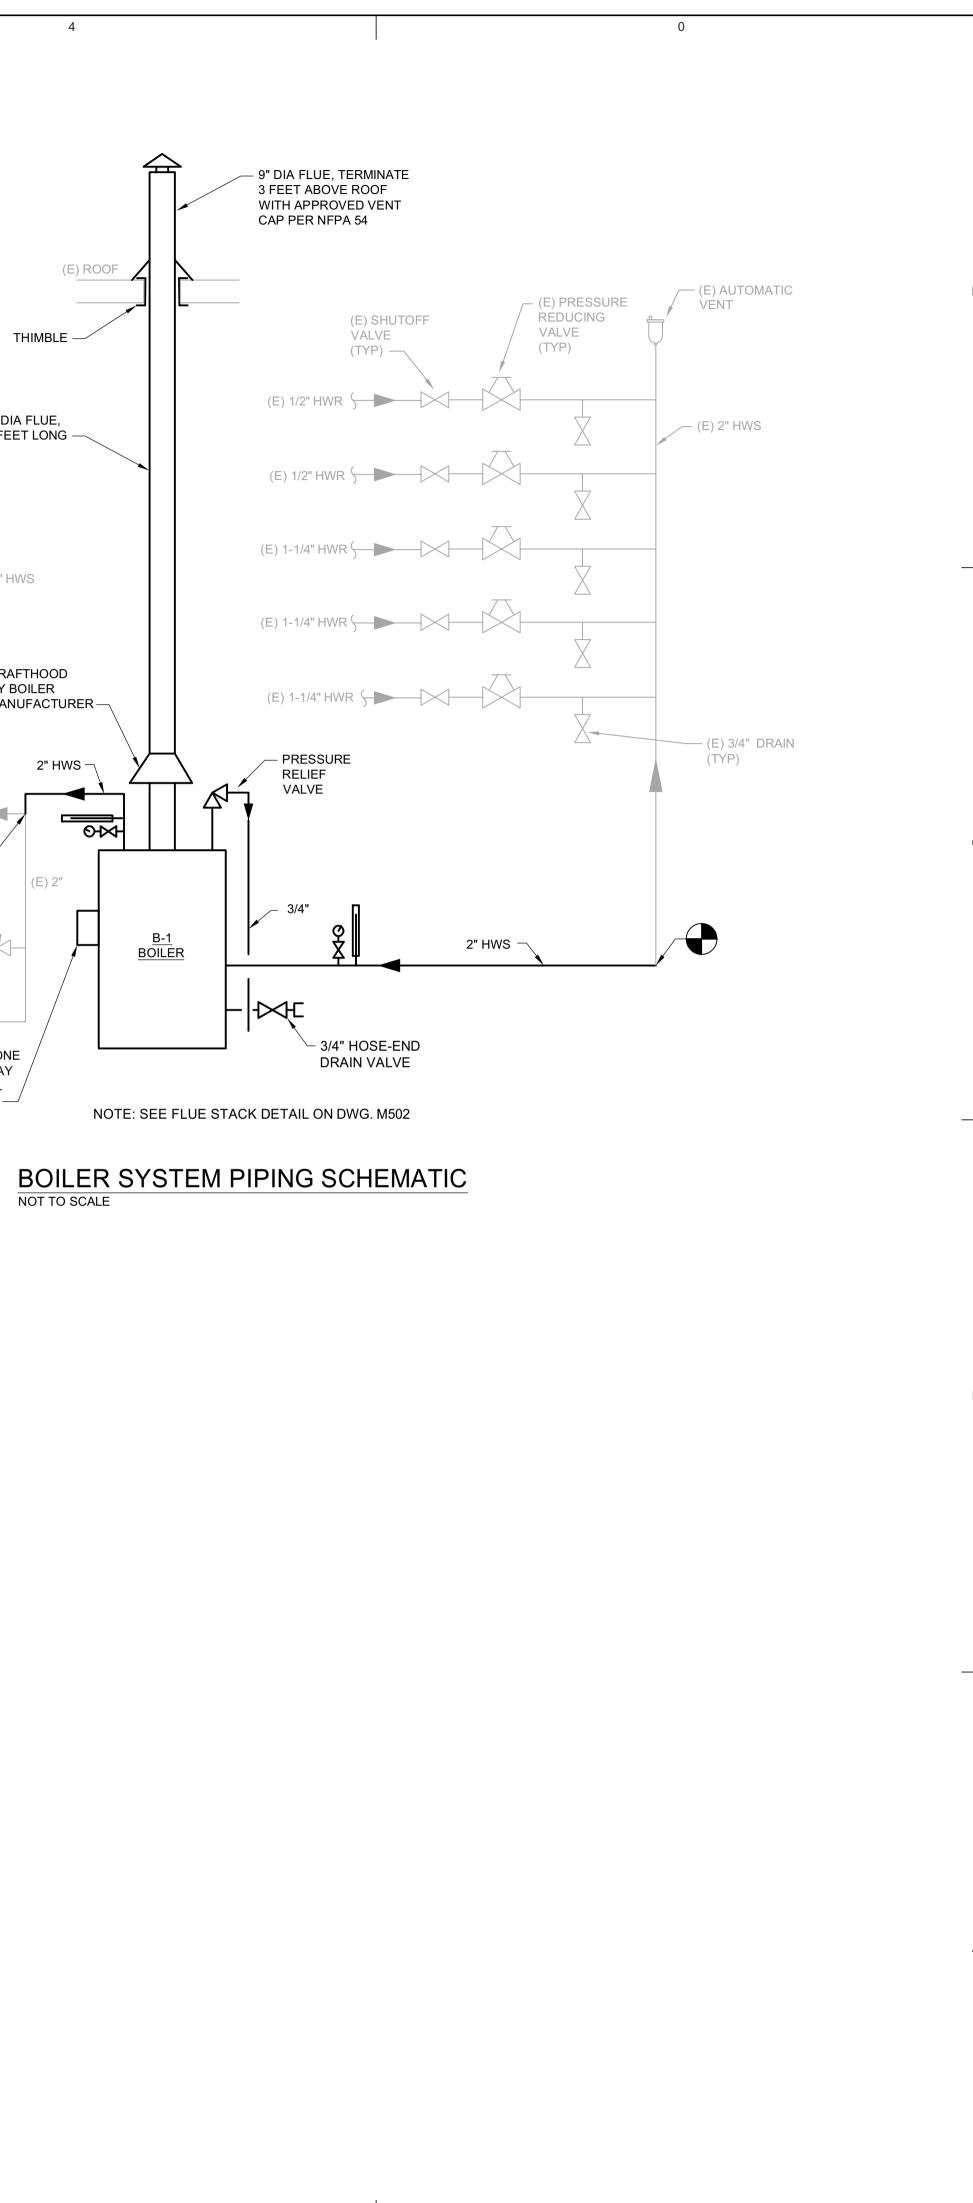


BAYSIDE STATE PRISON 4342 NJ-47
4342 NJ-47 MAURICE RIVER, NJ
DPMC Number
A1397-00
Project Number
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Date
11/03/2023
Architect
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#Issue/RevisionDate1DESIGN DEVELOPMENT09/07/20232FINAL DESIGN11/03/20233BUILDING DATA UPDATE//20244TRAILER03/27/2024Sheet TitleMECHANICAL PIPING SCHEMATICS
Sheet No.
M301


ALTERATIONS TO TREASURY MOTOR POOL

Location

Department of Community Affairs Construction Project Review Project No: 9053-24 partial release mechanical Thomas Williams Released: 05/24/24 N.J.S.A. 52:27D-119 ET SEQ., AS AMENDED

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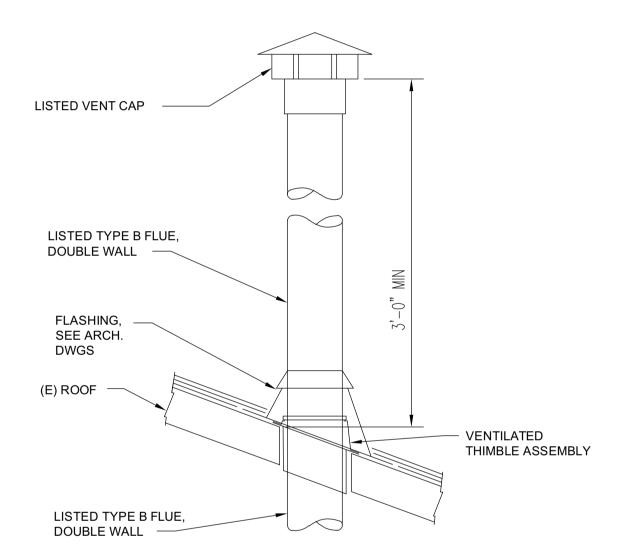

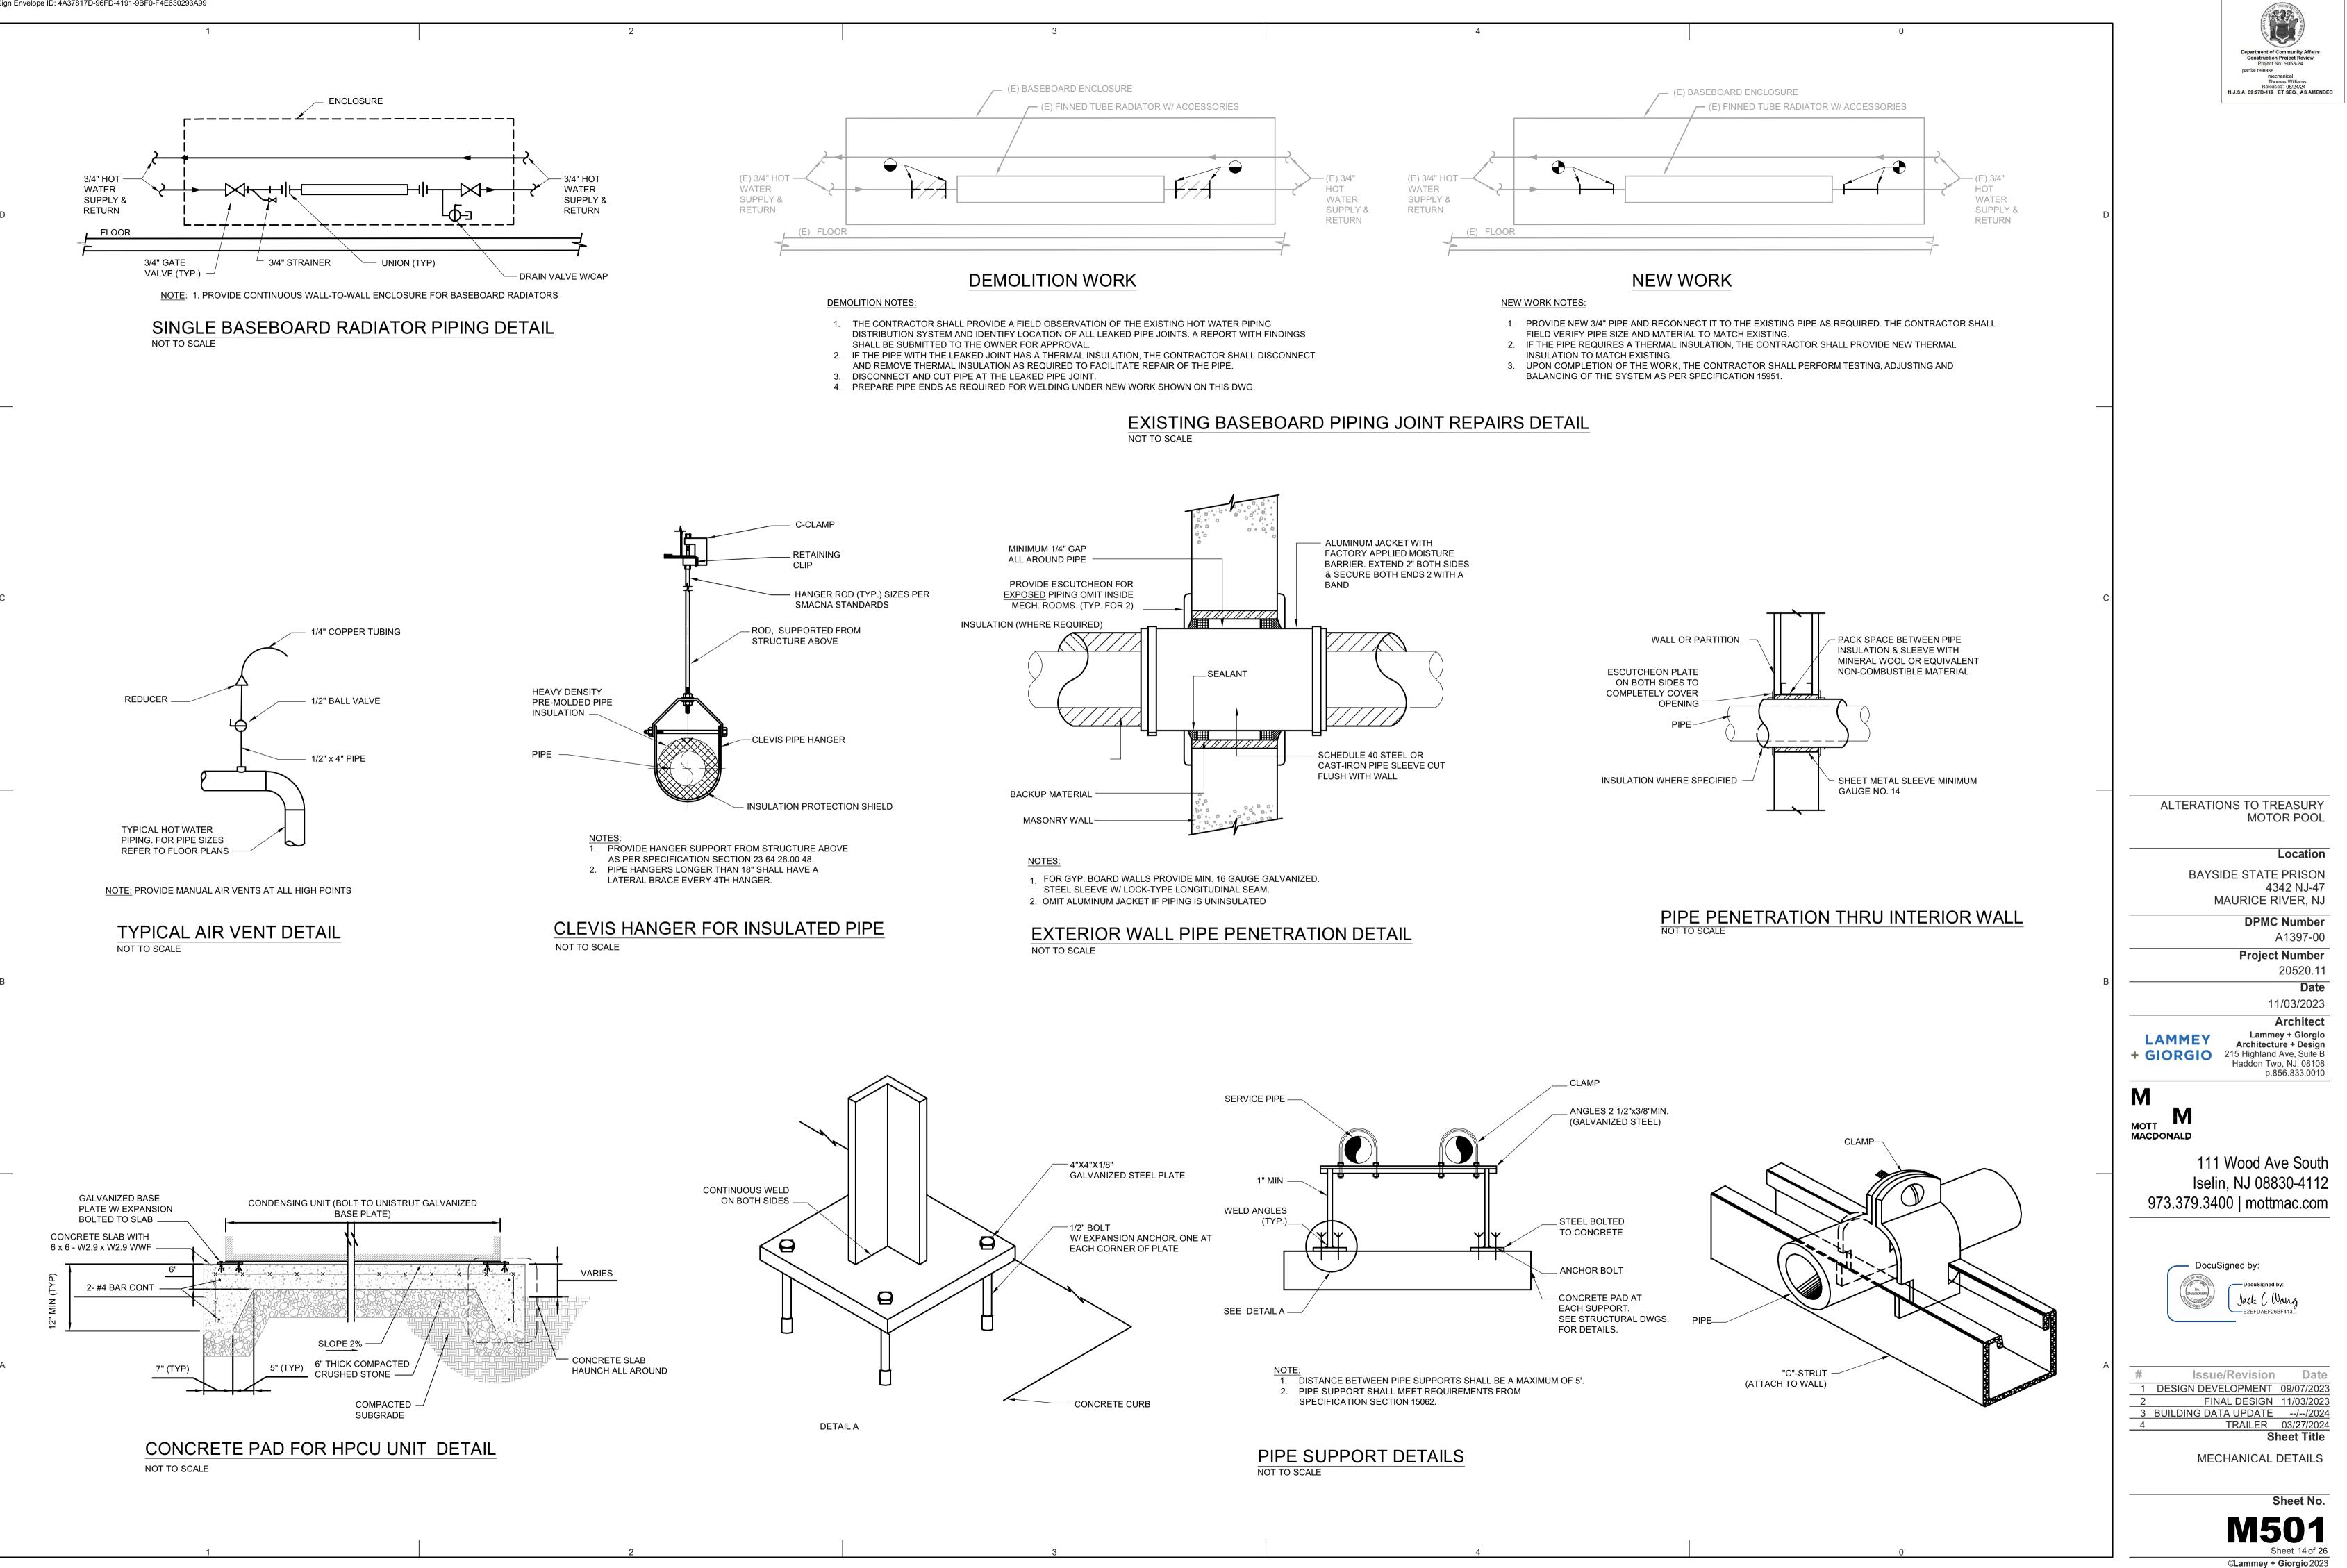
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NOTE:

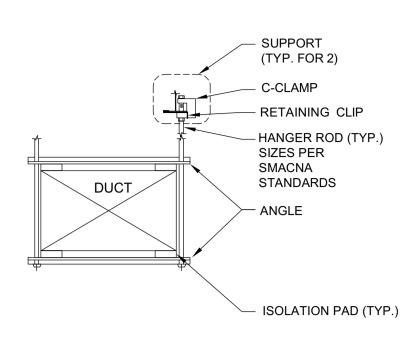1. DISTANCE BETWEEN DUCT HANGERS SHALL BE IN ACCORDANCE WITH SMACNA STANDARD


## **RECTANGULAR DUCT HANGER DETAIL** NOT TO SCALE




NOTES:

- 1. SEE ARCHITECTURAL DWGS FOR ROOF PENETRATION AND ROOF FLASHING DETAILS.
- 2. SEAL WITH HIGH TEMPERATURE SILICONE AROUND THE STACK OPENING TO PREVENT EXHAUST FUMES FROM RETURNING INSIDE THE BUILDING.

FLUE STACK DETAIL NOT TO SCALE

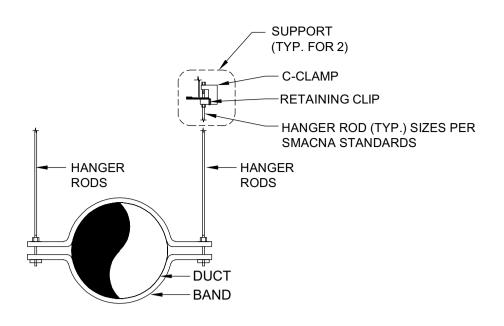

3

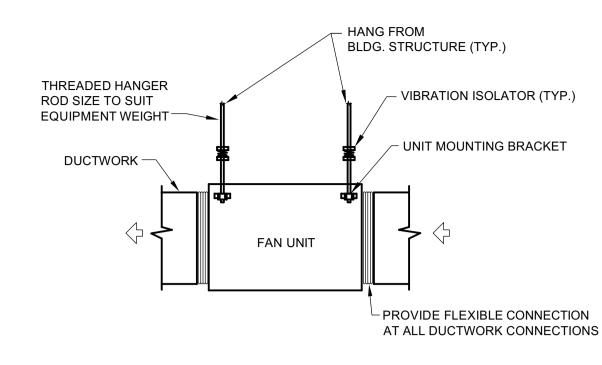

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NOTE:

1. DISTANCE BETWEEN DUCT HANGERS SHALL BE IN ACCORDANCE WITH SMACNA STANDARD

## ROUND DUCT HANGING DETAIL NOT TO SCALE

FAN SUPPORTING DETAIL NOT TO SCALE

## MECHANICAL EQUIPMENT SEQUENCE OF OPERATION

1. GENERAL

PROVIDE ALL NECESSARY CONTROL DEVICES, WIRING, CONDUITS, CONTROLLERS, ETC. AS REQUIRED FOR PROPER OPERATION OF THE MECHANICAL EQUIPMENT AND SYSTEMS.

BOILER (B-1) AND THE PUMP ZONE SWITCHING RELAY CONTROL PANEL

THE EXISTING HEATING HOT WATER SYSTEM CONTROLS SHALL BE UPGRADED TO INCLUDE OPERATION OF THE BOILER (B-1) AND THE PUMP ZONE SWITCHING RELAY CONTROL PANEL (TACO SR 506) IN SEQUENCE ROUTINE.

THE BOILER AND THE PUMP ZONE SWITCHING RELAY CONTROL PANEL SHALL OPERATE UNDER THE EXISTING CONTROL SYSTEM AND UNDER THE EXISTING SEQUENCE OF OPERATION.

2.1 EMERGENCY BOILER SHUT OFF SWITCH

ACTIVATION OF ANY EMERGENCY BOILER SHUT OFF SWITCH SHALL IMMEDIATELY SHUTDOWN THE BOILER BY DISCONNECTING THE BOILER FROM ALL SOURCES OF POWER. REFER TO THE ELECTRICAL DRAWINGS FOR INSTALLATION AND WIRING OF THE EMERGENCY BOILER SHUT OFF SWITCH.

2.2 CARBON MONOXIDE (CO) DETECTOR

WHEN CARBON MONOXIDE (CO) LEVEL RISES ABOVE SETPOINT OF 25 PPM (ADJUSTABLE) AS DETECTED BY A WALL MOUNTED CARBON MONOXIDE DETECTOR, LOCAL AUDIBLE AND VISUAL ALARMS SHALL INITIATE AT THE LOCAL PANEL OF THE DETECTOR AND REMOTE AUDIBLE AND VISUAL ALARM WITH STROBE AND HORN SHALL INITIATE AT THE DOOR OF THE BOILER ROOM AS SHOWN ON THE PLANS. WHEN CO GAS LEVEL DROPS BELOW SETPOINT OF 25 PPM (ADJUSTABLE), ALL AUDIBLE AND VISUAL ALARMS SHALL STOP.

- 3. EXHAUST FANS (EF-1 & EF-2)
- 3.1 THE WALL MOUNTED SWITCH SHALL CONTROL OPERATION OF THE FAN EF-1 FOR JANITOR ROOM. WHEN THE SWITCH IS ON, THE FAN SHALL START AND OPERATE CONTINUOUSLY. WHEN THE SWITCH IS OFF, THE FAN SHALL STOP.
- 3.2 THE OCCUPANCY SENSOR SHALL CONTROL OPERATION OF THE FAN EF-2 FOR TOILET ROOM. WHEN THE SENSOR IS ACTIVATED, THE FAN SHALL START AND OPERATE CONTINUOUSLY. WHEN THE SENSOR IS DE-ACTIVATED, THE FAN SHALL STOP.

4. GAS-FIRED UNIT HEATER (GUH-1)

THE UNIT HEATER SHALL BE CONTROLLED BY A STAND ALONE WALL MOUNTED THERMOSTAT. WHEN THE SPACE TEMPERATURE RAISED ABOVE A SET POINT,

THE HEATER SHALL START AND OPERATED CONTINUOUSLY UNDER BUILT-IN CONTROLS (BY UNIT MANUFACTURER). WHEN THE SPACE TEMPERATURE LOWERS BELOW SET POINT, THE HEATER SHALL STOP.

- SET SPACE TEMPERATURE SET POINT AT 65° F(ADJUSTABLE).
- 5. EXISTING DUCTLESS SPLIT SYSTEM HEAT PUMP THE UNIT SHALL OPERATE UNDER BUILT-IN CONTROLS TO MAINTAIN THE SPACE TEMPERATURE SETPOINT BASED ON THE (E) SPACE MOUNTED THERMOSTAT OUTPUT.

SET SPACE TEMPERATURE SETPOINT AT 74 °F (ADJUSTABLE) FOR SUMMER AND AT 70 °F (ADJUSTABLE) FOR WINTER.

6. CONDENSATE DRAIN PUMP (CP-1)

THE PUMP SHALL AUTOMATICALLY START AND STOP AS REQUIRED TO PUMP OUT THE CONDENSATE DRAIN FROM THE CONDENSATE RESERVOIR. THE PUMP SHALL OPERATE UNDER THE PUMP MANUFACTURER'S PROVIDED CONTROLS.

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### ALTERATIONS TO TREASURY MOTOR POOL

	Location			
	SIDE STATE PRISON 4342 NJ-47 MAURICE RIVER, NJ			
	DPMC Number			
A1397				
	Project Number			
	20520.11			
	Date			
	11/03/2023			
LAMMEY + GIORGIO	Architect Lammey + Giorgio Architecture + Design 215 Highland Ave, Suite B Haddon Twp, NJ, 08108 p.856.833.0010			

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Issue/Revision Date 1 DESIGN DEVELOPMENT 09/07/2023 FINAL DESIGN 11/03/2023 ____2 3 BUILDING DATA UPDATE --/--/2024 TRAILER 03/27/2024 4 Sheet Title

MECHANICAL DETAILS AND EQUIPMENT SEQUENCE OF OPERATION Sheet No.



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──____ PIPE CAP

## PLUMBING SYMBOLS

## PLUMBING ABBREVIATIONS

PLUMBING S	SYMBOLS	<u>PLUMBING</u>	ABBREVIATIO
у — ех	SISTING DOMESTIC COLD WATER PIPING	AFF	ABOVE FINISHED FLOOR
۶ <b>EX</b>	(ISTING DOMESTIC HOT WATER PIPING	A.D.	ACCESS DOOR
۶ EX	SISTING DOMESTIC HOT WATER RETURN PIPING	AV	ACID VENT
∽ — — — — — →	(ISTING VENT PIPING	AW	ACID WASTE
∽ss <b></b> ×	(ISTING SANITARY PIPING	СО	CLEANOUT
∽SS <b></b>	(ISTING SANITARY PIPING BELOW GROUND	CODP	CLEANOUT DECK PLATE
∽ G EX	(ISTING GAS PIPING	C.L. ဋ	CENTER LINE
<b>\$ → → → ★ </b> AE	BANDON IN PLACE	CFH	CUBIC FEET PER HOUR
\$ / / / / / / RE	MOVE EXISTING PIPING	CW	DOMESTIC COLD WATER
RE	EMOVED PLUMBING FIXTURE	DCDA	DOUBLE CHECK DETECTO
	DMESTIC COLD WATER	DN.	DOWN
<b>└──</b> ↓ DC	DMESTIC HOT WATER PIPING	DWG.	DRAWING
<b>уу</b> но	DT WATER RETURN PIPING	EL	ELEVATION
<b>5       </b>	ENT PIPING	EM EW	EMERGENCY EYE WASH
ststst st	ORM DRAIN PIPING	EES	EMERGENCY EYEWASH + S
<b>,</b> s <b>,</b> sΑ	NITARY PIPING (ABOVEGROUND)	EXIST (E)	EXISTING
	NITARY PIPING BELOW GROUND	FAI	FRESH AIR INLET
<b>∽∽−−−</b> NG−−−−− <b>\$</b> NA	TURAL GAS PIPING	FD	FLOOR DRAIN
<b>,</b> GV <b>,</b> GA	AS VENT PIPING	FT	FOOT/FEET
D	DETECTOR (CARBON MONOXIDE	FIN.	FINISH
	AND COMBUSTIBLE GAS)	FL.	FLOOR
G	S PIPE DOWN	F.U.	FIXTURE UNITS
0		G	GAS
<u>د</u>	PIPE RISE	GAL	GALLONS
	GAS COCK (GAS VALVE)	GPF	GALLONS PER FLUSH
<b>→ →</b>	GATE VALVE OR BALL VALVE	GPH	GALLONS PER HOUR
	TRAP	GPM	GALLONS PER MINUTE
	CHECK VALVES	HB	HOSE BIBB
FD 🌐 🔘	FLOOR DRAIN	HP	HORSEPOWER
RD OR AD 🕕	ROOF DRAIN/AREA DRAIN	HW	DOMESTIC HOT WATER
	SHOWER HEAD	HWR	DOMESTIC HOT WATER RE
	PIPE REDUCER		
	PIPE UNION		
₽ ^ſ Ţ	TEMPERATURE & PRESSURE RELIEF VALVE		
<b>-</b>	DIRECTION OF FLOW		
	HOSE BIBB		

CLEANOUT CLEANOUT DECK PLATE LIMITS OF VENDOR LIMITS OF WORK

CONNECTION TO EXISTING SYSTEM POINT OF DISCONNECTION PLUG VALVE

NG METER

NG REGULATOR

**IDENTIFICATION TARGET:** A = DETAIL NUMBER XXX = SHEET NUMBER ON WHICH DETAIL IS LOCATED

D.	ACCESS DOOR	IW	INDIRECT W
/	ACID VENT	KS	KITCHEN SIN
V	ACID WASTE	LAV	LAVATORY
)	CLEANOUT	L	LEADER
DDP	CLEANOUT DECK PLATE	MS	MOP SINK
L. Ę	CENTER LINE	NG	NATURAL G
Ή	CUBIC FEET PER HOUR	N.I.C.	NOT IN CON
V	DOMESTIC COLD WATER	NFWH	NON-FREEZ
CDA	DOUBLE CHECK DETECTOR ASSEMBLY	Ρ/	PER
۱.	DOWN	RD	ROOF DRAIN
VG.	DRAWING	RM	ROOM
	ELEVATION	PRV	PRESSURE I
1 EW	EMERGENCY EYE WASH	RPZA	REDUCED P
S	EMERGENCY EYEWASH + SHOWER	RT	RUNNING TR
(IST (E)	EXISTING	S/SAN	SANITARY
I	FRESH AIR INLET	SS	SERVICE SI
)	FLOOR DRAIN	SL	SLEEVE
	FOOT/FEET	SH	SHOWER
Ν.	FINISH	SH DR	SHOWER DF
	FLOOR	TYP	TYPICAL
J.	FIXTURE UNITS	TD	TRENCH DR
	GAS	TW	TEMPERED
AL.	GALLONS	UR	URINAL
PF	GALLONS PER FLUSH	V	VENT
РΗ	GALLONS PER HOUR	VTR	VENT THRO
PM	GALLONS PER MINUTE	W	WASTE
3	HOSE BIBB	WC	WATER CLC
)	HORSEPOWER	WCO	WALL CLEA
V	DOMESTIC HOT WATER	WH	WATER HEA
VR	DOMESTIC HOT WATER RETURN	WHA	WATER HAM

2

IF

		PIPE S	CHEDUL	E		
SYSTEM	LOCATION	MATERIAL	TYPE	STANDARD	JOINTS	FITTINGS
DOMESTIC WATER	ABOVE GROUND	COPPER	TYPE L	ASTM B88	SOLDERED	WROUGHT COPPER
DOMESTIC WATER	BURIED	COPPER	ΤΥΡΕ Κ	ASTM B88	COMPRESSION	WROUGHT COPPER
SANITARY/VENT	ABOVE GROUND	CAST IRON	NO-HUB	ASTM A 888 CISPI 301	HUBLESS COUPLINGS	CAST IRON
SANITARY/VENT	BURIED	CAST IRON	HUB+SPIGOT	ASTM A 74	RUBBER GASKET	CAST IRON
GAS PIPING 3" AND SMALLER	ABOVE GROUND	STEEL ASTM A106	BLACK	SCH. 40	THREADED	THREADED MALLEABLE IRON ANS B16.3 & CLASS 150

E	ELECTRI	C DOMES	FIC WATI	ER HEATE	ER SCH	IEDUL	Ξ
TAG NO.	LOCATION	MANUFACTURER (BASIS OF DESIGN)	MODEL (BASIS OF DESIGN)	TYPE	RATING (KW)	V/PH	FULL LOAD CURRENT (AMPS)
WH-1	JANITOR CLOSET	A.O. SMITH	DEL-10	10 GALLON	3	208/1	14.4

## INVERT ELEVATION

- DIRECT WASTE
- TCHEN SINK
- ADER
- OP SINK
- TURAL GAS
- OT IN CONTRACT
- N-FREEZE WALL HYDRANT
- DOF DRAIN
- DOM
- RESSURE REDUCING VALVE
- EDUCED PRESSURE ZONE ASSEMBLY
- JNNING TRAP
- ANITARY
- ERVICE SINK
- **.EEVE**
- HOWER
- **HOWER DRAIN**
- /PICAL
- RENCH DRAIN
- MPERED WATER
- RINAL
- ENT THROUGH ROOF
- ASTE
- ATER CLOSET
- ALL CLEANOUT
- ATER HEATER
- ATER HAMMER ARRESTER

3

- 1. ALL DEMOLITION WORK SHOWN ON DRAWINGS SHALL BE EXECUTED IN STRICT ACCORDANCE WITH PROVISIONS OF LOCAL, STATE, AND LAWS, ORDINANCES, WHEREVER APPLICABLE AND ALL REGULATIONS GOVERNING SAFETY DURING DEMOLITION WORK AS PUBLISHED AN OSHA
- 2. THE CONTRACTOR SHALL THOROUGHLY REVIEW THE DRAWINGS AND BECOME FAMILIAR WITH EVERY ASPECT OF THE WORK. CONTRACTOR SHALL THOROUGHLY INSPECT THE SITE AND VERIFY ALL INFORMATION AND DATA INDICATED AND DESCRIBED ON THE DRAWINGS. THE CONTRACTOR SHALL NOTIFY THE ENGINEER'S OFFICE IMMEDIATELY, IN WRITING, IF DURING THE INSPECTION OF THE SITE, DISCREPANCIES OR CONDITIONS NOT QUESTIONS REGARDING THE INTENT OF THE WORK SHOULD ARISE.
- 3. THE CONTRACTOR SHALL FURNISH LABOR, MATERIALS AND EQUIPMENT NECESSARY OR REQUIRED TO PERFORM AND COMPLETE ALL DEMOLITION WORK AS SHOWN ON THE DRAWINGS INCLUDING, BUT NOT LIMITED, TO THE FOLLOWING:

A) COORDINATE THE REMOVAL AND STORAGE OF EQUIPMENT, THAT IS TO BE RETAINED BY GOV'T, PRIOR TO DEMOLITION IN AREAS OF WORK. B) ACCESS TO AND EGRESS FROM THE SITE WILL BE AT POINTS ON ADJACENT PUBLIC STREETS OR ROADS AS DIRECTED AND APPROVED BY THE OWNER, THE CONTRACTOR SHALL BE RESPONSIBLE FOR AND SHALL SETTLE ALL CLAIMS ARISING OUT OF HIS USE OR ABUSE OF SUCH STREETS AND ROADS, AND SHALL MAKE GOOD ANY DAMAGE FROM TRAFFIC ON THE OWNER'S PROPERTY.

4

C) EXECUTE THE WORK IN AN ORDERLY, CAREFUL MANNER WITH SPECIAL CONSIDERATION FOR OCCUPANCY, INSURE THAT NO DAMAGE OR INJURY SHALL OCCUR TO PERSONS, OR PROPERTY, ANY DAMAGE OR INJURY RESULTING FROM WORK SHALL BE THE RESPONSIBILITY OF THE CONTRACTOR, WHO SHALL MAKE GOOD SUCH DAMAGE AND ASSUME ALL RESPONSIBILITY FOR SUCH INJURY, WITHOUT ADDITIONAL COST TO THE OWNER.

D) THIS CONTRACTOR SHALL COORDINATE AND SCHEDULE ALL DEMOLITION WITH THE SITE ENGINEERING OFFICE AND OBTAIN WRITTEN PERMISSION PRIOR TO COMMENCING WORK.

E) DEMOLITION IN CRITICAL AREAS MAY REQUIRE WORK BEYOND NORMAL BUSINESS HOURS AND SHALL BE DONE AT NO ADDITIONAL CHARGE TO THE OWNER. VERIFY CRITICAL AREAS AND EXTENT OF WORK WITHIN THESE AREAS PRIOR TO BID.

- 4. ALL UNSALVAGEABLE MATERIAL, EQUIPMENT AND DEBRIS SHALL BECOME THE PROPERTY OF THE CONTRACTOR AND SHALL BE LEGALLY DISPOSED OF OFF SITE, THE CONTRACTOR SHALL OBTAIN AND PAY FOR ALL HAULING AND/ OR DUMPING PERMITS WHEN REQUIRED.
- 5. EXISTING MATERIALS AND/ OR EQUIPMENT REMOVED AS PART OF THE DEMOLITION WORK SHALL NOT BE REUSED FOR ANY OF THE NEW WORK UNLESS SPECIFICALLY NOTED ON THE DRAWINGS OR AS DIRECTED BY OWNER.
- 6. INDICATIONS OF WORK TO BE REMOVED ARE GENERAL ONLY, AND ARE NOT INTENDED TO SHOW ALL ITEMS WHICH MAY REQUIRE REMOVAL. SUCH ITEMS
- SHALL BE REMOVED, RELOCATED, AND/ OR REINSTALLED AS REQUIRED FOR INSTALLATION OF NEW WORK. 7. THE CONTRACTOR SHALL ERECT DUST TIGHT CHUTES FOR REMOVAL OF MATERIAL, RUBBISH, DEBRIS AS REQUIRED AT LOCATIONS DESIGNATED BY OWNER,
- DROPPING OF MATERIALS FROM ANY HEIGHT WILL NOT BE PERMITTED. 8. THE CONTRACTOR WILL BE REQUIRED TO REPAIR OR REPLACE IN KIND, AT HIS OWN EXPENSE, ANY DAMAGE WHICH MAY BE CAUSED TO ANY PART OF EXISTING CONSTRUCTION OR MATERIAL TO REMAIN OR TO ITEMS DESIGNATED FOR REUSE.
- 9. IT SHALL BE THE CONTRACTOR'S RESPONSIBILITY TO PROVIDE AND MAINTAIN A FIRE SAFETY PROGRAM, CONSULT WITH AND CONFORM TO ALL FIRE SAFETY REQUIREMENTS OF THE STATION FIRE DEPARTMENT WHILE PERFORMING THE WORK OF THIS CONTRACT.
- 10. CONTRACTOR SHALL NOT STORE ANY MATERIAL OR EQUIPMENT IN AREAS THAT WILL IMPEDE THE NORMAL FLOW OF PERSONNEL, AND SHALL STORE MATERIALS IN THOSE AREAS AS DIRECTED BY OWNER.
- 11. THE AREA OF ALTERATION AS WELL AS SURROUNDING AREAS SHALL BE KEPT FREE OF ALL DEBRIS, AND AT THE COMPLETION OF EACH WORKDAY, EACH TRADE SHALL BE RESPONSIBLE FOR CLEANING UP OF THEIR WORK.
- 12. EACH CONSTRUCTION TRADE SHALL COOPERATE WITH OTHER TRADES TO FACILITATE JOB SCHEDULING AND COMPLETION.
- 13. ALL WORK SHALL BE PERFORMED IN ACCORDANCE WITH BEST STANDARD TRADE PRACTICES.
- 14. ALL STRUCTURES SHALL BE CAREFULLY AND THOROUGHLY SUPPORTED THROUGHOUT THE REMOVAL AND REPLACEMENT OF ALL STRUCTURAL ELEMENTS, SUCH THAT THE BUILDING EXPERIENCES NO LOSS OF INTEGRITY OR SETTLEMENT DURING WORK. 15. AS PROVIDED IN THE EXISTING BUILDING AND AS SHALL BE PROVIDED IN THE ALTERATION OF THE AFFECTED AREAS OF REMOVALS, RELOCATIONS,
- INSTALLATIONS, ETC. THE CONCEALED SPACES WITHIN PARTITIONS WALLS. FLOORS STAIRS PIPE SPACES COLUMN ENCLOSURES, ETC. SHALL BE COMPLETELY FIRESTOPPED, IN AN APPROVED MANNER, WITH NON- COMBUSTIBLE MATERIAL
- 16. CONSTRUCTION SHALL BE CONFINED TO THE WORK AS INDICATED ON THE DRAWINGS AND SHALL NOT CREATE DUST, OR OTHER SUCH INCONVENIENCES TO OTHER AREAS. DUST SHALL BE KEPT TO A MINIMUM AND SHALL BE REMOVED AFTER EACH DAYS WORK IS COMPLETED.
- 17. PLUMBING CONTRACTOR SHALL NOT BLOCK HALLWAYS AND SHALL PROTECT AND MAINTAIN ENTRANCES AND EGRESS FROM BUILDING. 18. ALL PRECAUTIONS TO BE OBSERVED IN THE BUILDING TO MAINTAIN FIRE SAFETY DURING CONSTRUCTION.
- 19. BUILDING SECURITY TO BE MAINTAINED TO PREVENT UNAUTHORIZED PERSONS FROM ENTERING.
- 20. CONSTRUCTION OPERATIONS WILL NOT INVOLVE INTERRUPTION OF HEATING WATER OR ELECTRICAL SERVICES TO THE BUILDING UNLESS PRIOR NOTIFICATION WAS MADE TO THE ENGINEER.
- 21. FLOORS SHALL NOT BE OVERLOADED WITH CONSTRUCTION MATERIAL BEYOND THAT PERMITTED.
- 22. PIPING TO REMAIN SHALL BE PLUGGED OR CAPPED SO THAT UPON COMPLETION OF DEMOLITION WORK, ABANDONED PIPING WILL BE CONCEALED BEHIND FINISHED SURFACES.
- 23. NO DEAD ENDS SHALL BE LEFT ON PIPING.
- 24. THE EXISTING SYSTEMS SHALL BE LEFT IN PERFECT WORKING ORDER AT COMPLETION OF DEMOLITION WORK.
- 25. LOCATIONS AND SIZES OF EXISTING PIPING ARE APPROXIMATE. EXACT SIZES AND LOCATIONS OF EXISTING PIPING SHALL BE VERIFIED AT THE PROJECT SITE.
- 26. ALL OTHER APPLICABLE NOTES SHOWN ON DWG T000 SHALL APPLY.
- 27. DUE TO THE SMALL SCALE OF THE DRAWINGS, ALL PLUMBING PIPING IS NOT SHOWN.

		FIXTURE	SCHEDL	JLE	_	
TAG	FIXTURE TYPE	WASTE	VENT	HOT WATER	COLD WATER	DESCRIPTION
wc	WATER CLOSET	4"	2"	-	1"	FLOOR MOUNTED, MANUAL FLUSH VALVE
LAV	LAVATORY	1-1/2"	1-1/2"	1/2"	1/2"	WALL MOUNTED, MANUAL FAUCET
SS	SERVICE SINK	3"	1-1/2"	1/2"	1/2"	WALL MOUNTED, UTILITY FAUCET
PS	PANTRY SINK	1-1/2"	1-1/2"	1/2"	1/2"	ABOVE COUNTER MOUNTED, MANUAL FAUCET

FEDERAL CODES,	
ID ADMINISTERED BY	

## **INSTALLATION NOTES**

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- . THE CONTRACTOR SHALL OBTAIN ANY AND ALL PERMITS REQUIRED FOR THE PERFORMANCE OF WORK AND PAY ALL FEES IN CONNECTION THEREWITH.
- 2. CONTRACTOR SHALL CHECK AND VERIFY THE EXACT LOCATION OF ALL PIPE PENETRATIONS, PIPE ELEVATIONS, AREA DRAINS, ETC.
- 3. PROVIDE SHUT OFF VALVES AND UNIONS/FLANGES AT BASE OF ALL RISERS, MAINS, ALL BRANCHES AND ALL FIXTURE/EQUIPMENT CONNECTIONS IN ORDER TO ISOLATE FOR MAINTENANCE PURPOSES.
- 4. VALVES, AND ANY OTHER EQUIPMENT AND ACCESSORIES THAT MAY REQUIRED ACCESS FOR MAINTENANCE OR OPERATION WHICH ARE LOCATED BEHIND WALLS AND PARTITIONS OR CONCEALED IN HUNG CEILINGS. COORDINATE INSTALLATION WITH GENERAL CONTRACTOR.
- 5. THE CONTRACTOR SHALL COORDINATE PLUMBING WORK WITH ALL OTHER TRADES AND VERIFY DIMENSION AND CONDITIONS AT THE SITE PRIOR TO BEGINNING WORK. NO ADDITIONAL COSTS WILL BE ACCEPTED IF ATTRIBUTED TO FAILURE TO COORDINATE OR VERIFY.
- 6. ALL PLUMBING LINES SHOWN ARE DIAGRAMMATIC AND NOT INTENDED TO SHOW EXACT LOCATIONS. THE CONTRACTOR SHALL INSTALL PIPING SYSTEM TO MINIMIZE LENGTH OF RUNS AND AVOID INTERFERENCES.
- 7. THE CONTRACTOR SHALL PROVIDE SEAL SLEEVES INSTALLED IN FIRE-RATED WALLS, CEILINGS AND FLOORS WITH FIRE-PROOF MATERIAL EQUAL TO THE RATING OF THE RESPECTIVE WALLS, CEILINGS AND FLOORS.
- 8. INSTALL PIPING AS STRAIGHT AND DIRECT AS POSSIBLE FORMING RIGHT ANGEL OR PARALLEL LINES WITH BUILDING WALLS, NEATLY SPACED, RISERS PLUMB AND TRUE, AND AVOID INTERFERENCE WITH OTHER CONSTRUCTION.
- 9. ALL PIPE SLEEVES SHALL BE COORDINATED WITH STRUCTURAL ENGINEER FOR SIZE, LOCATION AND ELEVATION.

ALTERATIONS TO TREASURY MOTOR POOL

Department of Community Affairs Construction Project Review Project No: 9053-24

N.J.S.A. 52:27D-119 ET SEQ., AS AMENDEI

Project . partial release plumbing Thomas Williams 'aased: 05/24/24

## Location BAYSIDE STATE PRISON 4342 NJ-47 MAURICE RIVER. NJ **DPMC** Number A1397-00 Project Number 20520.11 Date

11/03/2023 Architect Lammey + Giorgio LAMMEY Architecture + Design + GIORGIO 215 Highland Ave, Suite B Haddon Twp, NJ, 08108 p.856.833.0010

Μ ΜΟΤΤ MACDONALD

> 111 Wood Ave South Iselin, NJ 08830-4112 973.379.3400 | mottmac.com

- DocuSi	gned by:
CENES CONT	DocuSigned by: Colum Leong BE9A7F1947D5479


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1	DESIGN DEVELOPMENT	09/07/2023
2	FINAL DESIGN	11/03/2023
3	BUILDING DATA UPDATE	//2024
4	TRAILER	03/27/2024
	SI	heet Title


PLUMBING - NOTES, SYMBOLS, ABBREVIATIONS, AND SCHEDULES



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² PLUMBING RESTROOM AND BREAK ROOM DEMOLITION FLOOR PLAN - DOMESTIC WATER PLD101 SCALE: 1/2" = 1'-0"

0

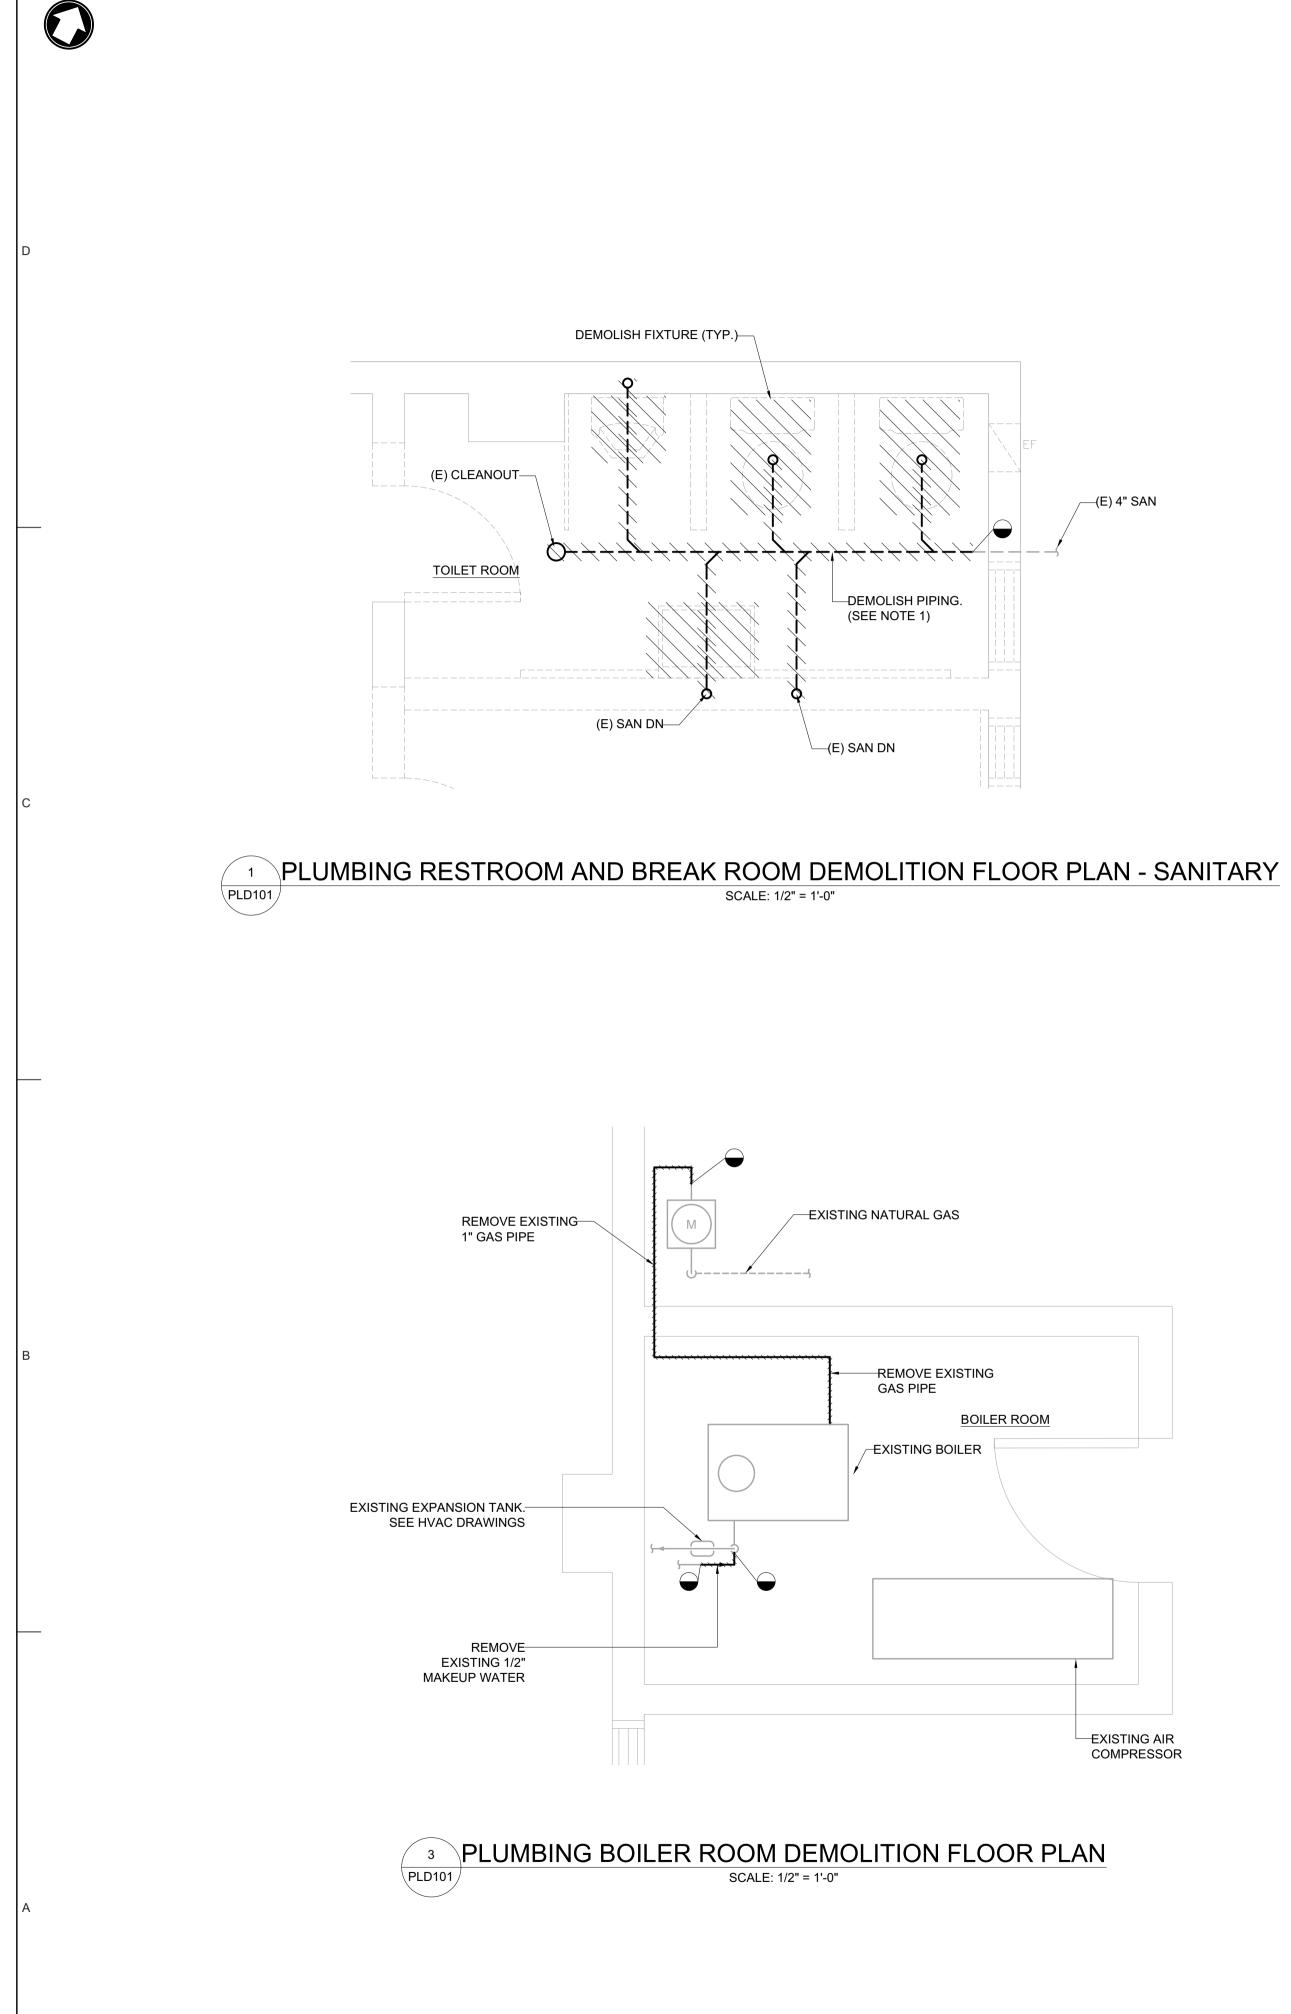SHEET NOTES: 1. CUT FLOOR SLAB TO ACCESS UNDERSLAB PIPING

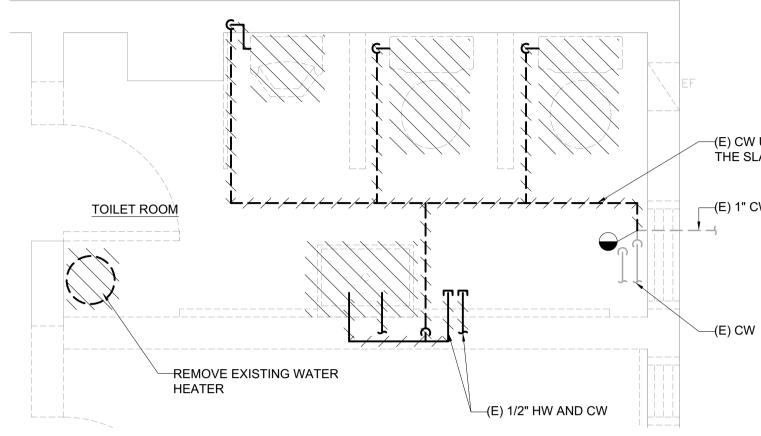(E) CW UNDER THE SLAB

(E) 1" CW SERVICE

BAYSIDE STATE PRISON 4342 NJ-47 MAURICE RIVER, NJ DPMC Number A1397-00 Project Number 20520.11 Date 11/03/2023 Architect LAMMEY + GIORGIO Lammey + Giorgio Architecture + Design 215 Highland Ave, Suite B Haddon Twp, NJ, 08108 p.856.833.0010 Μ Μ MOTT MACDONALD 111 Wood Ave South Iselin, NJ 08830-4112 973.379.3400 | mottmac.com DocuSigned by (dum keou

ALTERATIONS TO TREASURY


MOTOR POOL


Location

А	
A	# Issue/Revision Date
	1 DESIGN DEVELOPMENT 09/07/202
	2 FINAL DESIGN 11/03/202
	3 BUILDING DATA UPDATE//202
	4TRAILER 03/27/202
	Sheet Title
	PLUMBING - RESTROOM, BREAK
	ROOM, AND BOILER ROOM
	DEMOLITION FLOOR PLAN
	Sheet No.
	<b>PLD101</b>


Sheet 18 of 26

AREA OF WORK
KEY PLAN
0 1 2 SCALE: 1/2" = 1'-0"

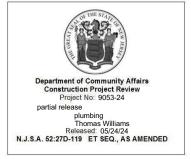


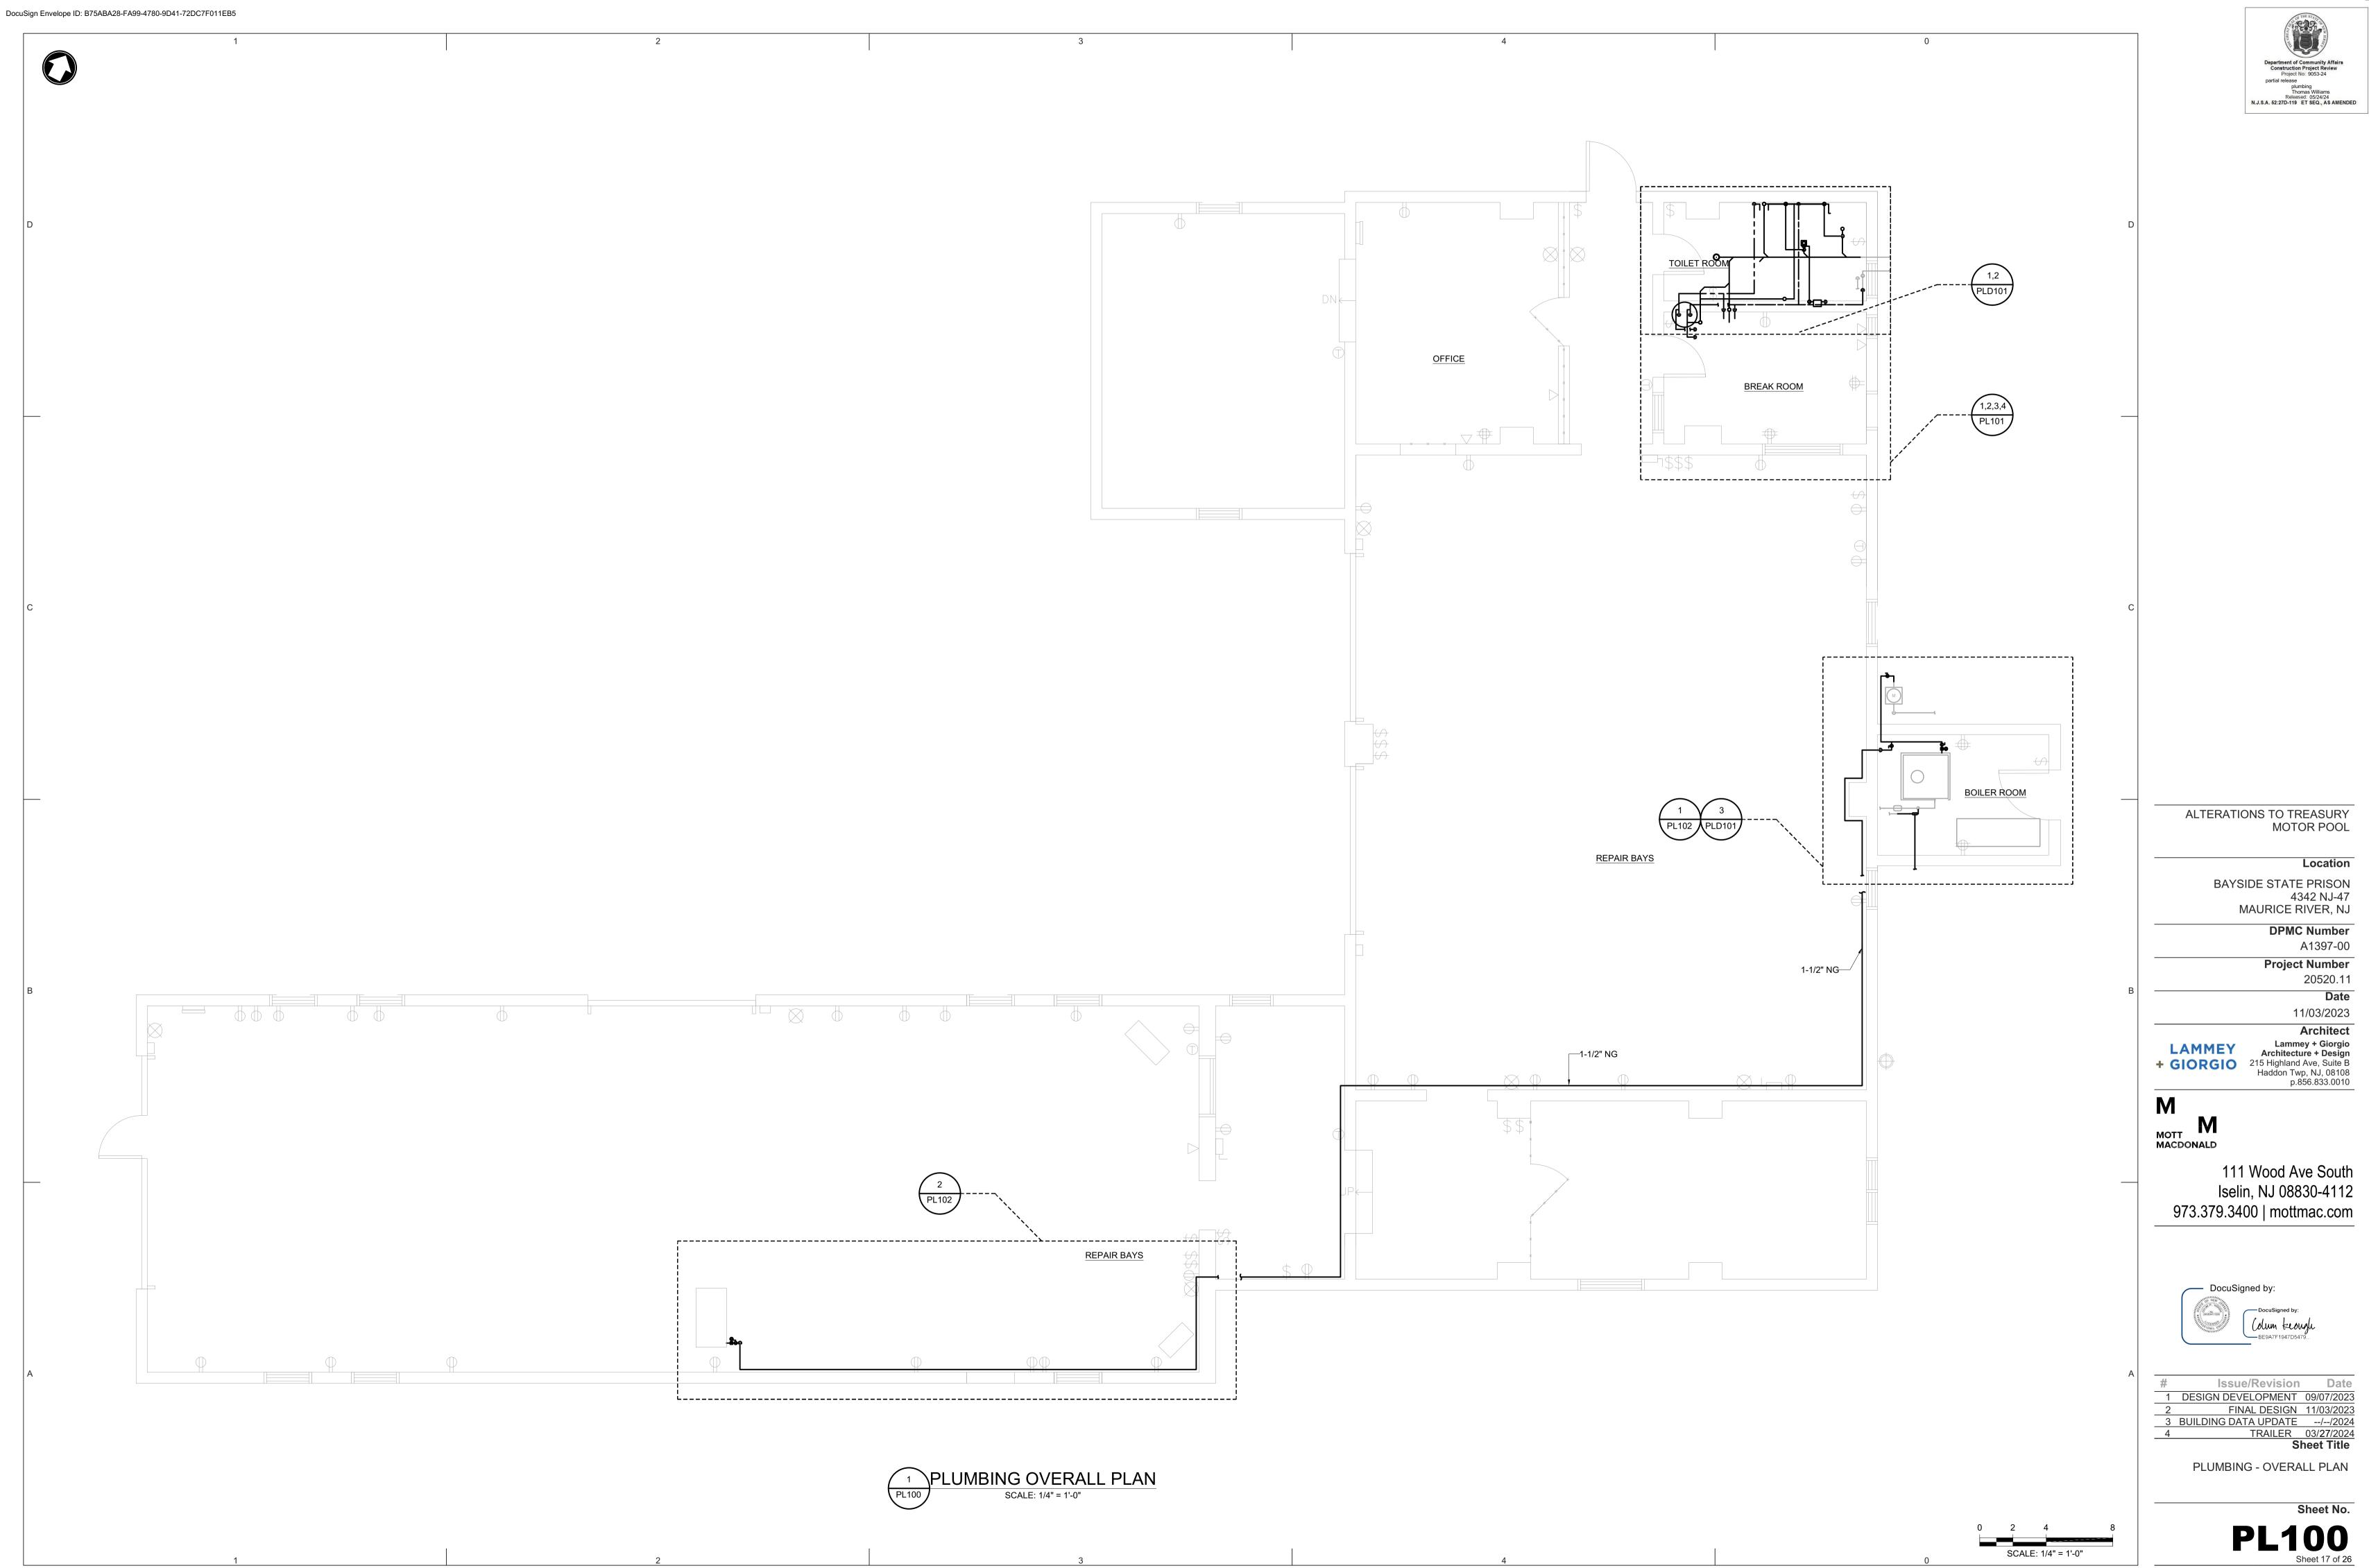

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³ PLUMBING RESTROOM AND BREAK ROOM FLOOR PLAN - SANITARY PL101 SCALE: 1/2" = 1'-0"

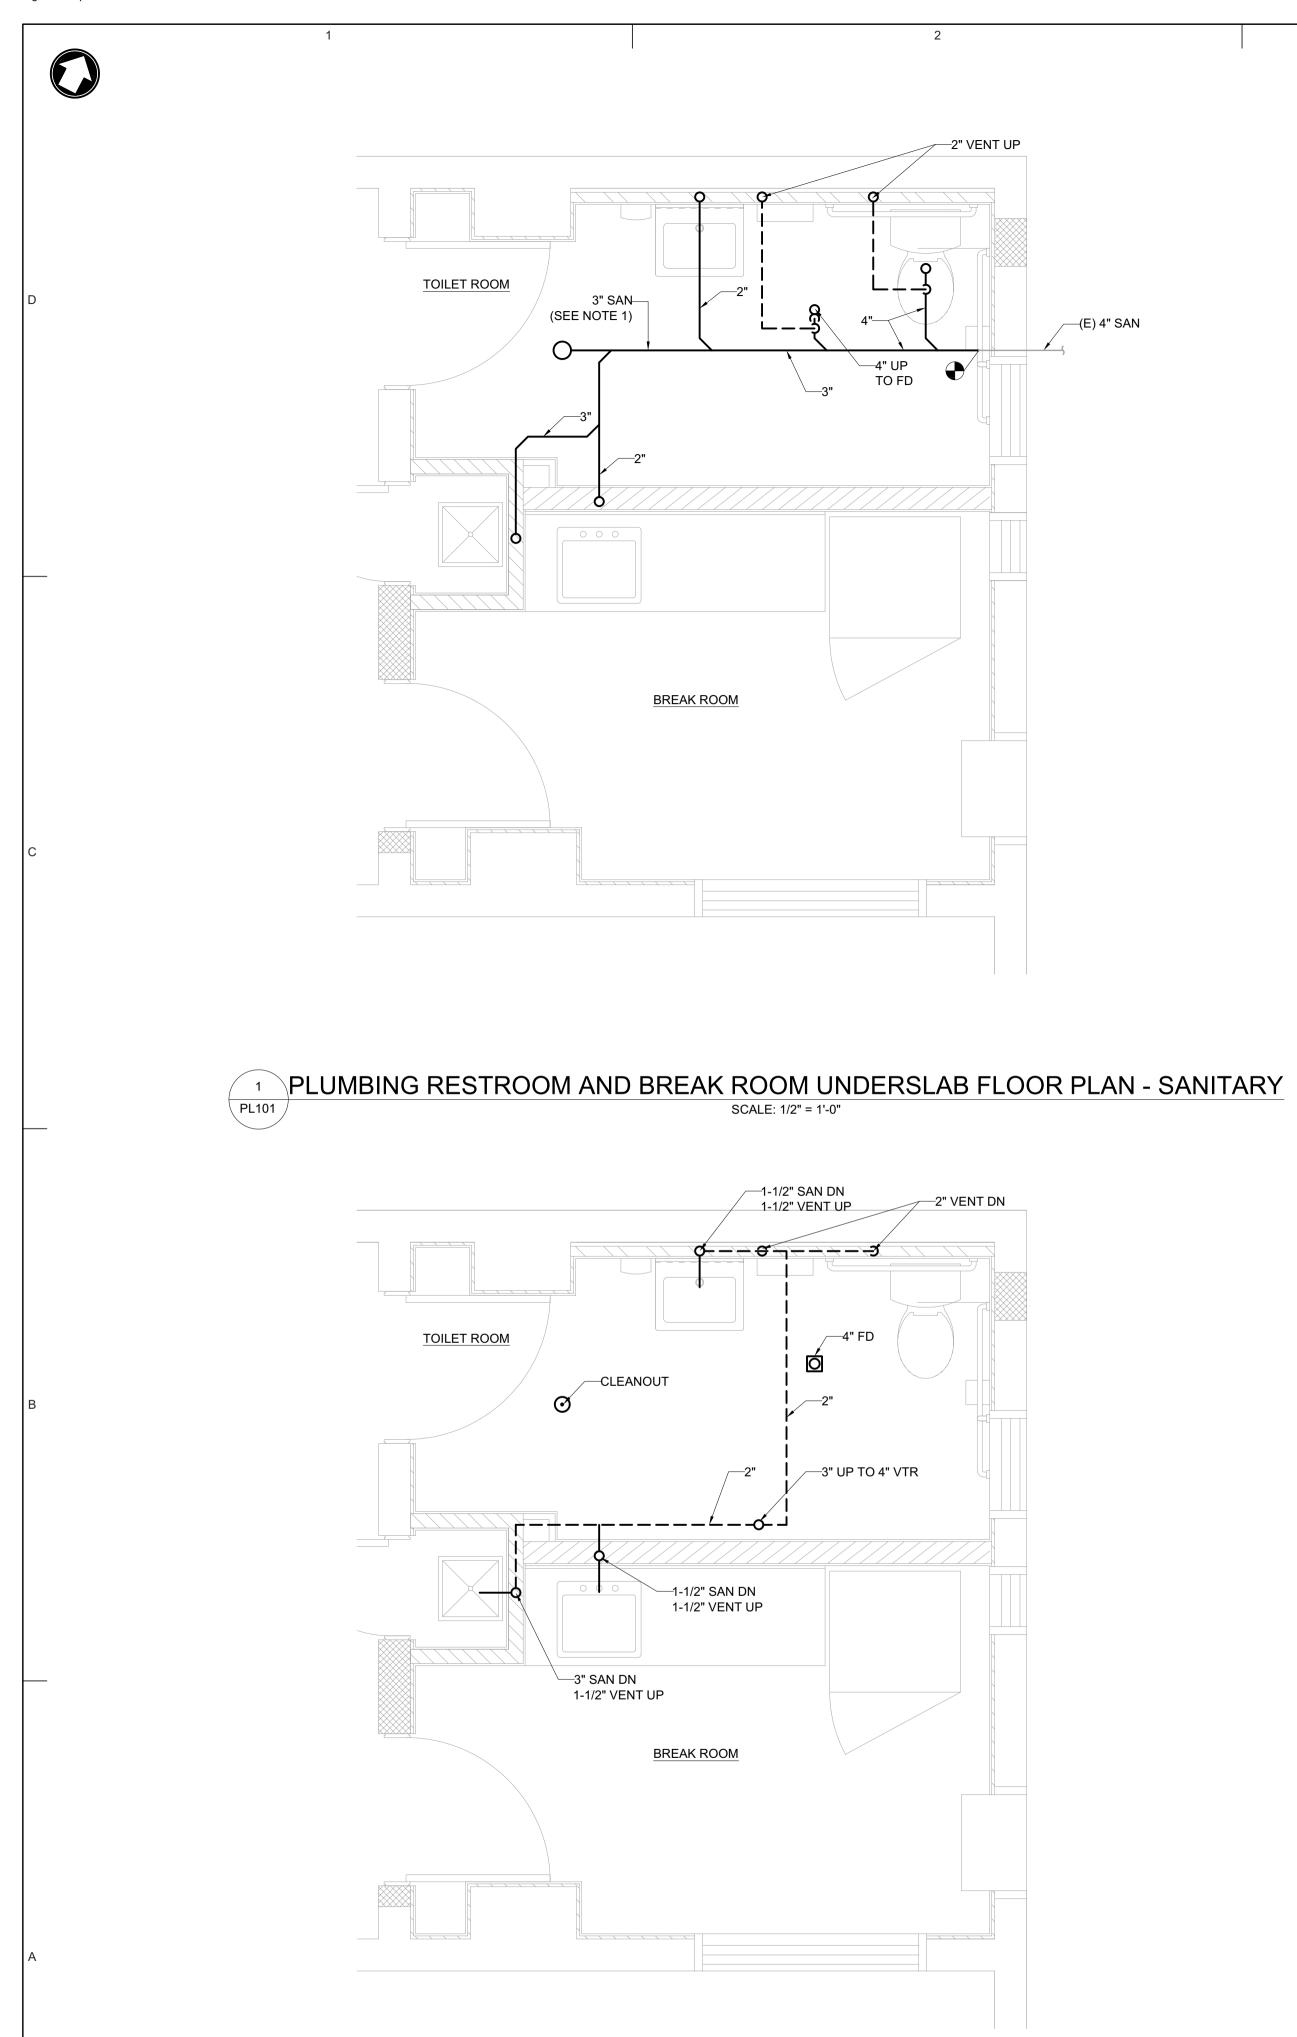


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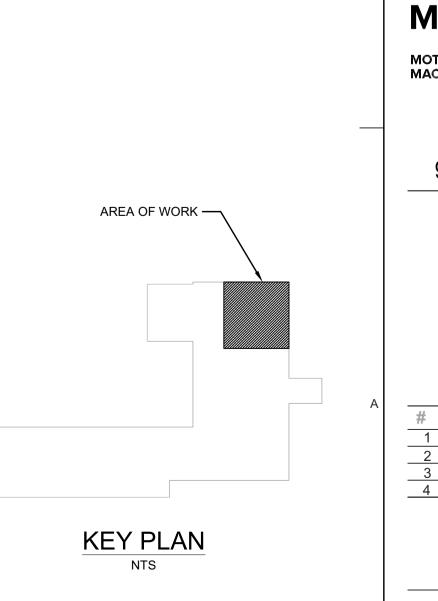
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2 PLUMBING RESTROOM AND BREAK ROOM UNDERSLAB FLOOR PLAN - DOMESTIC WATER SCALE: 1/2" = 1'-0"

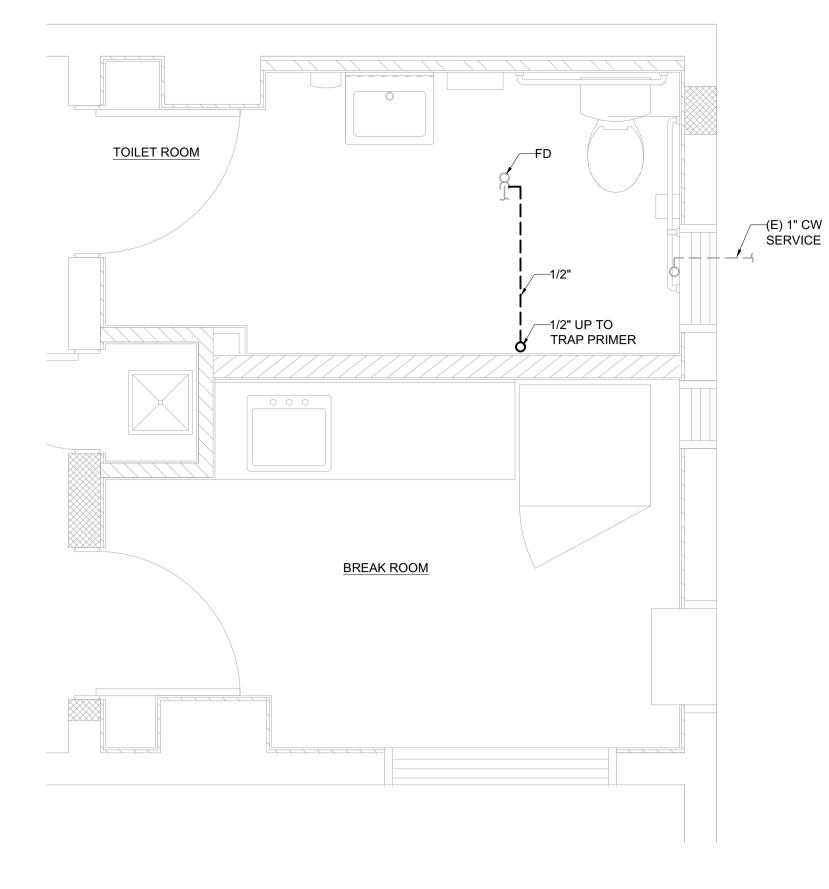

4 PLUMBING RESTROOM AND BREAK ROOM FLOOR PLAN - DOME PL101 SCALE: 1/2" = 1'-0"

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	SHEET NOTES:	
	1. PATCH TOILET ROOM FLOOR SLAB TO MATCH EXISTING AFTER INSTALLATION OF NEW PIPING.	
	D	
		1

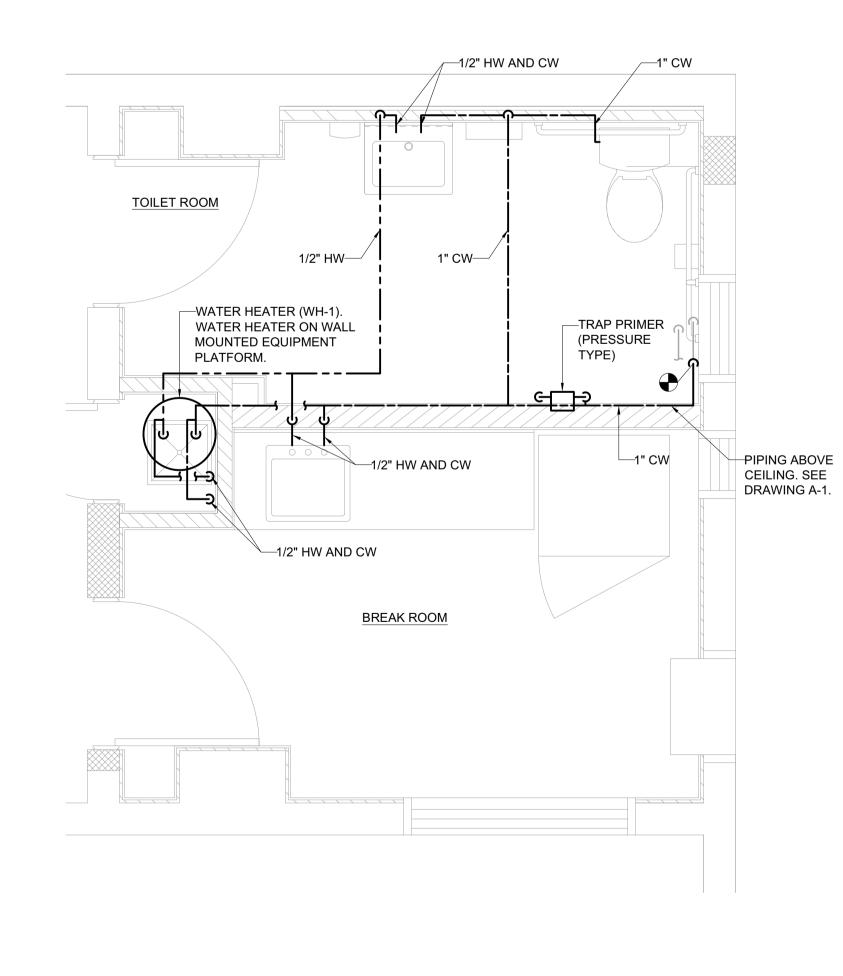

0 1 2

SCALE: 1/2" = 1'-0"


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ALTER	ATIONS TO TREASURY MOTOR POOL
	Location
BA	AYSIDE STATE PRISON 4342 NJ-47 MAURICE RIVER, NJ
	DPMC Number A1397-00
	Project Number 20520.11
	<b>Date</b> 11/03/2023
LAMME GIORGI	Alchilecture + Design
	111 Wood Ave South
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Sheet 19 of 26



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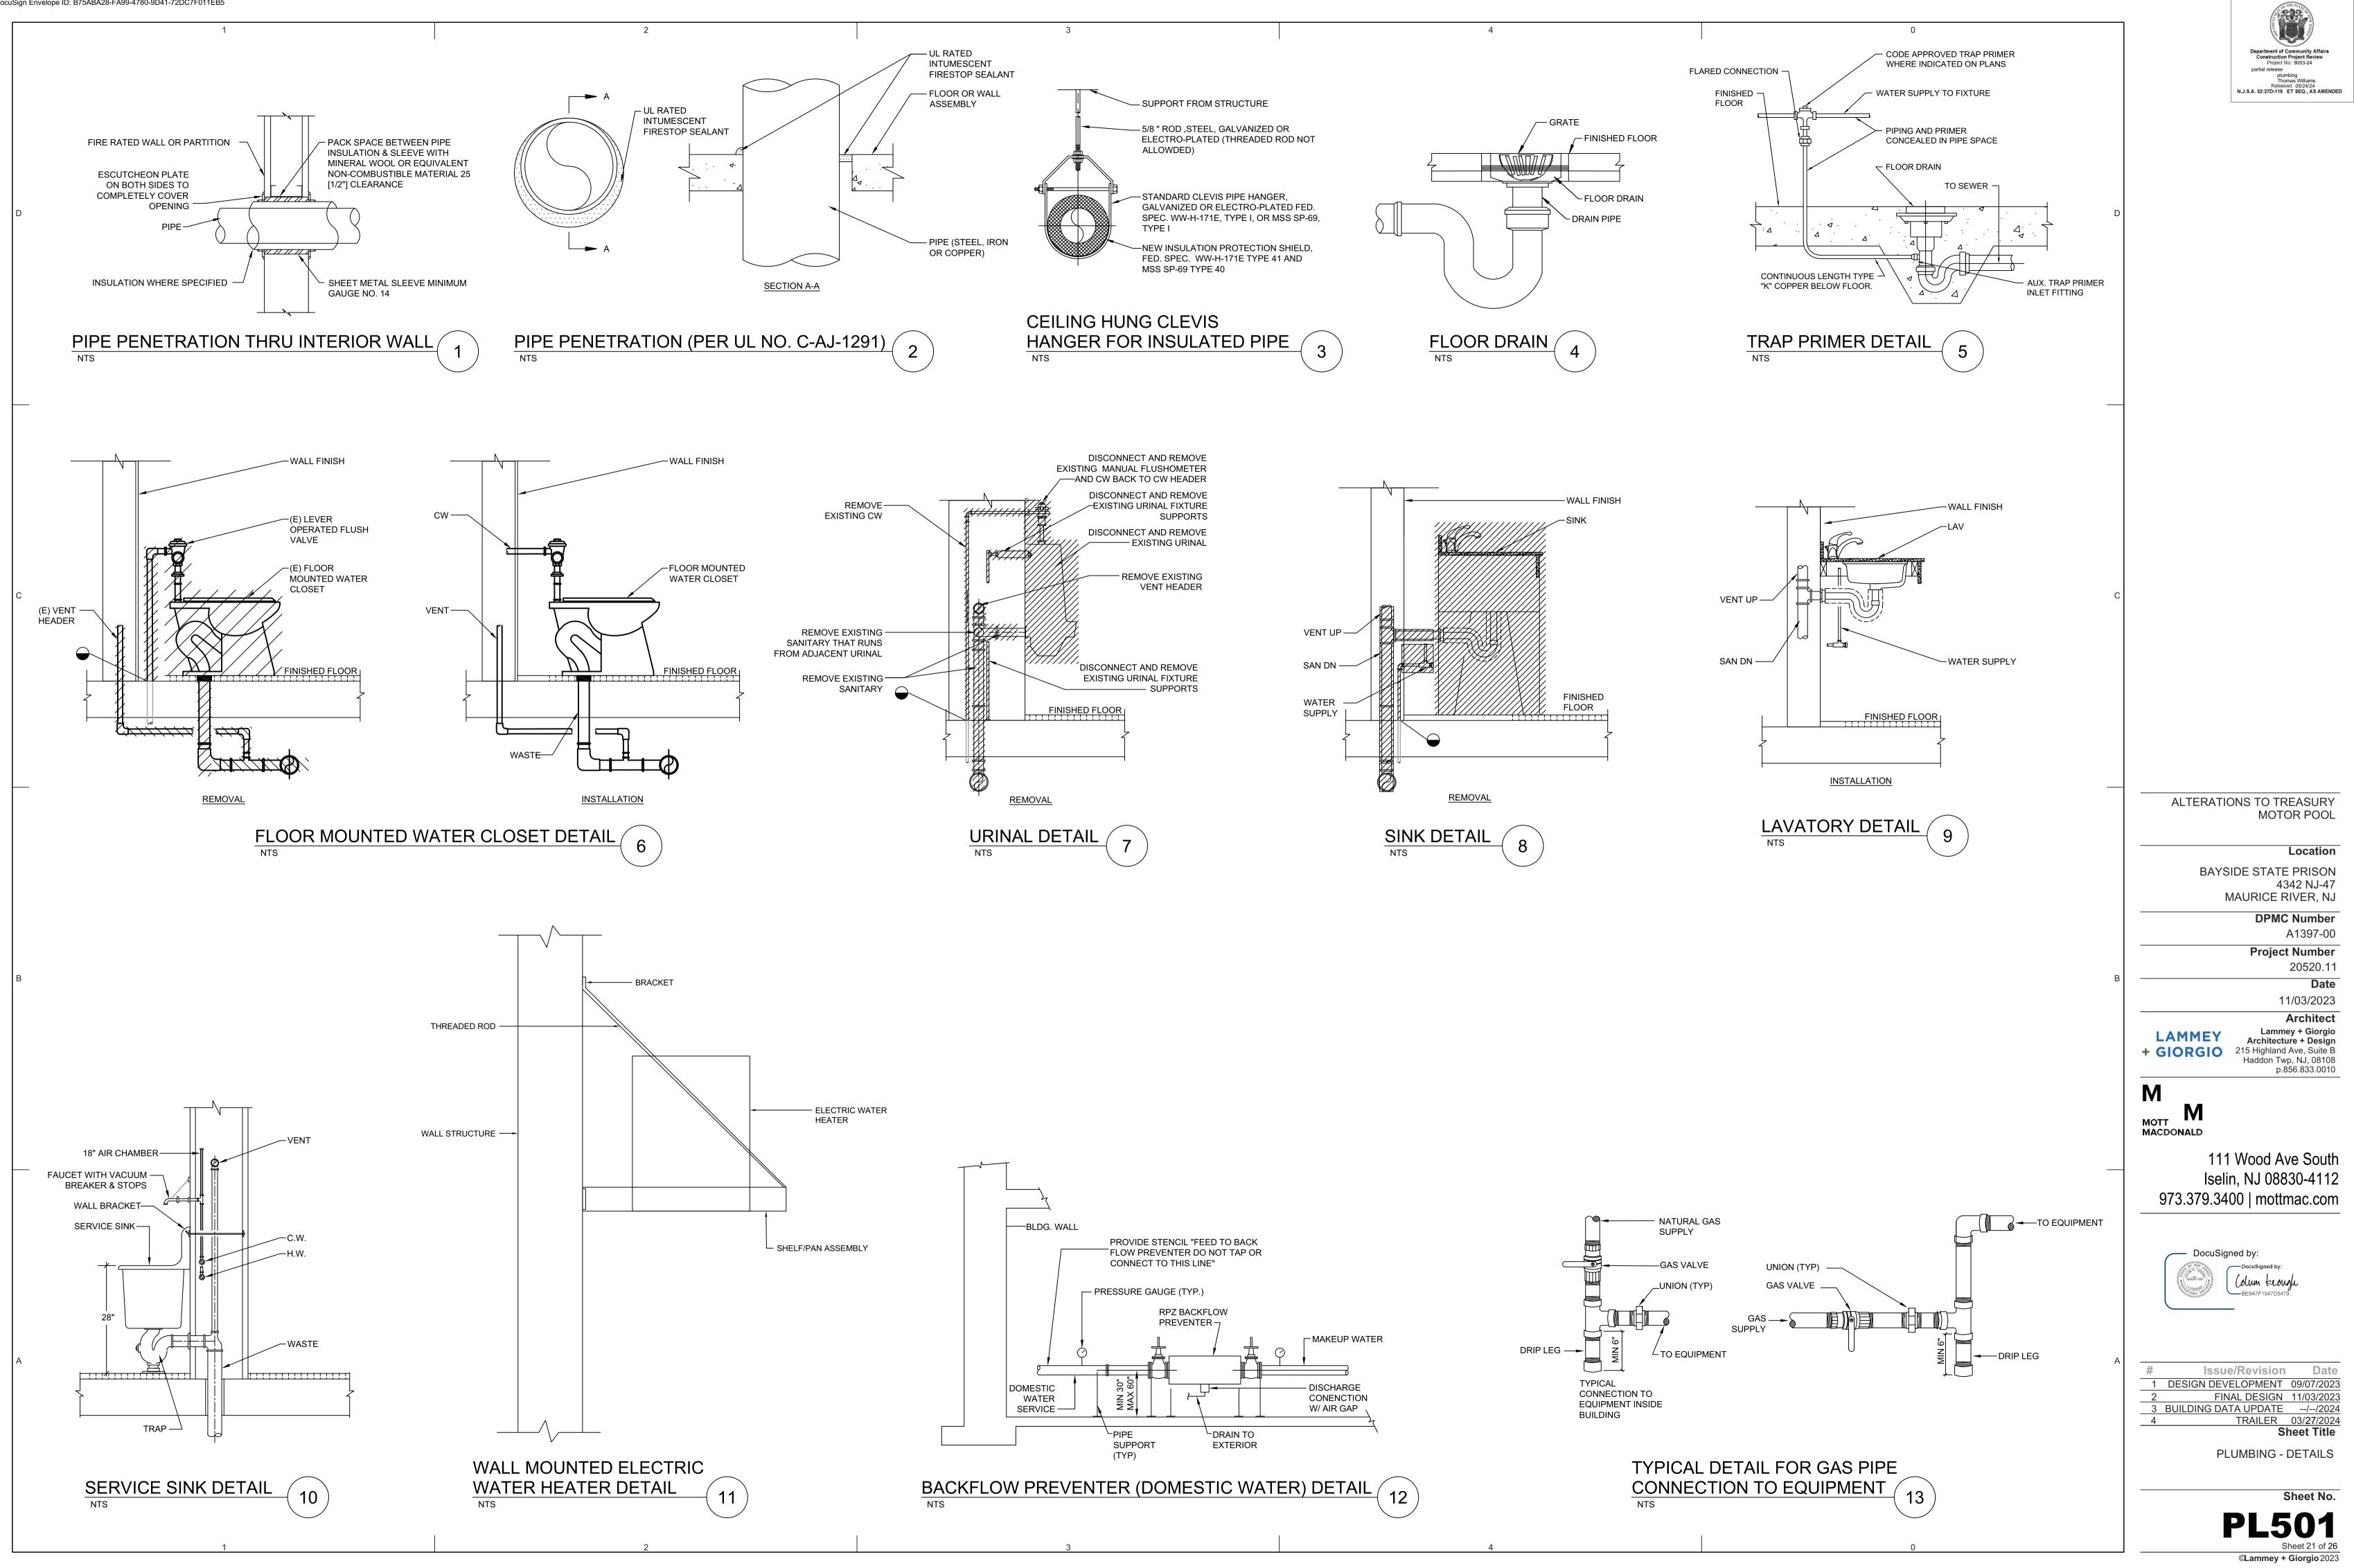





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0	Department of Community Affairs Construction Project Review Project No: 9053-24 partial release plumbing Thomas Williams Released: 05/24/24 N.J.S.A. 52:27D-119 ET SEQ., AS AMENDED
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1-1/2" NG. SEE	
DRAWING PL100	c
	B ALTERATIONS TO TREASURY MOTOR POOL Location BAYSIDE STATE PRISON 4342 NJ-47 MAURICE RIVER, NJ DPMC Number A1397-00 Project Number 20520.11 Date 11/03/2023 Architectur 103/2023 Date 11/03/2023 Architectur 103/2023 Date 11/03/2023 Date 11/03/2023 Date 11
AREA OF WORK	A Image: Section of the section of
0 SCALE: 1/2" = 1'-0"	PL102 Sheet 20 of 26 ©Lammey + Giorgio 2023

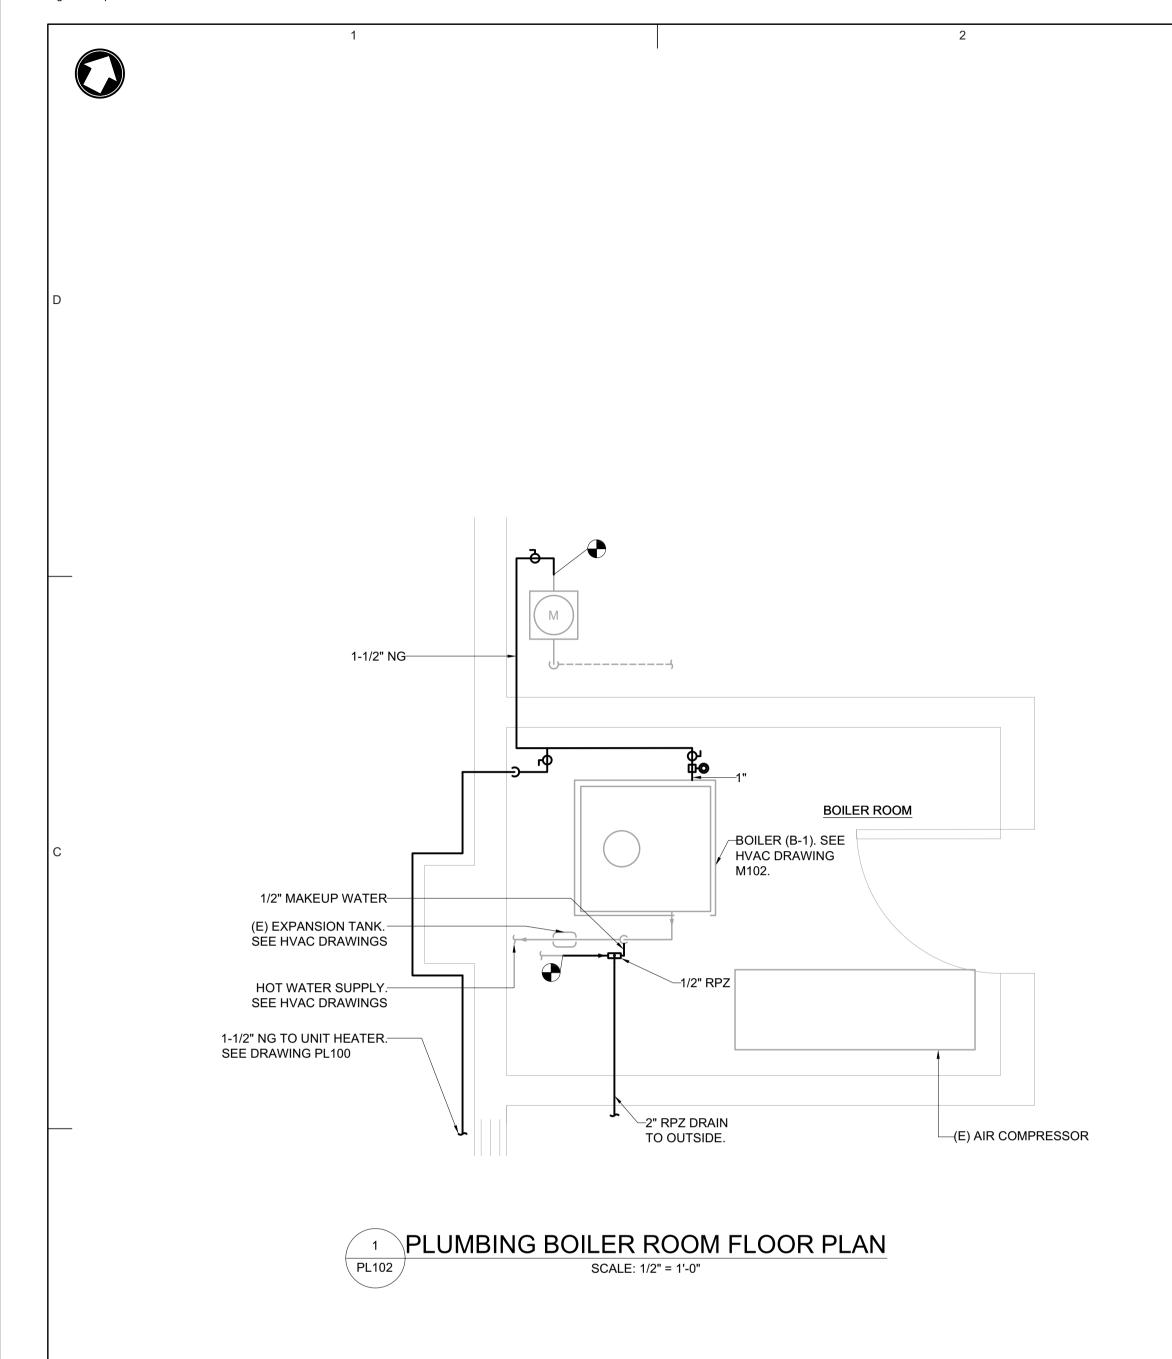




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	GENERAL ELECTRICAL NOTES		³ ABBREVIATIONS	⁴ <u>SYMBOLS</u>	EXISTING	State State
	<ul> <li>ALL WORK SHALL CONFORM TO THE REQUIREMENTS OF THE NATIONAL ELECTRICAL CODE (2020), NATIONAL ELECTRIC SAFETY CODE, N.F.P.A., O.S.H.A. REGULATIONS AND ALL OTHER</li> <li>EXISTING CODES AND REGULATIONS OF AUTHORITIES WHICH HAVE JURISDICTION.</li> </ul>		A, AMP AMPERE		NEW INSTALLATION	ISA IL CON
	2. THE CONTRACT DRAWINGS ARE DIAGRAMMATIC IN NATURE AND NOT EVERY DETAIL OR CONDUIT IS SHOWN. EXISTING CONDITIONS AND DIMENSIONS SHALL BE VERIFIED IN THE FIELD BEFORE COMMENCING ANY FABRICATION, ORDERING ANY MATERIAL, OR PERFORMING ANY WORK. ANY DEPARTURE FROM CONCEPT SHOWN ON THE CONTRACT DRAWINGS SHALL BE		ABBRABBREVIATIONSACALTERNATING CURRENTAFAMPERE FRAME		INDICATES DEMOLITION	Department of Community Affairs
	SUBMITTED TO THE ENGINEER FOR APPROVAL. ALL ELECTRICAL EQUIPMENT SHOWN ON THE DRAWINGS AND/OR REQUIRED FOR THE FULL INTEGRITY OF THE CONTRACT SHALL BE FURNISHED, INSTALLED AND CONNECTED BY THE CONTRACTOR, EXCEPT WHERE EQUIPMENT SHOWN IS IDENTIFIED AS "EXISTING" OR OTHERWISE NOTED ON THE DRAWINGS.		AFF ABOVE FINISHED FLOOR AHU AIR HANDLING UNIT AIC AVAILABLE INTERRUPTING CAPACITY		INDICATES TEMPORARY REMOVAL	Construction Project Review Project No: 9053-24
	3. UNLESS OTHERWISE NOTED, EQUIPMENT AND MATERIALS TO BE PROVIDED SHALL BEAR LISTING AND LABELING BY A NATIONALLY RECOGNIZED TESTING AGENCY WHERE SUCH STANDARD HAD BEEN ESTABLISHED FOR THAT TYPE OF EQUIPMENT/MATERIAL.		AT AMPERE TRIP AWG AMERICAN WIRE GAUGE BKR, B BREAKER			PARTIAL RELEASE ELECTRICAL David Godbolt
	4. CONTRACTOR SHALL VISIT THE PROJECT SITE AND EXAMINE AND CONFIRM EXISTING CONDITIONS. ALL CHANGES SHALL BE PRESENTED DURING SHOP DRAWING SUBMITTALS FOR ENGINEER'S APPROVAL.		C, CDT CONDUIT CKT BKR CIRCUIT BREAKER CKT(S) CIRCUIT(S)	RPB/2	HOME RUN AS INDICATED ON DRAWINGS	Released: 05/24/24 N.J.S.A. 52:27D-119 ET SEQ., AS AMENDED
D	5. CONDUITS SHALL CONTAIN AN INSULATED GROUND WIRE BONDED TO ENCLOSURES AND SIZED IN ACCORDANCE WITH THE REQUIREMENTS OF THE NEC, IF SIZE IS NOT SHOWN ON THE CONTRACT DRAWINGS.		C.O CENTRAL OFFICE CU COPPER		DISCONNECT SWITCH	
	6. THE CONTRACTOR SHALL PROVIDE CONDUIT FITTINGS, CONNECTORS, CLAMPS, HARDWARE, HANGERS, AND SUPPORTS AS NECESSARY FOR A COMPLETE INSTALLATION.		DWG(S) DRAWING(S) EA EACH	Ę	MOTOR RATED SWITCH	
	7. THE CONTRACTOR SHALL PROVIDE TAGS FOR EQUIPMENT, CONDUITS, AND CABLES THAT ARE INSTALLED UNDER THIS CONTRACT. TAG IDENTIFICATIONS SHALL BE IN ACCORDANCE WITH CONTRACT DRAWINGS. TAGS FOR CONDUITS SHALL BE AS DESCRIBED IN SPECIFICATIONS.		ELECELECTRIC, ELECTRICALEMTELECTRO-METTALIC TUBINGEM, EMERGEMERGENCY	[↓] M		
	<ul> <li>8. UNUSED OPENINGS IN CONDUITS, BOXES, DISCONNECT SWITCHES, CABINETS, AND PANEL BOARDS SHALL BE CAPPED OR PLUGGED.</li> <li>9. UPDATE EXISTING PANELBOARD DIRECTORIES TO REFLECT THE CIRCUITING IN EXISTING PANELBOARDS AFFECTED BY THIS ALTERATION.</li> </ul>		EQUIPEQUIPMENTENEXISTING IN NEW LOCATIONEPEXPLOSION PROOF	OC	WALL MOUNTED OCCUPANCY SENSOR	
	10. CONTRACTOR SHALL PROVIDE THE NECESSARY MATERIALS, LABOR AND ATTENDANCE FOR THE OPERATION OF TEMPORARY LIGHT AND CONSTRUCTION POWER AS REQUIRED DURING WORKING HOURS FOR THE ENTIRE CONSTRUCTION PERIOD.		EPOEMERGENCY POWER OFFEREXISTING TO RELOCATEE, EXISTEXISTING		WALL MOUNTED ELECTRICAL PANELBOARD OR DEVICE	
	11. CONTRACTOR SHALL MAINTAIN CONTINUITY OF ANY EXISTING CIRCUITS AFFECTED BY THIS ALTERATION. RECONNECT ALL ALTERED OR REROUTED WORK TO ITS FULLY FUNCTIONAL STATE PRIOR TO ALTERATION.		FC FAN COIL FIXT FIXTURE FL FLOOR		LIGHTING FIXTURE, AS INDICATED ON LIGHTING SCHEDULE	
	12. PROVIDE ALL NECESSARY TEMPORARY WIRING TO MAINTAIN EXISTING INSTALLATIONS WHICH MUST REMAIN IN SERVICE DURING CONSTRUCTION PERIOD.		G, GND, GRD GROUND GFI GROUND FAULT CIRCUIT INTERRUPT HP HORSEPOWER	x	X FIXTURE TYPE –	_
	<ol> <li>ALL BRANCH CIRCUITS OVER 75 FEET IN LENGTH SHALL BE RUN WITH #10 CONDUCTOR, UNLESS OTHERWISE NOTED.</li> <li>SCHEDULE ALL DISCONNECTION AND INTERRUPTIONS OF ELECTRICAL SERVICE, COMMUNICATIONS AND SUPERVISORY SYSTEMS WITH THE OWNER AND ENGINEER.</li> </ol>		IDS INTRUSION DETECTION SYSTEM J.BOX, J.B. JUNCTION BOX KVA KILOVOLT AMPERE		EMERGENCY LIGHTING FIXTURE, AS INDICATED ON LIGHTING SCHEDULE X FIXTURE TYPE	
	<ol> <li>CONTRACTORS SHALL FOLLOW ALL OWNER SITE SAFETY WORK PROCESSES AND PROCEDURES, FOR EXAMPLE, WORK PERMITS, SAFETY TASK ANALYSIES, LOCKOUT TAGOUT (LOTO), LOCK, TAG AND TRY, AND RED TAG, ETC.</li> </ol>		KW     KILOWATT       KWH     KILOWATT HOURS       KWM     KILOWATT HOUR METER	x		
	16. CONTRACTORS SHALL COORDINATE ALL WORK ACTIVITIES WITH OPERATIONS, MAINTENANCE, AND OTHER CONTRACTORS.		LTG LIGHTING LTS LIGHTS	$\bigtriangledown$	CONNECTION TO ELECTRICAL UTILITY, VOLTAGE, PHASES AS	
	17. MECHANICAL CONTROL CONTRACTOR SHALL PROVIDE CONTROL WIRING AND CONDUITS FOR HVAC EQUIPMENT ACCORDING TO SEQUENCE OF OPERATIONS PROVIDED ON MECHANICAL DRAWINGS, SPECIFICATION SECTION 230923 AND MANUFACTURER RECOMMENDATIONS.		MVOLT MULTI-VOLT N, NEUT NEUTRAL	Ι	INDICATED	
	PANEL: PP2 (E)       LOCATION: REFER TO PLANS         CKT#       BKR.       POLE       DESCRIPTION       VA       PHASE A       PHASE B       PHASE C       VA       DESCRIPTION       PC	OLE BKR. CKT#	NEC     NATIONAL ELECTRIC CODE       NFPA     NATIONAL FIRE PROTECTION ASSOCIATION       NIC     NOT IN CONTRACT	لم ع)100A 2P	CIRCUIT BREAKER	
с	1     70     2     WELDER (E)     -     -     -     OLD COMP. (E)     2	$2  30  \frac{2}{4}$	NO. NOMBER NL NIGHT LIGHT P POLE			c
	5         80         2         NEW COMP. (E)         180         180         180         RESTROOM GFI         1	1 20 6	OSHA     OCCUPATIONAL SAFETY AND HEALTH ADMINISTRATIC       PNL     PANEL       Ø,     PH, PHASE		PANELBOARD, ELECTRICAL RATINGS AS INDICATED	
	9 20 1 EXISTING LOAD		PWR     POWER       RECPT     RECEPTACLE       REF     REFERENCE			
	13     20     1     BREAK ROOM     -     I	3 60 <u>12</u> 14	RM     ROOM       RR     EXISTING PANEL TO BE REPLACED WITH NEW       SPEC     SPECIFICATION			
	15         20         1         EXISTING LOAD         -         EXISTING LOAD         1           17         20         1         EXISTING LOAD         -         -         EXISTING LOAD         1	1 20 16 1 20 18	SW     SWITCH       TBR     TO BE RELOCATED       TYP     TYPICAL		GROUND	
	19         20         1         EXISTING LOAD         -         EXISTING LOAD         1           21         20         1         EXISTING LOAD         -         -         LUNCH ROOM (E)         1	1 20 20 1 20 22	U.O.N UNLESS NOTED OTHERWISE V VOLT VA VOLT-AMPS			
	23         20         1         EXISTING LOAD         -         -         EXISTING LOAD         1           25         20         1         EXISTING LOAD         -          EXISTING LOAD         1	1 20 24 1 20 26	W WATT W WIRE(S) WP WEATHER PROOF	M	INDUCTION MOTOR	
	27         20         1         EXISTING LOAD         -         LIGHTS-OFFICE BREAKROOM (E)         1           29         20         1         EXISTING LOAD         -         -         VEEDER ROOT (E)         1	1 20 28 1 20 30	XFMR TRANSFORMER	J	JUNCTION BOX	ALTERATIONS TO TREASURY MOTOR POOL
	31       20       1       PARTS HEATER (E)       200       200       EXHAUST FANS "EF-1" & "EF-2"       1         33       20       1       PARTS AQUA-STAT (E)       1500       1500       1 20 32		CO	CARBON MONOXIDE DETECTOR	
	35         20         1         PARTS RM. HEATER (E)         1500         1500         WATER HEATER "WH-1"         2	2 20 36	REFER TO NOTE 2	1	DRAWING KEY PLAN NOTE SYMBOL	Location BAYSIDE STATE PRISON
	37         20         1         BREAK ROOM REFRIGERATOR         500         500         100         100         38 40 40		$\langle 1 \rangle$	DRAWING DEMOLITION PLAN NOTE SYMBOL	4342 NJ-47 MAURICE RIVER, NJ
	41         SPACE         -           TOTAL CONNECTED LOAD (VA) PER PHASE:         880         1600         1500	42	_	X	PLAN REFERENCE	DPMC Number A1397-00
	CONNECTED LOAD (AMPS) PER PHASE 7 13 13			E-XXX		Project Number 20520.11
В	TOTAL CONNECTED LOAD (VA): 3980 TOTAL CONNECTED LOAD (AMPS): 11					B Date 11/03/2023
	OPTIONS		PANEL: LC	LOCATION: GARAGE		Architect
	VOLTS L-L:208MAIN OVERCURRENT:100ABUS MATERIAL:CuMOUNTING:SURFVOLTS L-N:120MAIN BUS RATING:225ANEUTRAL SIZE:100%ENCLOSURE TYPE:TYPE		CKT#         BKR.         POLE         DESCRIPTION         VA           1         903	PHASE A PHASE B P 903	SPACE 2	+ GIORGIO Haddon Twp, NJ, 08108
	PHASE:         3         MINIMUM A.I.C.:         10kA         DEMAND FACTOR         1.00         GROUND:         EQUID	IPMENT	3         15         3         GAS FIRE UNIT HEATER "GUH-1"         903           5         903	903	SPACE         4           903         SPACE         6	p.856.833.0010
	WIRE: 4     NOTES:		7         20         1         SPARE           9         20         1         SPARE		SPACE     8       SPACE     10	мотт М
	<ol> <li>FURNISH AND INSTALL CIRCUIT BREAKERS, TYPE TO MATCH EXISTING</li> <li>FURNISH AND INSTALL TEMPORARY 60A, 2P CIRCUIT BREAKER FOR OUTDOOR TRAILER, UTILIZING CIRCUITS 34,36. REMOVE AND REPLACE WITH 20A,</li> </ol>		11     TOTAL CONNECTED LOAD (VA) PER PHASE:	903 903	- SPACE 12 903	MACDONALD
	2P CIRCUIT BREAKER FOR "WH-1" WHEN OUTDOOR TRAILER IS REMOVED.		CONNECTED LOAD (AMPS) PER PHASE	8 8	8	111 Wood Ave South DocuSigned bleselin, NJ 08830-4112
	LIGHTING FIXTURE SCHEDULE		TOTAL CONNECTED LOAD (VA): TOTAL CONNECTED LOAD (AMPS):	2709 8		973.379.3400   mottmac.com
	MARK LAMPS-NUMBER/TYPE VOLTAGE LOAD LUMENS TEMPERATURE CRI MOUNTING REMARKS					NEW JERSEL
	LED     NOT USED		VOLTS L-L:     208     MAIN OVERCURRENT:     40A	BUS MATERIAL:	Cu MOUNTING: SURFACE	No. — DocuSigned by:
	AE CEILING 2X2 MVOLT 25W 3000 LM 4000 K 80 RECESSED PROVIDE EMERGENCY BATTERY		VOLTS L-N:         120         MAIN BUS RATING:         100A           PHASE:         3         MINIMUM A.I.C.:         10kA	NEUTRAL SIZE: DEMAND FACTO	100%ENCLOSURE TYPE:TYPE 12R1.00GROUND:EQUIPMENT	A1233550228744E
	BE     LED     MVOLT     28W     2944 LM     4000 K     80     SURFACE     PROVIDE EMERGENCY BATTERY	Y ВАСКUР	WIRE: 4			CENSE RELEVEN
А			60A, 2P EXISTING PANELBOARD "PP2" 208/120V, 3Ph, 4W, 100A MCB			A
			3#6 , 1#10G IN 1"C			1         DESIGN DEVELOPMENT         09/07/2023           2         FINAL DESIGN         11/03/2023
		PANELBOARD "TRAILER" 120	)/240V, 1¢, 3W		3 BUILDING DATA UPDATE//2024 4 TRAILER 03/27/2024 Sheet Title	
						ELECTRICAL GENERAL NOTES, SYMBOLES, AND ABBREVIATIONS
		ті	EMPORARY TRAILER ONE-LINE DIAGRAM			Sheet No.
			NTS			E001
	1 2		3	4	0	Sheet 23 of 26

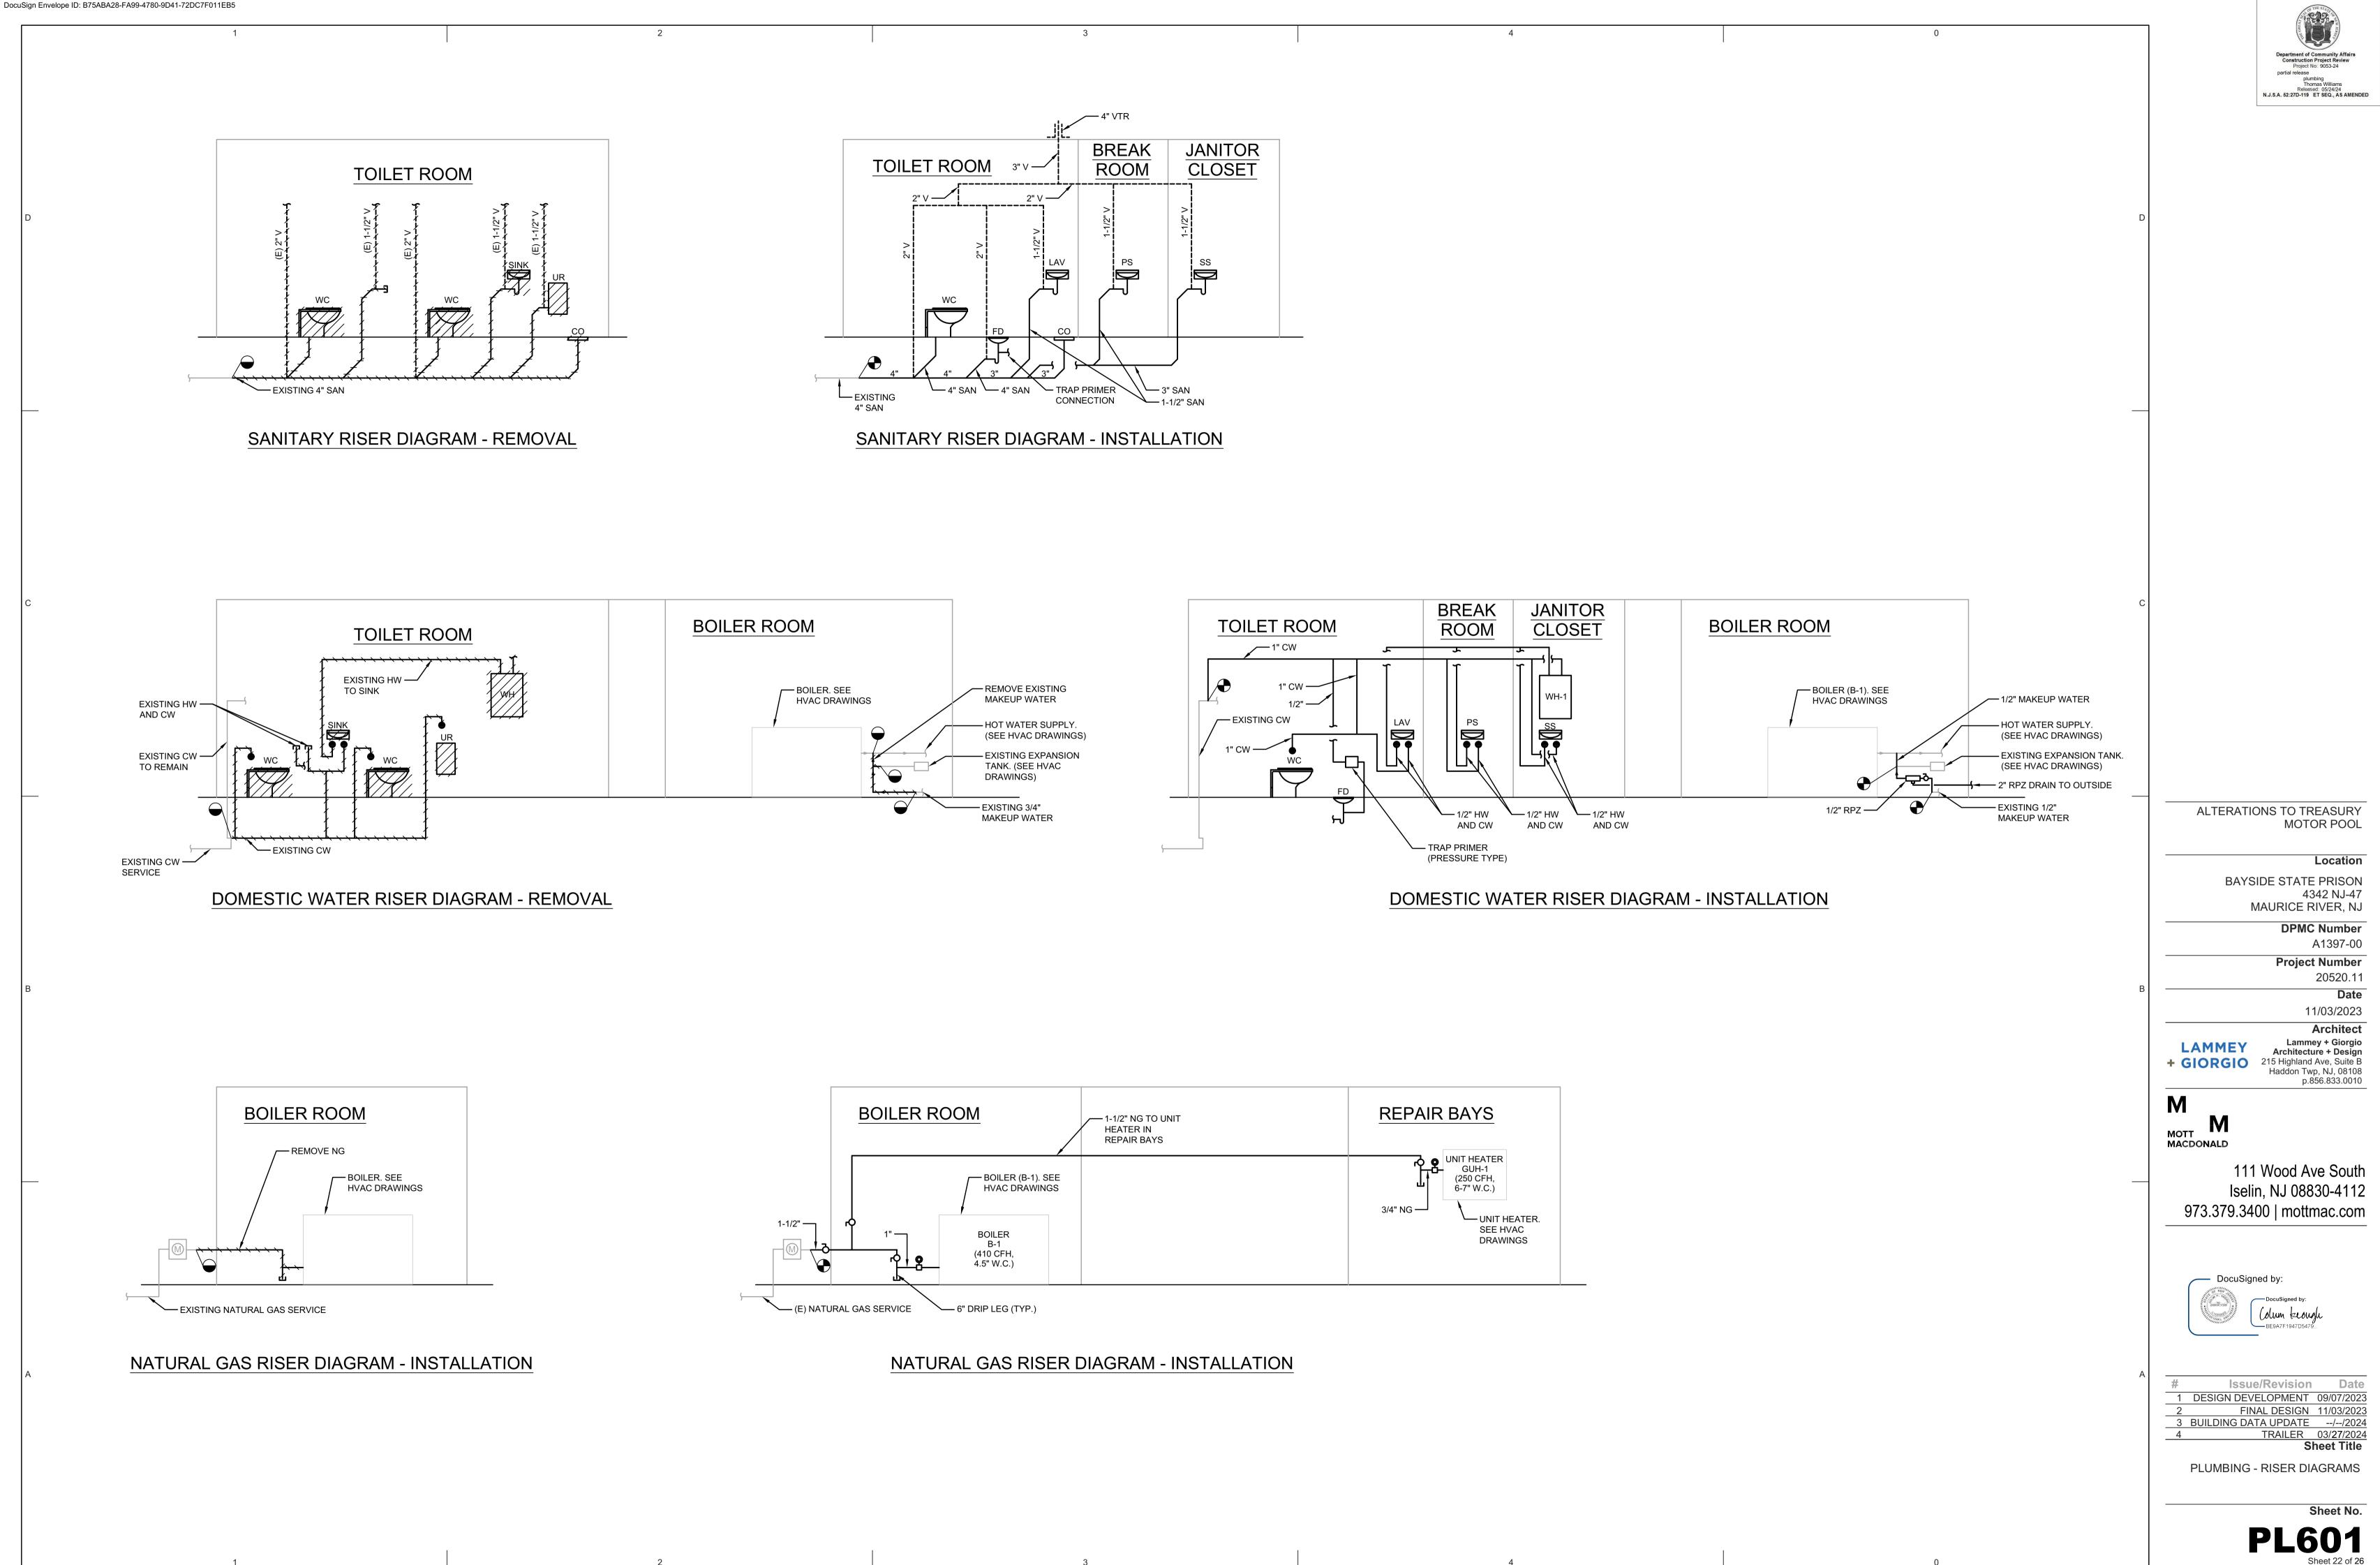
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GENERAL ELECTRICAL NOTES			2			³ ABB	REVIATIO	NS 4	SYMBOLS	EXISTING	The state of the s
ALL WORK SHALL CONFORM TO THE REQUIREMENTS OF THE NATIONAL E EXISTING CODES AND REGULATIONS OF AUTHORITIES WHICH HAVE JURK		NATIONAL ELECTRIC SAFETY	CODE, N.F.P.A., O.S.H.A. REGULATIONS AND ALL OTHER			A, AMP		AMPERE		NEW INSTALLATION	ILE CR
2. THE CONTRACT DRAWINGS ARE DIAGRAMMATIC IN NATURE AND NOT EVI BEFORE COMMENCING ANY FABRICATION, ORDERING ANY MATERIAL, OR	/ERY DETAIL OR CONDUIT IS					ABBR AC AF		ABBREVIATIONS ALTERNATING CURRENT AMPERE FRAME		INDICATES DEMOLITION	
SUBMITTED TO THE ENGINEER FOR APPROVAL. ALL ELECTRICAL EQUIPM FURNISHED, INSTALLED AND CONNECTED BY THE CONTRACTOR, EXCEPT	IENT SHOWN ON THE DRAW	VINGS AND/OR REQUIRED FO	OR THE FULL INTEGRITY OF THE CONTRACT SHALL BE			AFF AHU		ABOVE FINISHED FLOOR AIR HANDLING UNIT			Department of Community Affairs Construction Project Review Project No: 9053-24
3. UNLESS OTHERWISE NOTED, EQUIPMENT AND MATERIALS TO BE PROVID STANDARD HAD BEEN ESTABLISHED FOR THAT TYPE OF EQUIPMENT/MAT		ND LABELING BY A NATIONAL	LLY RECOGNIZED TESTING AGENCY WHERE SUCH			AIC AT AWG		AVAILABLE INTERRUPTING CAPACITY AMPERE TRIP AMERICAN WIRE GAUGE		INDICATES TEMPORARY REMOVAL	PARTIAL RELEASE ELECTRICAL
<ol> <li>CONTRACTOR SHALL VISIT THE PROJECT SITE AND EXAMINE AND CONFINE ENGINEER'S APPROVAL.</li> </ol>	RM EXISTING CONDITIONS.	ALL CHANGES SHALL BE PRI	ESENTED DURING SHOP DRAWING SUBMITTALS FOR			BKR, B C, CDT CKT BKR	R	BREAKER CONDUIT CIRCUIT BREAKER	RPB/2	HOME RUN AS INDICATED ON DRAWINGS	David Godbolt Released: 05/24/24 N.J.S.A. 52:27D-119 ET SEQ., AS AMENDED
5. CONDUITS SHALL CONTAIN AN INSULATED GROUND WIRE BONDED TO EN	NCLOSURES AND SIZED IN A	ACCORDANCE WITH THE REC	QUIREMENTS OF THE NEC, IF SIZE IS NOT SHOWN ON THE			CKT(S) C.O		CIRCUIT(S) CENTRAL OFFICE COPPER			
<ul><li>CONTRACT DRAWINGS.</li><li>6. THE CONTRACTOR SHALL PROVIDE CONDUIT FITTINGS, CONNECTORS, C</li></ul>	CLAMPS, HARDWARE, HANG	ERS, AND SUPPORTS AS NEO	CESSARY FOR A COMPLETE INSTALLATION.			DISC DWG(S)		DISCONNECT DRAWING(S)		DISCONNECT SWITCH	
7. THE CONTRACTOR SHALL PROVIDE TAGS FOR EQUIPMENT, CONDUITS, A WITH CONTRACT DRAWINGS. TAGS FOR CONDUITS SHALL BE AS DESCRI		TALLED UNDER THIS CONTRA	ACT. TAG IDENTIFICATIONS SHALL BE IN ACCORDANCE			EA ELEC EMT		EACH ELECTRIC, ELECTRICAL ELECTRO-METTALIC TUBING	\$ M	MOTOR RATED SWITCH	
8. UNUSED OPENINGS IN CONDUITS, BOXES, DISCONNECT SWITCHES, CABI		SHALL BE CAPPED OR PLUG	GGED.			EM, EME EQUIP EN	ERG	EMERGENCY EQUIPMENT EXISTING IN NEW LOCATION	OC	WALL MOUNTED OCCUPANCY SENSOR	
9. UPDATE EXISTING PANELBOARD DIRECTORIES TO REFLECT THE CIRCUITING IN EXISTING PANELBOARDS AFFECTED BY THIS ALTERATION.					EP EPO		EXPLOSION PROOF EMERGENCY POWER OFF				
10. CONTRACTOR SHALL PROVIDE THE NECESSARY MATERIALS, LABOR AND ATTENDANCE FOR THE OPERATION OF TEMPORARY LIGHT AND CONSTRUCTION POWER AS REQUIRED DURING WORKING HOURS FOR THE ENTIRE CONSTRUCTION PERIOD.				EK E, EXIST FC	Г	EXISTING TO RELOCATE EXISTING FAN COIL		WALL MOUNTED ELECTRICAL PANELBOARD OR DEVICE			
11. CONTRACTOR SHALL MAINTAIN CONTINUITY OF ANY EXISTING CIRCUITS STATE PRIOR TO ALTERATION.	AFFECTED BY THIS ALTERA	ATION. RECONNECT ALL ALTE	ERED OR REROUTED WORK TO ITS FULLY FUNCTIONAL			FIXT FL G, GND,	GRD	FIXTURE FLOOR GROUND	×	LIGHTING FIXTURE, AS INDICATED ON LIGHTING SCHEDULE X FIXTURE TYPE	
<ol> <li>PROVIDE ALL NECESSARY TEMPORARY WIRING TO MAINTAIN EXISTING IN</li> <li>ALL BRANCH CIRCUITS OVER 75 FEET IN LENGTH SHALL BE RUN WITH #10</li> </ol>			NG CONSTRUCTION PERIOD.			GFI HP IDS		GROUND FAULT CIRCUIT INTERRUPT HORSEPOWER INTRUSION DETECTION SYSTEM			
14. SCHEDULE ALL DISCONNECTION AND INTERRUPTIONS OF ELECTRICAL SI			MS WITH THE OWNER AND ENGINEER.			J.BOX, J. KVA	J.B.	JUNCTION BOX KILOVOLT AMPERE KILOWATT	×	EMERGENCY LIGHTING FIXTURE, AS INDICATED ON LIGHTING SCHEDULE X FIXTURE TYPE	
15. CONTRACTORS SHALL FOLLOW ALL OWNER SITE SAFETY WORK PROCES LOCK, TAG AND TRY, AND RED TAG, ETC.	SSES AND PROCEDURES, FO	OR EXAMPLE, WORK PERMIT	TS, SAFETY TASK ANALYSIES, LOCKOUT TAGOUT (LOTO),			KWH KWM		KILOWATT HOURS KILOWATT HOUR METER			
16. CONTRACTORS SHALL COORDINATE ALL WORK ACTIVITIES WITH OPERAT						LTG LTS MCB		LIGHTING LIGHTS MAIN CIRCUIT BREAKER	$\bigtriangledown$	CONNECTION TO ELECTRICAL UTILITY, VOLTAGE, PHASES AS	
17. MECHANICAL CONTROL CONTRACTOR SHALL PROVIDE CONTROL WIRING DRAWINGS, SPECIFICATION SECTION 230923 AND MANUFACTURER RECO PANEL: PP2 (E)	OMMENDATIONS.	C EQUIPMENT ACCORDING TO DN: REFER TO PLAN				MVOLT N, NEUT NEC	г	MULTI-VOLT NEUTRAL NATIONAL ELECTRIC CODE	•	INDICATED	
CKT# BKR. POLE DESCRIPTION		PHASE B PHASE C	VA DESCRIPTION	POLE	BKR. CKT#	NFPA NIC No.		NATIONAL FIRE PROTECTION ASSOCIATION NOT IN CONTRACT NUMBER	)100A 2P	CIRCUIT BREAKER	
1 3 70 2 WELDER (E)	-	-	OLD COMP. (E)	2	30 2 4	P OSHA		NIGHT LIGHT POLE OCCUPATIONAL SAFETY AND HEALTH ADMINISTRATION	N		с
5 7 80 2 NEW COMP. (E)	180	-	WATER HEATER (E)       180     RESTROOM GFI	1	20 6 20 8	PNL Ø,		PANEL PH, PHASE POWER		PANELBOARD, ELECTRICAL RATINGS AS INDICATED	
9201EXISTING LOAD11201EXISTING LOAD		-	GAS STATION (E)	3	10 60 12	RECPT REF		RECEPTACLE REFERENCE ROOM			
13 20 1 BREAK ROOM	-				14	RR SPEC		EXISTING PANEL TO BE REPLACED WITH NEW SPECIFICATION			
15201EXISTING LOAD17201EXISTING LOAD			EXISTING LOAD EXISTING LOAD	1	20 16 20 18	SW TBR TYP		SWITCH TO BE RELOCATED TYPICAL		GROUND	
19         20         1         EXISTING LOAD           21         20         1         EXISTING LOAD	-	-	EXISTING LOAD LUNCH ROOM (E)	1	20 20 20 22	U.O.N V VA		UNLESS NOTED OTHERWISE VOLT VOLT-AMPS			
23         20         1         EXISTING LOAD           25         20         1         EXISTING LOAD		-	EXISTING LOAD EXISTING LOAD	1	20 24 20 26	W W WP		WATT WIRE(S) WEATHER PROOF		INDUCTION MOTOR	
27 20 1 EXISTING LOAD		-	LIGHTS-OFFICE BREAKROOM (E) VEEDER ROOT (E)	1	20 28	XFMR		TRANSFORMER	J	JUNCTION BOX	ALTERATIONS TO TREASURY
29         20         1         EXISTING LOAD           31         20         1         PARTS HEATER (E)	200	-	200 EXHAUST FANS "EF-1" & "EF-2"	1	20 30 20 32	-			CO	CARBON MONOXIDE DETECTOR	MOTOR POOL
33         20         1         PARTS AQUA-STAT (E)           35         20         1         PARTS RM. HEATER (E)		1500 1500	1500 WATER HEATER "WH-1"	2	20 <u>34</u> 36	RE	EFER TO NOTE 2		(1)	DRAWING KEY PLAN NOTE SYMBOL	
37201BREAK ROOM REFRIGERATOR39201CONDENSATE PUMP "CP-1"	500 500 100	100	1ST LIFE (E)	3	38 40 40				$\langle \hat{1} \rangle$	DRAWING DEMOLITION PLAN NOTE SYMBOL	BAYSIDE STATE PRISON 4342 NJ-47 MAURICE RIVER, NJ
41 SPACE TOTAL CONNECTED LOAD (VA)		- 1600 1500			42	-			×		DPMC Number
CONNECTED LOAD (AMPS	,	13 13							E-XXX	PLAN REFERENCE	A1397-00 Project Number
TOTAL CONNECTE											в 20520.11 <b>Date</b>
TOTAL CONNECTED L	LOAD (AMPS): 11					PANEL: LC		L	LOCATION: GARAGE		11/03/2023 Architect
OPTIONS VOLTS L-L: 208 MAIN OVERCURRENT:	100A	BUS MATERIAL:	Cu MOUNTING:	SURFACE		CKT# BKR. P	POLE	DESCRIPTION VA 903	PHASE A PHASE B P 903	HASE C VA DESCRIPTION POLE BKR. CKT#	LAMMEY Lammey + Giorgio Architecture + Design 215 Highland Ave, Suite B
VOLTS L-N:120MAIN BUS RATING:PHASE:3MINIMUM A.I.C.:	225A 10kA	NEUTRAL SIZE: DEMAND FACTOR	100% ENCLOSURE TYPE: 1.00 GROUND:	TYPE 12 EQUIPME		3 15	3 G	GAS FIRE UNIT HEATER "GUH-1" 903 903	903	903 SPACE 4	+ GIORGIO 215 Highland Ave, Suite B Haddon Twp, NJ, 08108 p.856.833.0010
WIRE: 4 NOTES:						7 20	1	SPARE	-	SPACE 8	M
<ol> <li>FURNISH AND INSTALL CIRCUIT BREAKERS, TYPE TO MATCH EXISTING</li> <li>FURNISH AND INSTALL TEMPORARY 60A, 2P CIRCUIT BREAKER FOR COMPARING</li> </ol>						11	1	SPARE	-	SPACE         10           -         SPACE         12	MOTT MACDONALD
2P CIRCUIT BREAKER FOR "WH-1" WHEN OUTDOOR TRAILER IS REMO			VE AND NEI LAGE WITTIZOA,					TOTAL CONNECTED LOAD (VA) PER PHASE: CONNECTED LOAD (AMPS) PER PHASE	903         903           8         8	903 8	111 Wood Ave South
						1		TOTAL CONNECTED LOAD (VA):	2709		DocuSigned bl/selin, NJ 08830-4112 973.379.3400   mottmac.com
MARK       LAMPS-NUMBER/TYPE       VOLTAGE       LOAD       LUMENS       TEMPERATURE       CRI       MOUNTING       REMARKS							TOTAL CONNECTED LOAD (AMPS):	8		EN JERSEL	
			NOT USED			OPTIONS VOLTS L-L:	208 MAIN OVER	RCURRENT: 40A	BUS MATERIAL:	Cu MOUNTING: SURFACE	COR BONDAR
AE LED MVOLT 25W	3000 LM	4000 K	80 RECESSED PROVIDE EMERGENCY I	BATTERY BAG	СКИР	VOLTS L-N:	120 MAIN BUS	RATING: 100A	NEUTRAL SIZE:	100% ENCLOSURE TYPE: TYPE 12	DocuSigned by: Igor Bandar A1233550228744E
BE LED MVOLT 28W	2944 LM	4000 K	80 SURFACE PROVIDE EMERGENCY I	BATTERY BAG	СКИР	PHASE: WIRE:	3 MINIMUM A 4	A.I.C.: 10kA	DEMAND FACTO	R 1.00 GROUND: EQUIPMENT	A1233550228744E
								- EXISTING PANELBOARD "PP2"			SSIONAL ENG
						60A, 2P		208/120V, 3Ph, 4W, 100A MCB 3#6 , 1#10G IN 1"C			# Issue/Revision Date <u>1 DESIGN DEVELOPMENT</u> 09/07/2023
								PANELBOARD "TRAILER" 120/24	240V. 16. 3W		2         FINAL DESIGN         11/03/2023           3         BUILDING DATA UPDATE        //2024           4         TRAILER         03/27/2024
								<b>↓</b>			Sheet Title
											ELECTRICAL GENERAL NOTES, SYMBOLES, AND ABBREVIATIONS
					Ţ	EMPORARY TH	RAILER OI	NE-LINE DIAGRAM			Sheet No.
1			2			3	-	4		0	EO01 Sheet 23 of 26

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GENERAL ELECTRICAL NOTES	2			³ ABBREVIA	TIONS	⁴ <u>SYMBOLS</u>	EXISTING	STATUS STATUS
1. ALL WORK SHALL CONFORM TO THE REQUIREMENTS OF THE NATIONAL ELECTRICAL (	CODE (2020), NATIONAL ELECTRIC SAFETY COI	DE, N.F.P.A., O.S.H.A. REGULATIONS AND ALL OTHER		A, AMP	AMPERE		NEW INSTALLATION	TRO IL
<ul><li>EXISTING CODES AND REGULATIONS OF AUTHORITIES WHICH HAVE JURISDICTION.</li><li>2. THE CONTRACT DRAWINGS ARE DIAGRAMMATIC IN NATURE AND NOT EVERY DETAIL CONTRACT DRAWINGS ARE DIAGRAMMATIC IN NATURE AND NOT EVERY DETAIL CONTRACT DRAWINGS ARE DIAGRAMMATIC IN NATURE AND NOT EVERY DETAIL CONTRACT DRAWINGS ARE DIAGRAMMATIC IN NATURE AND NOT EVERY DETAIL CONTRACT DRAWINGS ARE DIAGRAMMATIC IN NATURE AND NOT EVERY DETAIL CONTRACT DRAWINGS ARE DIAGRAMMATIC IN NATURE AND NOT EVERY DETAIL CONTRACT DRAWINGS ARE DIAGRAMMATIC IN NATURE AND NOT EVERY DETAIL CONTRACT DRAWINGS ARE DIAGRAMMATIC IN NATURE AND NOT EVERY DETAIL CONTRACT DRAWINGS ARE DIAGRAMMATIC IN NATURE AND NOT EVERY DETAIL CONTRACT DRAWINGS ARE DIAGRAMMATIC IN NATURE AND NOT EVERY DETAIL CONTRACT DRAWINGS ARE DIAGRAMMATIC IN NATURE AND NOT EVERY DETAIL CONTRACT DRAWINGS ARE DIAGRAMMATIC IN NATURE AND NOT EVERY DETAIL CONTRACT DRAWINGS ARE DIAGRAMMATIC IN NATURE AND NOT EVERY DETAIL CONTRACT DRAWINGS ARE DIAGRAMMATIC IN NATURE AND NOT EVERY DETAIL CONTRACT DRAWINGS ARE DIAGRAMMATIC IN NATURE AND NOT EVERY DETAIL CONTRACT DRAWINGS ARE DIAGRAMMATIC IN NATURE AND NOT EVERY DETAIL CONTRACT DRAWINGS ARE DIAGRAMMATIC IN NATURE AND NOT EVERY DETAIL CONTRACT DRAWINGS ARE DIAGRAMMATIC IN NATURE AND NOT EVERY DETAIL CONTRACT DRAWINGS ARE DIAGRAMMATIC IN NATURE AND NOT EVERY DETAIL CONTRACT DRAWINGS ARE DIAGRAMMATIC IN NATURE AND NOT EVERY DETAIL CONTRACT DRAWINGS ARE DIAGRAMMATIC IN NATURE AND NOT EVERY DRAWINGS ARE DIAGRAMMATIC IN NATURE AND NATURE AND NATURE AND NOT EVERY DRAWINGS ARE DIAGRAMMATIC IN NATURE AND NATURE</li></ul>				ABBR AC	ABBREVIATIONS ALTERNATING CURRENT	//////	INDICATES DEMOLITION	
BEFORE COMMENCING ANY FABRICATION, ORDERING ANY MATERIAL, OR PERFORMIN SUBMITTED TO THE ENGINEER FOR APPROVAL. ALL ELECTRICAL EQUIPMENT SHOWN FURNISHED, INSTALLED AND CONNECTED BY THE CONTRACTOR, EXCEPT WHERE EQU	ON THE DRAWINGS AND/OR REQUIRED FOR T	HE FULL INTEGRITY OF THE CONTRACT SHALL BE		AF AFF AHU	AMPERE FRAME ABOVE FINISHED FLOOR AIR HANDLING UNIT			Department of Community Affairs Construction Project Review
3. UNLESS OTHERWISE NOTED, EQUIPMENT AND MATERIALS TO BE PROVIDED SHALL BE				AIC AT	AVAILABLE INTERRUPTING CAPACITY AMPERE TRIP AMERICAN WIRE GAUGE		INDICATES TEMPORARY REMOVAL	Project No: 9053-24 PARTIAL RELEASE
<ul><li>STANDARD HAD BEEN ESTABLISHED FOR THAT TYPE OF EQUIPMENT/MATERIAL.</li><li>4. CONTRACTOR SHALL VISIT THE PROJECT SITE AND EXAMINE AND CONFIRM EXISTING</li></ul>	CONDITIONS. ALL CHANGES SHALL BE PRESE	NTED DURING SHOP DRAWING SUBMITTALS FOR		BKR, B C, CDT	AMERICAN WIRE GAUGE BREAKER CONDUIT	RPB/2		ELECTRICAL David Godbolt Released: 05/24/24
ENGINEER'S APPROVAL.				CKT BKR CKT(S) C.O	CIRCUIT BREAKER CIRCUIT(S) CENTRAL OFFICE		HOME RUN AS INDICATED ON DRAWINGS	N.J.S.A. 52:27D-119 ET SEQ., AS AMENDED
<ol> <li>CONDUITS SHALL CONTAIN AN INSULATED GROUND WIRE BONDED TO ENCLOSURES A CONTRACT DRAWINGS.</li> </ol>	AND SIZED IN ACCORDANCE WITH THE REQUIR	REMENTS OF THE NEC, IF SIZE IS NOT SHOWN ON THE		CU DISC	COPPER DISCONNECT		DISCONNECT SWITCH	
6. THE CONTRACTOR SHALL PROVIDE CONDUIT FITTINGS, CONNECTORS, CLAMPS, HARE				DWG(S) EA ELEC	DRAWING(S) EACH ELECTRIC, ELECTRICAL	Ś	MOTOR RATED SWITCH	
7. THE CONTRACTOR SHALL PROVIDE TAGS FOR EQUIPMENT, CONDUITS, AND CABLES T WITH CONTRACT DRAWINGS. TAGS FOR CONDUITS SHALL BE AS DESCRIBED IN SPECI		TAG IDENTIFICATIONS SHALL BE IN ACCORDANCE		ELEC EMT EM, EMERG	ELECTRIC, ELECTRICAL ELECTRO-METTALIC TUBING EMERGENCY	́М		
<ul> <li>8. UNUSED OPENINGS IN CONDUITS, BOXES, DISCONNECT SWITCHES, CABINETS, AND PANEL BOARDS SHALL BE CAPPED OR PLUGGED.</li> <li>9. UPDATE EXISTING PANELBOARD DIRECTORIES TO REFLECT THE CIRCUITING IN EXISTING PANELBOARDS AFFECTED BY THIS ALTERATION.</li> </ul>				EQUIP EN	EQUIPMENT EXISTING IN NEW LOCATION EXPLOSION PROOF	OC	WALL MOUNTED OCCUPANCY SENSOR	
<ol> <li>9. UPDATE EXISTING PANELBOARD DIRECTORIES TO REFLECT THE CIRCUITING IN EXIST</li> <li>10. CONTRACTOR SHALL PROVIDE THE NECESSARY MATERIALS, LABOR AND ATTENDANC</li> </ol>				EP EPO ER	EXPLOSION PROOF EMERGENCY POWER OFF EXISTING TO RELOCATE		WALL MOUNTED ELECTRICAL PANELBOARD OR DEVICE	
WORKING HOURS FOR THE ENTIRE CONSTRUCTION PERIOD.				E, EXIST FC FIXT	EXISTING FAN COIL FIXTURE			
11. CONTRACTOR SHALL MAINTAIN CONTINUITY OF ANY EXISTING CIRCUITS AFFECTED B' STATE PRIOR TO ALTERATION.	THIS ALTERATION. RECONNECT ALL ALTERE	D OR REPOUTED WORK TO ITS FULLY FUNCTIONAL		FL G, GND, GRD	FLOOR GROUND	×	LIGHTING FIXTURE, AS INDICATED ON LIGHTING SCHEDULE X FIXTURE TYPE	
12. PROVIDE ALL NECESSARY TEMPORARY WIRING TO MAINTAIN EXISTING INSTALLATION		CONSTRUCTION PERIOD.		GFI HP IDS	GROUND FAULT CIRCUIT INTERRUPT HORSEPOWER INTRUSION DETECTION SYSTEM			
<ol> <li>ALL BRANCH CIRCUITS OVER 75 FEET IN LENGTH SHALL BE RUN WITH #10 CONDUCTO</li> <li>SCHEDULE ALL DISCONNECTION AND INTERRUPTIONS OF ELECTRICAL SERVICE, COM</li> </ol>		VITH THE OWNER AND ENGINEER.		J.BOX, J.B. KVA	JUNCTION BOX KILOVOLT AMPERE		EMERGENCY LIGHTING FIXTURE, AS INDICATED ON LIGHTING SCHEDULE X FIXTURE TYPE	
15. CONTRACTORS SHALL FOLLOW ALL OWNER SITE SAFETY WORK PROCESSES AND PROLOCK, TAG AND TRY, AND RED TAG, ETC.	OCEDURES, FOR EXAMPLE, WORK PERMITS, S	SAFETY TASK ANALYSIES, LOCKOUT TAGOUT (LOTO),		KW KWH KWM	KILOWATT KILOWATT HOURS KILOWATT HOUR METER	х		
16. CONTRACTORS SHALL COORDINATE ALL WORK ACTIVITIES WITH OPERATIONS, MAINT	ENANCE, AND OTHER CONTRACTORS.			LTG LTS	LIGHTING LIGHTS	$\bigtriangledown$	CONNECTION TO ELECTRICAL	
17. MECHANICAL CONTROL CONTRACTOR SHALL PROVIDE CONTROL WIRING AND CONDU DRAWINGS, SPECIFICATION SECTION 230923 AND MANUFACTURER RECOMMENDATION		EQUENCE OF OPERATIONS PROVIDED ON MECHANICAL		MCB MVOLT N, NEUT	MAIN CIRCUIT BREAKER MULTI-VOLT NEUTRAL	I	UTILITY, VOLTAGE, PHASES AS INDICATED	
PANEL: PP2 (E)	LOCATION: REFER TO PLANS			NEC NFPA	NATIONAL ELECTRIC CODE NATIONAL FIRE PROTECTION ASSOCIATION	ل ۱۵۵۸ کار ا		
CKT#     BKR.     POLE     DESCRIPTION     VA       1	PHASE A PHASE B PHASE C	VA DESCRIPTION	POLE BKR. CKT#	NIC — No. NI	NOT IN CONTRACT NUMBER NIGHT LIGHT	ې ^ر 2P	CIRCUIT BREAKER	
70         2         WELDER (E)	-		2 30 4	P OSHA	POLE OCCUPATIONAL SAFETY AND HEALTH ADMINISTRATION	ON		с
5         80         2         NEW COMP. (E)	180	WATER HEATER (E)       180     RESTROOM GFI	1 20 6 1 20 8	– Ø, PWR	PANEL PH, PHASE POWER		PANELBOARD, ELECTRICAL RATINGS AS INDICATED	
9         20         1         EXISTING LOAD           11         20         1         EXISTING LOAD	-	GAS STATION (E)	3 60 12	RECPT REF	RECEPTACLE REFERENCE			
11         20         1         EXISTING LOAD           13         20         1         BREAK ROOM			14	RM RR SPEC	ROOM EXISTING PANEL TO BE REPLACED WITH NEW SPECIFICATION			
15         20         1         EXISTING LOAD           17         20         1         EXISTING LOAD		EXISTING LOAD EXISTING LOAD	1 20 16 1 20 18	SW TBR	SWITCH TO BE RELOCATED		GROUND	
19 20 1 EXISTING LOAD	-	EXISTING LOAD	1 20 20	U.O.N	TYPICAL UNLESS NOTED OTHERWISE VOLT	_		
21         20         1         EXISTING LOAD           23         20         1         EXISTING LOAD		EXISTING LOAD	1 20 22 1 20 24	VA W	VOLT-AMPS WATT	M	INDUCTION MOTOR	
25         20         1         EXISTING LOAD           27         20         1         EXISTING LOAD	-	EXISTING LOAD LIGHTS-OFFICE BREAKROOM (E)	1 20 26	- W WP XFMR	WIRE(S) WEATHER PROOF TRANSFORMER	J	JUNCTION BOX	
27         20         1         EXISTING LOAD           29         20         1         EXISTING LOAD		VEEDER ROOT (E)	1         20         28           1         20         30	_				ALTERATIONS TO TREASURY MOTOR POOL
31         20         1         PARTS HEATER (E)           33         20         1         PARTS AQUA-STAT (E)	200 1500	200         EXHAUST FANS "EF-1" & "EF-2"           1500	1 20 32 34			CO	CARBON MONOXIDE DETECTOR	
35 20 1 PARTS RM. HEATER (E)	1500	1500 WATER HEATER "WH-1"	2 20 36	REFER TO NO	re 2		DRAWING KEY PLAN NOTE SYMBOL	Location BAYSIDE STATE PRISON
37         20         1         BREAK ROOM REFRIGERATOR         500           39         20         1         CONDENSATE PUMP "CP-1"         100	500 100	1ST LIFE (E)	3 40 <del>38</del> 3 40 40	_		$\langle 1 \rangle$	DRAWING DEMOLITION PLAN NOTE SYMBOL	4342 NJ-47 MAURICE RIVER, NJ
41 SPACE TOTAL CONNECTED LOAD (VA) PER PHASE			42	-		×		DPMC Number
CONNECTED LOAD (AMPS) PER PHASE						E-XXX	PLAN REFERENCE	A1397-00 Project Number
TOTAL CONNECTED LOAD (VA)	: 3980							20520.11
TOTAL CONNECTED LOAD (AMPS)								Date 11/03/2023
OPTIONS				CKT# BKR. POLE	DESCRIPTION VA	LOCATION: GARAGE	PHASE C VA DESCRIPTION POLE BKR. CKT#	Architect LAMMEY Lammey + Giorgio Architecture + Design
VOLTS L-L:208MAIN OVERCURRENT:100AVOLTS L-N:120MAIN BUS RATING:225A	BUS MATERIAL:	Cu MOUNTING: 100% ENCLOSURE TYPE:	SURFACE TYPE 12	1	903	903	SPACE 2	+ GIORGIO + BIORGIO + BIORGIO LAMMEY + GIORGIO Lammey + Glorgio Architecture + Design 215 Highland Ave, Suite B Haddon Twp, NJ, 08108 p.856.833.0010
VOLTS L-N:         120         MAIN BUS RATING:         225A           PHASE:         3         MINIMUM A.I.C.:         10kA	NEUTRAL SIZE: DEMAND FACTOR	100%ENCLOSURE TYPE:1.00GROUND:	EQUIPMENT	3 15 3 5	GAS FIRE UNIT HEATER "GUH-1" 903 903	903	SPACE         4           903         SPACE         6	
WIRE: 4 NOTES:				7 20 1	SPARE	-	SPACE 8	
1. FURNISH AND INSTALL CIRCUIT BREAKERS, TYPE TO MATCH EXISTING				9 20 1 11 1	SPARE	-	SPACE         10           -         SPACE         12	MOTT MACDONALD
2. FURNISH AND INSTALL TEMPORARY 60A, 2P CIRCUIT BREAKER FOR OUTDOOR TR 2P CIRCUIT BREAKER FOR "WH-1" WHEN OUTDOOR TRAILER IS REMOVED.	AILER, UTILIZING CIRCUITS 34,36. REMOVE A	ND REPLACE WITH 20A,			TOTAL CONNECTED LOAD (VA) PER PHASE: CONNECTED LOAD (AMPS) PER PHASE	903 903	903	111 Wood Ave South
								DocuSigned bl/selin, NJ 08830-4112
	LIGHTING FIXTURE SCHEDULE				TOTAL CONNECTED LOAD (VA): TOTAL CONNECTED LOAD (AMPS):			973.379.3400   mottmac.com
MARK LAMPS-NUMBER/TYPE VOLTAGE LOAD L	UMENS TEMPERATURE CRI	MOUNTING	REMARKS					BOA
		NOT USED		OPTIONS VOLTS L-L: 208 MAI	N OVERCURRENT: 40A	BUS MATERIAL:	Cu MOUNTING: SURFACE	No.
AE LED MVOLT 25W 3	3000 LM 4000 K 80	RECESSED PROVIDE EMERGENC	( BATTERY BACKUP		N BUS RATING: 100A	NEUTRAL SIZE:	100%ENCLOSURE TYPE:TYPE 12DR1.00GROUND:EQUIPMENT	7 GE05050300 Isor Bondar A1233550228744E
BE LED MVOLT 28W 2	2944 LM 4000 K 80	SURFACE PROVIDE EMERGENC	/ BATTERY BACKUP	PHASE: 3 MIN WIRE: 4	IMUM A.I.C.: 10kA	DEMAND FACTO	DR 1.00 GROUND: EQUIPMENT	A1233550228744E
	I	I						SSIONAL ENGL
				60A, 2P	EXISTING PANELBOARD "PP2" 208/120V, 3Ph, 4W, 100A MCB			A # Issue/Revision Date
					3#6 , 1#10G IN 1"C			1         DESIGN DEVELOPMENT         09/07/2023           2         FINAL DESIGN         11/03/2023
					PANELBOARD "TRAILER" 120	)/240V, 1¢, 3W		<u>3 BUILDING DATA UPDATE//2024</u> <u>4 TRAILER 03/27/2024</u>
					圭			Sheet Title ELECTRICAL GENERAL NOTES,
								SYMBOLES, AND ABBREVIATIONS
			Ţ		R ONE-LINE DIAGRAM			Sheet No.
			_	N	ſS			E001
1	2			3		4	0	Sheet 23 of 26

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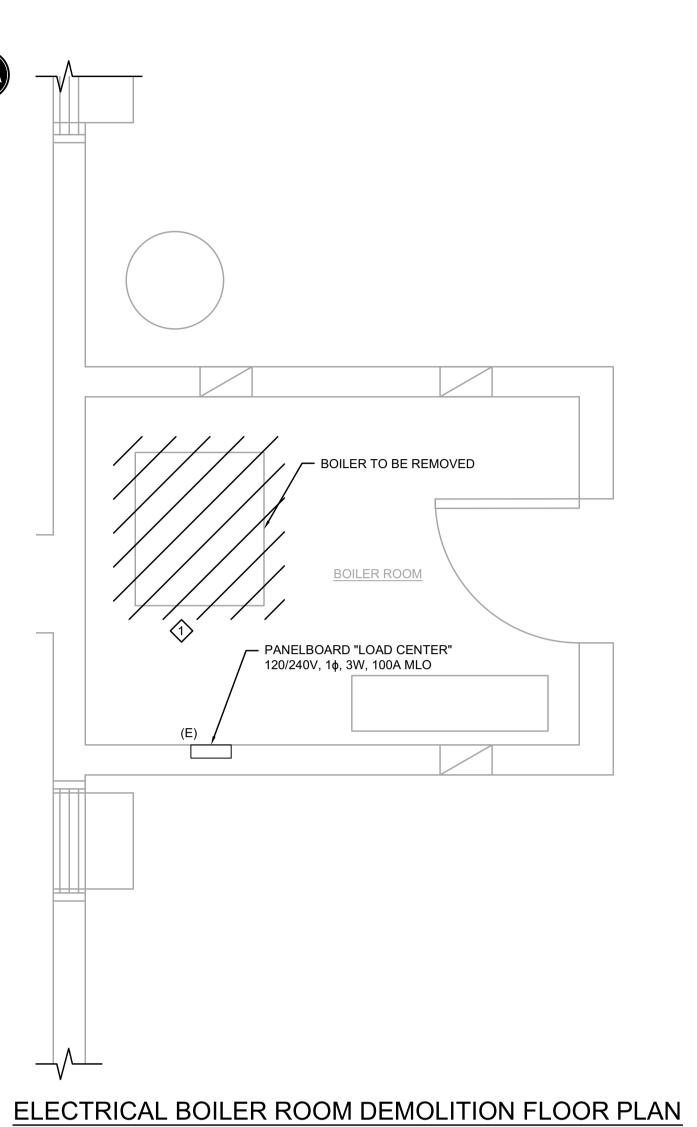

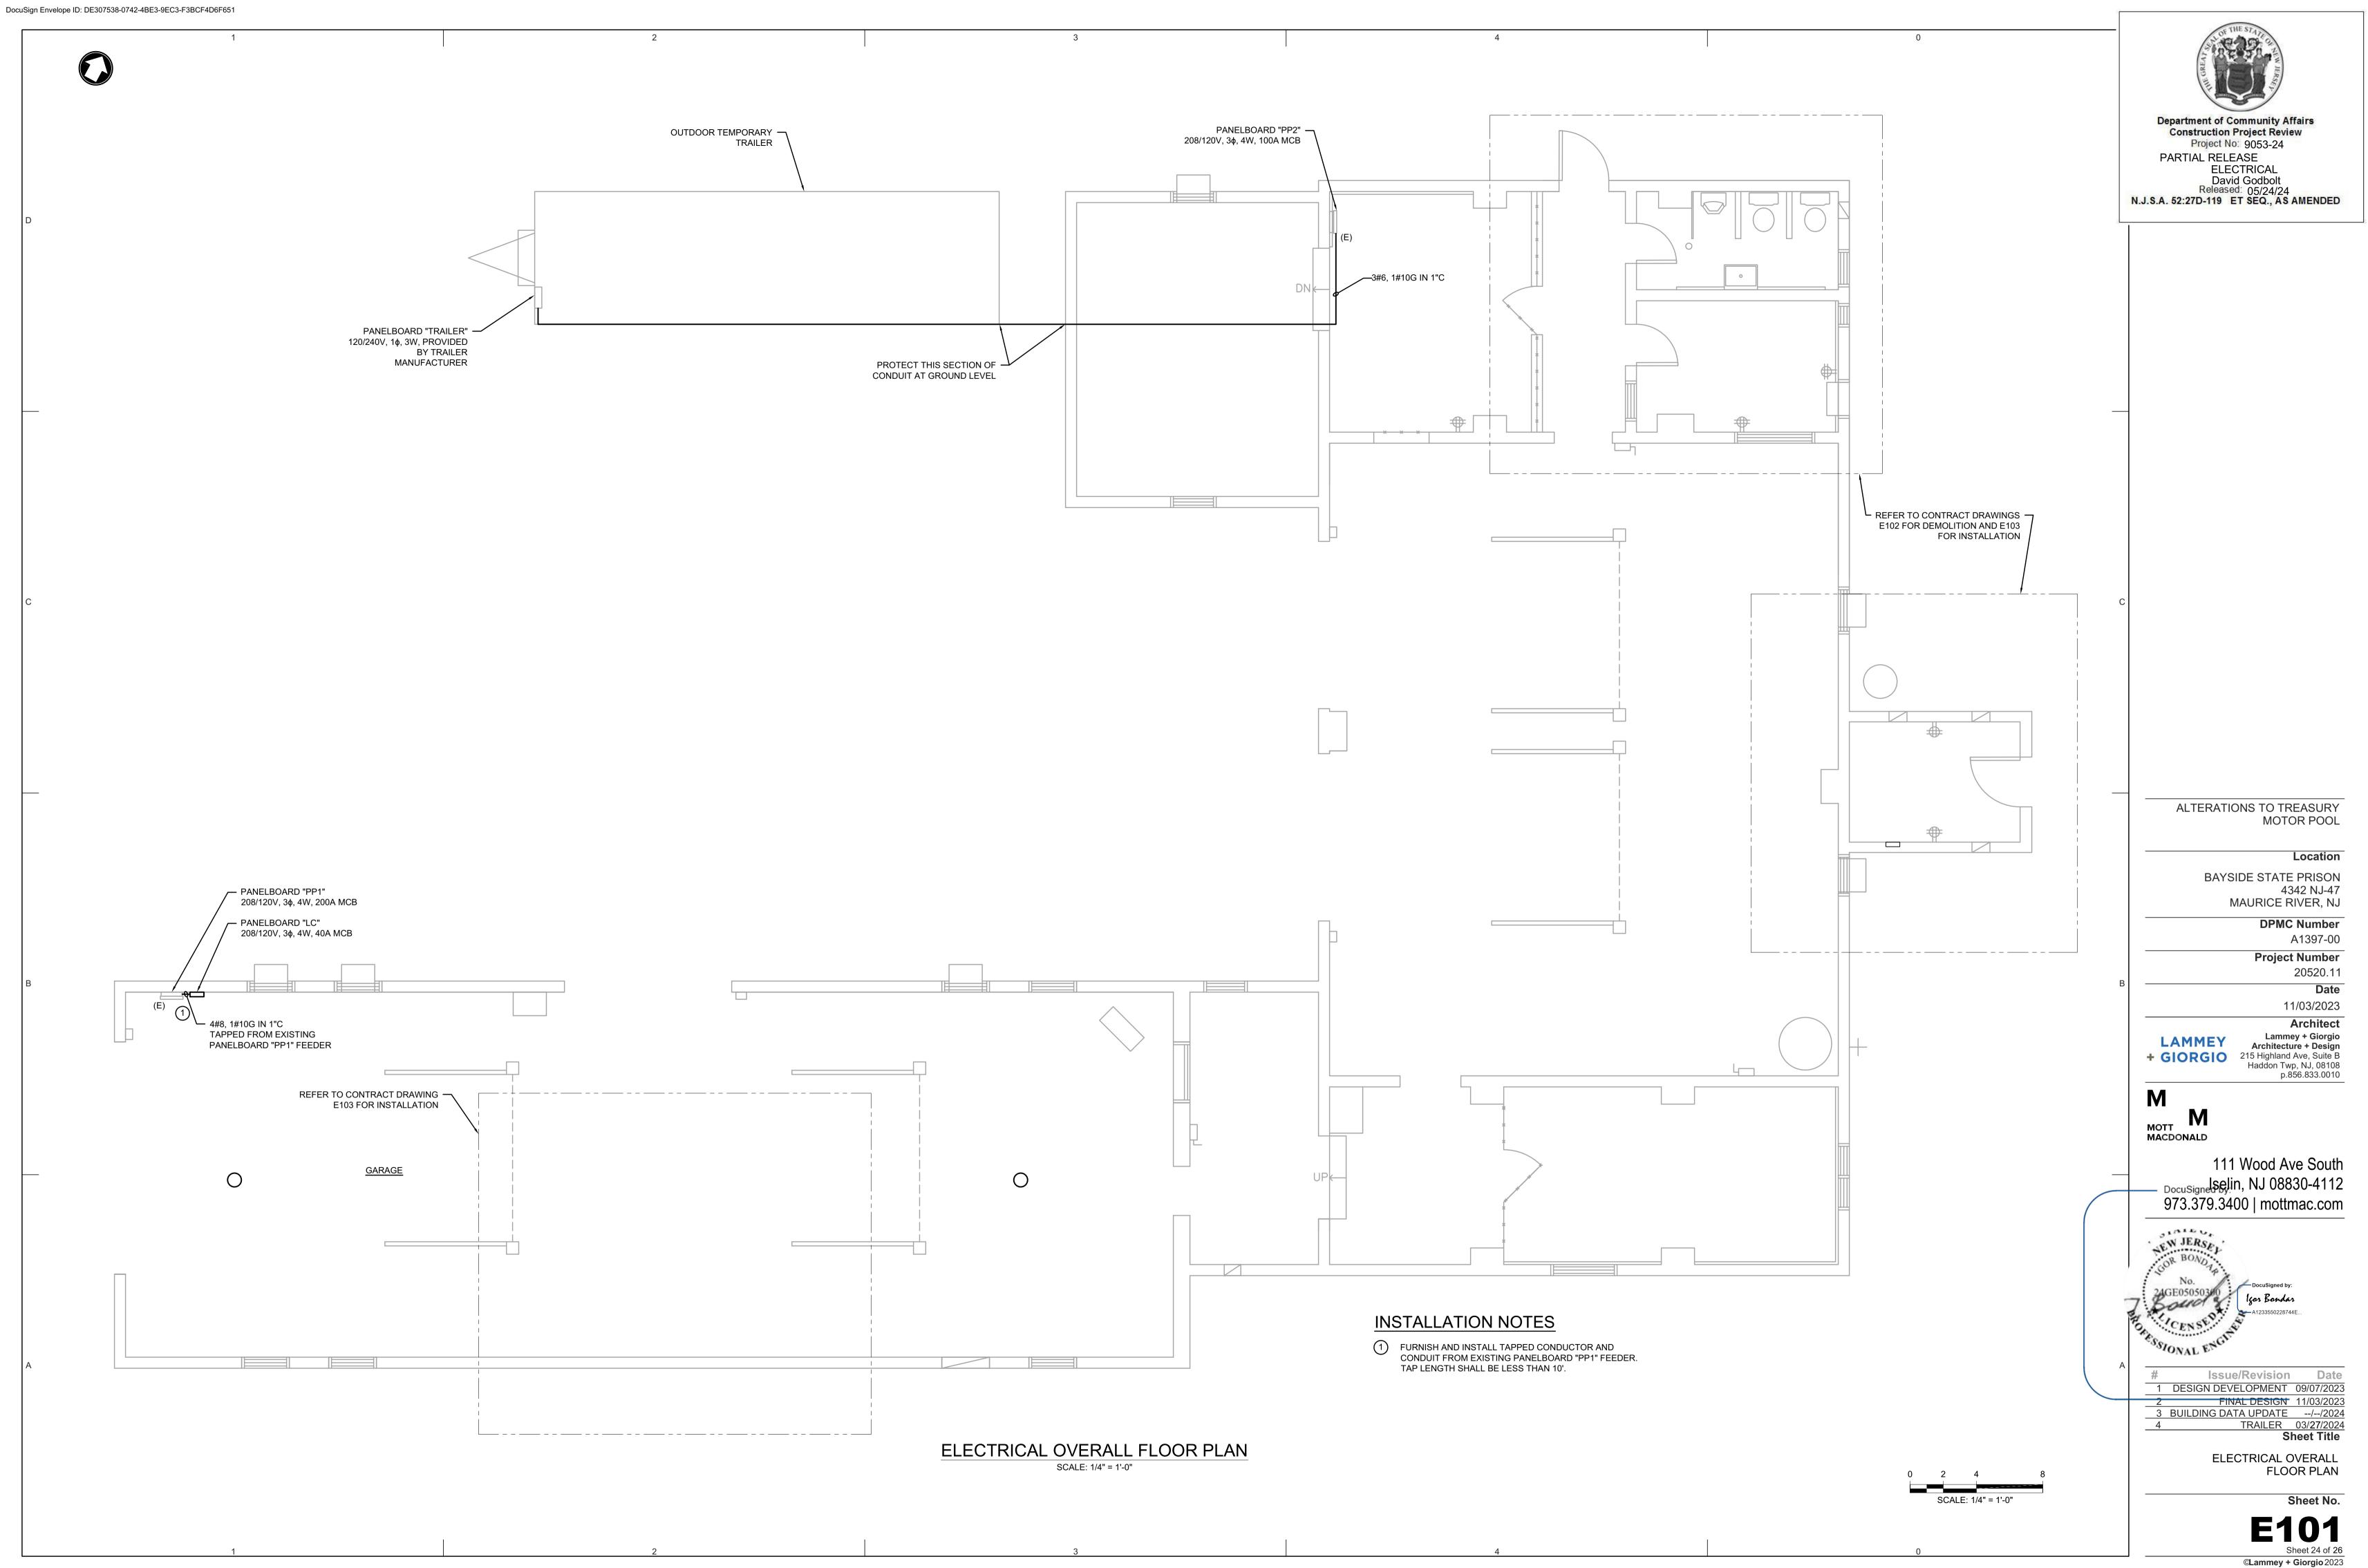
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## DEMOLITION NOTES

- DISCONNECT AND REMOVE EXISTING POWER RECEPTACLES AND LIGHT SWITCHES. CAP AND PRESERVE CONDUIT AND WIRING FOR FUTURE USE.
- DISCONNECT AND REMOVE EXISTING EXHAUST FAN AND EXISTING DATA RECEPTACLES AND ALL ASSOCIATED CONDUIT AND WIRING.
- DISCONNECT AND REMOVE EXISTING EXTERIOR LIGHT FIXTURE. CAP AND PRESERVE CONDUIT AND WIRING FOR FUTURE USE.

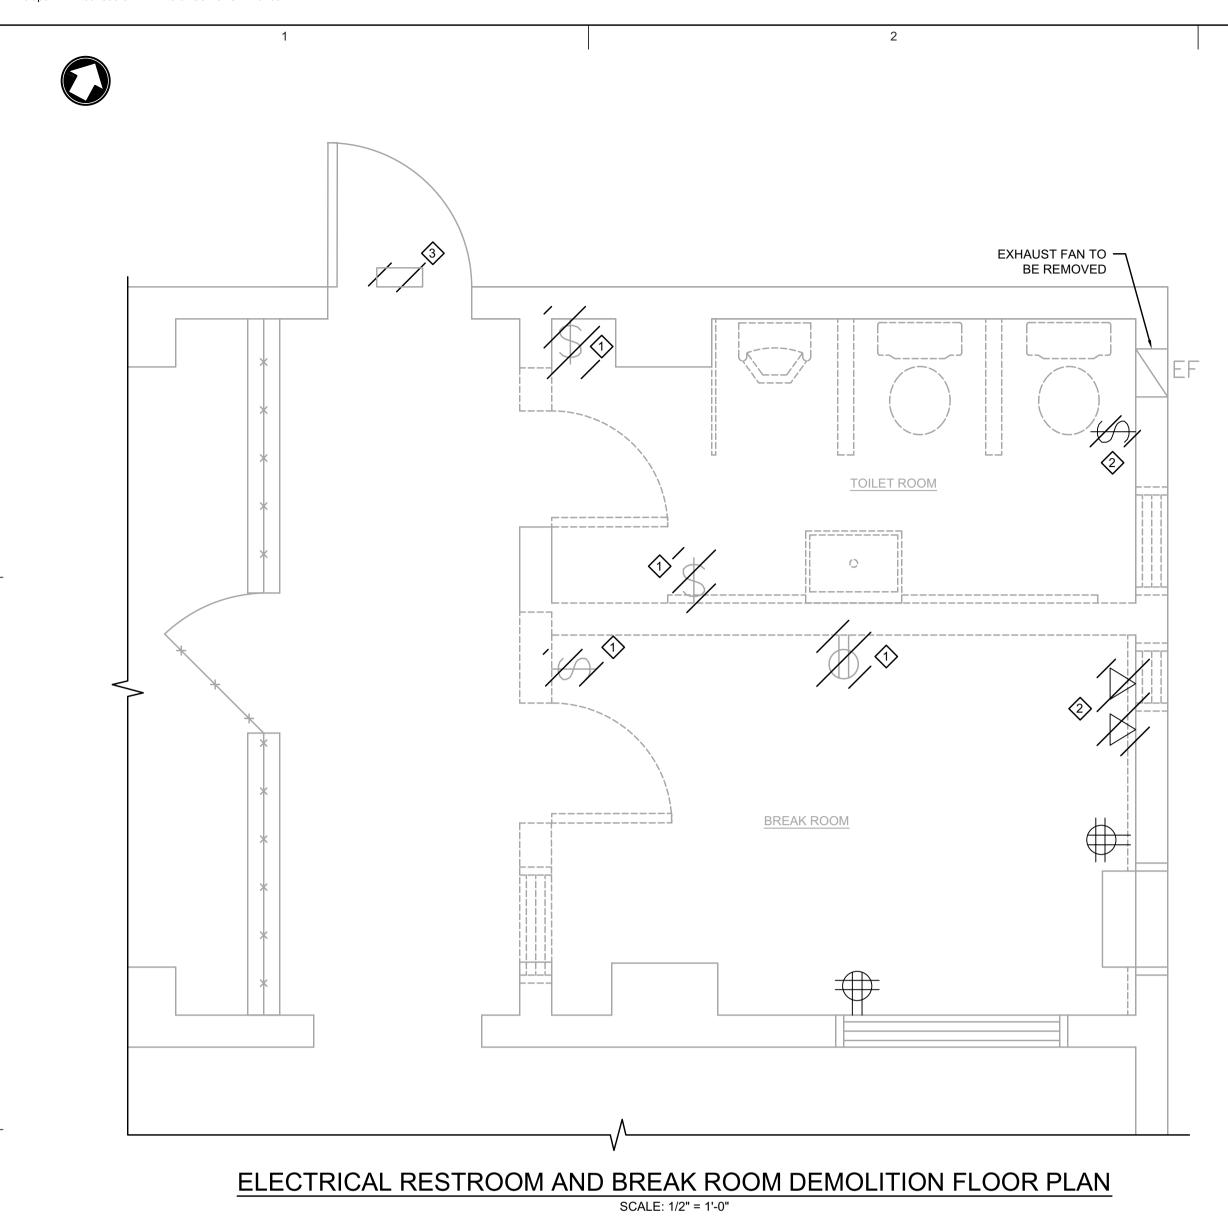

4

DEMOLITION NOTES

3

DISCONNECT AND REMOVE EXISTING BOILER AND ALL ASSOCIATED CONDUIT AND WIRING BACK TO EXISTING PANELBOARD "LOAD CENTER." PRESERVE EXISTING CIRCUIT BREAKER FOR FUTURE USE.

SCALE: 1/2" = 1'-0"

	Department of Community Affairs Construction Project Review Project No: 9053-24 PARTIAL RELEASE ELECTRICAL David Godbolt Released: 05/24/24 N.J.S.A. 52:27D-119 ET SEQ., AS AMENDED
С	
В	ALTERATIONS TO TREASURY MOTOR POOL Location BAYSIDE STATE PRISON 4342 NJ-47 MAURICE RIVER, NJ DPMC Number A1397-00 Date 20520.11 Date 11/03/2023 Architect Lammey + Giorgio Architecture + Design 215 Highland Ave, Suite B Haddon Twp, NJ, 08108 2.856.833.0010
A	M       Note         Mote       Note         Macconald       111 Wood Ave South         Selin, NJ 08830-4112       DocuSigned by         Mote       Macconald         Mote       Macconald         Macconald       Macconald         Macconald <t< td=""></t<>
	ELECTRICAL ENLARGED DEMOLITION PLANS

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SCALE: 1/2" = 1'-0"

